WATER TOWER LICENSE AGREEMENT

This Water Tower License Agreement ("**Agreement**") is made as of the date of the last signature below ("**Effective Date**") between the City of West Allis, having a mailing address of City Hall, 7525 West Greenfield Avenue, West Allis, WI 53214 ("**West Allis**"), and Verizon Wireless Personal Communications LP, a Delaware limited partnership, d/b/a Verizon Wireless, with its principal offices at One Verizon Way, Mail Stop 4AW100, Basking Ridge, New Jersey 07920 (telephone number 866-862-4404) ("**Verizon**"). West Allis and Verizon are collectively referred to as "**Parties**" and individually as "**Party**."

RECITALS

- A. The Parties, and/or their predecessors in interest, entered into a Water Tower Lease Agreement dated May 10, 1996 ("Lease").
- B. West Allis owns property located at 11515 West Rogers Street, West Allis, WI 53227 ("**Property**") on which West Allis maintains a water tower ("**Tower**"). The Lease authorizes Verizon to place certain telecommunications equipment on the Tower and a shelter and certain telecommunications equipment on a portion of ground space near the base of the Tower ("**Verizon's Existing Facilities**").
- Verizon desires to upgrade and modify its existing Antenna Facilities ("Initial Modification"), subject to the terms of this Agreement.
- D. The current term of the Lease shall expire on May 9, 2022, and the Parties intend that this Agreement supersede and replace the Lease, and, to accomplish the same, hereby terminate the Lease and the easements described therein as of the Effective Date of this Agreement.

AGREEMENT

The Parties agree as follows:

ARTICLE 1: LICENSE GRANTED

- 1.1 Subject to the provisions of this Agreement, West Allis hereby grants Verizon:
 - 1.1.1 A revocable, non-exclusive license authorizing Verizon to install, maintain, upgrade, and operate Verizon's equipment (collectively, the "Antenna Facilities") as shown on the as-built drawings required under Article 6 ("As-Built Drawings") on the specific locations on the Tower ("Tower Space") as shown on the As-Built Drawings.
 - 1.1.2 A revocable, non-exclusive license authorizing Verizon to install, maintain, upgrade, and operate one equipment building on an approximately 120 square -foot portion of the Property (the "Land Space"). The Property and the Land Space are legally described on Exhibit A-1.

- 1.1.3 A revocable, non-exclusive license authorizing Verizon to use the following "Easements": (i) an 11-foot-wide non-exclusive access—easement allowing pedestrian and vehicular ingress and egress-to the Land Space and the base of the Tower and (ii) a 5-foot-wide non-exclusive utility easement and a 5-foot-wide cable easement for the underground installation and maintenance of utility wires, cables, conduits, and pipes. Exhibit A-1 contains a legal description of each Easement. West Allis agrees to provide alternate utility easements, if necessary, and Exhibit A-1 shall be updated accordingly.
- 1.2 At its expense, Verizon shall provide a professional site survey, which shall include legal descriptions for and depict the boundaries of the Property, Land Space, and Easements and which shall be subject to West Allis's reasonable approval. The site survey shall be attached as Exhibit A-2.
- 1.3 The Tower Space and Land Space are collectively referred to as the "**Premises**."
- 1.4 The Antenna Facilities, the equipment building and its contents, and all of Verizon's appurtenant facilities are collectively referred to as the "Communications Facilities." The Communications Facilities shall be identified on the As-Built Drawings.
- 1.5 During any power interruption at the Premises, Verizon shall be permitted at any time during the Term, as defined in Section 2.4, to install, maintain, and/or provide access to and use of, as necessary, a temporary power source and all related equipment and appurtenances within the Premises, or elsewhere on the Property in such locations as approved by West Allis in its sole discretion at the time of installation. Verizon shall have the right to install conduits connecting the temporary power source and related appurtenances to the Premises. Such back up power source shall not be diesel-powered.

ARTICLE 2: TERM

- 2.1 The "**Initial Term**" of this Agreement shall commence on the Effective Date and shall terminate on the fifth anniversary of the Effective Date.
- 2.2 Provided that Verizon is not then in default beyond all applicable notice, cure, and grace periods under this Agreement at the end of the Initial Term or any Renewal Term, this Agreement shall automatically be extended for four additional five-year terms (each a "Renewal Term") unless Verizon terminates the Agreement at the end of the then-current Term by giving West Allis written notice of its intent to terminate at least 120 days prior to the expiration of the then-current Term.
- 2.3 If, at least 120 days prior to the end of the fourth and final five-year Renewal Term, neither Party has given the other Party written notice of its desire that the Agreement terminate at the end of that final Renewal Term, then this Agreement shall continue in force upon the same covenants, terms, and conditions until terminated by either Party by giving to the other Party at least one year's prior written notice of its intention to so terminate this Agreement.
- 2.4 The Initial Term, each Renewal Term, and all other extensions of this Agreement under Section 2.3 shall be referred to collectively as the "**Term**."

ARTICLE 3: LICENSE FEE

- 3.1 Commencing on the Effective Date, the annual "License Fee" amount shall be \$35,000.00, which shall be adjusted annually according to Section 3.2. The License Fee shall be payable to West Allis at its address for notice under Article 15 in advance in equal monthly installments of \$2,916.67 commencing on the Effective Date and on the first of each month thereafter. The License Fee for any partial month will be prorated. In addition to the annual payment under this paragraph, Verizon shall also pay a one-time commencement fee of \$15,000 representing full reimbursement to West Allis for any and all fees, professional expenses, reimbursements, and payments required in the Initial Modification, and exclusive of any prior payments or deposits made, which shall be due and payable within sixty (60) days of the full execution of this Agreement by the parties and which shall be non-refundable. This payment shall extinguish West Allis's authority exclusive of this Agreement to collect and assess any further fees, professional expenses, reimbursements, and payments against Licensee for the Initial Modification.
- 3.2 During the entire Term, the annual License Fee amount shall increase 3 percent over the License Fee in effect the immediately preceding year. Such increase shall be made and adjusted on each anniversary of the Effective Date.
- 3.3 In the event Verizon fails to pay any sums owed to West Allis under this Agreement when due, Verizon shall pay to West Allis a late fee on the total payment due of 1 percent per month.

ARTICLE 4: <u>DISCLAIMERS</u>

- 4.1 Verizon acknowledges and agrees that, in accepting this Agreement, West Allis has made no representations or warranties, express or implied, regarding:
 - 4.1.1 The physical condition of the Property or Premises,
 - 4.1.2 The suitability of the Property, Premises, or Easements for Verizon's desired purposes, or
 - 4.1.3 The state of title of the Property.
- 4.2 Verizon acknowledges and agrees that:
 - 4.2.1 Verizon is experienced in land acquisition and premises development,
 - 4.2.2 Verizon has conducted or will conduct all necessary and appropriate inspections of the Property, and
 - 4.2.3 Verizon accepts the Property (including the Premises), all structures on the Property, and the Easements in "as-is. where-is and with all faults" condition.
- 4.3 West Allis makes no warranties or representations regarding Verizon's exclusive use of the Property or noninterference with Verizon's transmission operations or that the

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Premises, Easements, or utilities serving the Premises are fit for Verizon's intended use, and all such warranties and representations are hereby disclaimed.

ARTICLE 5: TAXES/NO LIENS

- 5.1 Verizon shall have the responsibility to pay any personal property taxes, assessments, or charges owed on the Property that are the result of Verizon's use of the Premises and/or the installation, maintenance, and operation of Verizon's Communications Facilities. Verizon shall be responsible for the payment of all taxes, levies, assessments, and other charges imposed upon the business conducted by Verizon at the Property.
- 5.2 Verizon shall have the right, at its sole cost and expense, to appeal, challenge, or seek modification of any tax assessment or billing for which Verizon is wholly or partly responsible to pay.
- 5.3 Verizon shall not permit any claim or lien to be placed against any part of the Property or Tower that arises out of work, labor, material, or supplies provided or supplied to Verizon, its contractors, or their subcontractors for the installation, construction, operation, maintenance, or removal of the Communications Facilities or use of the Premises or Property. Upon 30 days' prior written notice from West Allis, Verizon shall cause any such claim or lien filed by any third party making a claim against, through, by, or under Verizon, to be discharged by bonding or letter of credit to give West Allis security to protect West Allis's interests from the claim or lien. If Verizon elects to obtain a bond, it will be with a company authorized to provide bonds in Wisconsin.

ARTICLE 6: <u>USE/INSTALLATION/APPROVALS/MODIFICATIONS</u>

- 6.1 <u>Use.</u> Verizon shall continuously use the Premises solely for the purpose of constructing, maintaining, repairing, and operating its Communications Facilities (including Verizon's Existing Facilities and additional equipment approved pursuant to Sections 6.3 and 6.4) and uses necessarily incidental to such use. All Communications Facilities shall be installed at Verizon's expense and shall remain the exclusive property of Verizon.
- 6.2 Approvals and Permits. Verizon shall not install any additional Antenna Facilities or otherwise modify the then-existing Communications Facilities or make any additions, alterations, or improvements to the Premises, Easements, or Property without first obtaining all necessary federal, state, and local governmental approvals and permits for such work.

6.3 Installation of Initial Modification

- 6.3.1 Prior to commencing construction of the Initial Modification, Verizon shall submit all the following to West Allis:
 - 6.3.1.1 Application. An Antenna Site Application on a form supplied by West Allis ("Application"); the complete and executed Application shall be attached as Exhibit B-1.

- 6.3.1.2 *Non-refundable one-time fee.* The required fee, as set forth in Section 3.1 of this Agreement.
- 6.3.1.3 Construction Drawings. Detailed construction plans and drawings ("CDs") for all improvements for West Allis's written approval, which approval must be obtained before Verizon may commence any construction or installation work on the Property. If West Allis disapproves the CDs, Verizon may provide West Allis with revised plans for West Allis's review. West Allis's approval of the CDs shall not be unreasonably withheld, conditioned, or delayed.
- 6.3.1.4 Radio Frequency Interference Study. An interference study to determine whether the Antenna Facilities Verizon proposes to install as part of the Initial Modification will interfere with the electronic equipment of West Allis or other communications equipment located on the Tower owned and operated by third parties.
- 6.3.1.5 Engineering Study/Structural Analysis. An engineering study and structural analysis to determine whether the proposed installation of the Initial Modification will adversely affect the structural integrity of the Tower.
- 6.3.1.6 Site Survey. A site survey as required under Section 1.2.
- 6.3.2 Verizon may not commence any construction work or installation on the Premises, until West Allis has marked the CDs for the Initial Modification approved, such approval shall not be unreasonably withheld. The CDs, once approved, shall be attached as Exhibit C-1.
- 6.3.3 Verizon's installation of the Communications Facilities shall be completed in a neat and workmanlike manner in accordance with sound engineering practices, applicable rules, regulations, and laws and in compliance with the approved CDs in Exhibit C-1. West Allis, may, at Verizon's expense, inspect the actual location and installation of all Communications Facilities to ensure compliance with the approved CDs.
- 6.3.4 Verizon, at its expense, and within 90 days after the installation of the Communications Facilities, shall provide to West Allis As-Built Drawings of the Communications Facilities installed on the Premises, which drawings shall show the actual location of all of Verizon's Communications Facilities located on the Premises (including any of Verizon's Existing Facilities remaining on the Premises). Such drawings shall be accompanied by a complete and detailed inventory of all of Verizon's Communications located on the Premises, all of which, when approved by West Allis, shall be attached as **Exhibit D-1**.

6.4 Future Modifications

- 6.4.1 Once the Initial Modification is completed, Verizon shall not add any additional Antenna Facilities or otherwise modify the then-existing Communications Facilities or make any additions, alterations, or improvements to the Premises or Property ("Modification Project"), aside from routine maintenance, without first submitting to West Allis:
 - 6.4.1.1 Application. A new complete and executed Application, which shall be attached as Exhibit B-2 (subsequent Applications shall be numbered sequentially—e.g., Exhibit B-3).
 - 6.4.1.2 *Deposit.* The required deposit, as set forth in the new Application.
 - 6.4.1.3 Modification Construction Drawings. Detailed construction plans and drawings for the Modifications ("Modification CDs") for West Allis's written approval, such approval shall not be unreasonably withheld, but is subject to a commercially reasonable increase in License Fee.
 - 6.4.1.4 Radio Frequency Interference Study. An interference study to determine whether the Antenna Facilities Verizon proposes to install as part of the Modification Project will interfere with the electronic equipment of West Allis or other communications equipment located on the Tower owned and operated by third parties.
 - 6.4.1.5 Engineering Study/Structural Analysis. An engineering study and structural analysis to determine whether the proposed installation of the Modification Project will adversely affect the structural integrity of the Tower.
 - 6.4.1.6 Site Survey. If the proposed Modification Project involves changes to the boundaries of the Land Space and/or Easements, an updated site survey as required under Section 1.2, which, once approved by West Allis, shall replace Exhibit A-2.
- 6.4.2 Any Modification Project subject to an increase in the then-current License Fee shall not be installed until the Parties have mutually agreed on the amount of the increase, as reflected in an amendment to this Agreement.
- 6.4.3 Verizon may not commence any construction or installation work until West Allis has marked the Modification CDs approved. The Modification CDs, once approved, shall be attached as **Exhibit C-2** (subsequent Modification CDs shall be numbered sequentially—e.g., **Exhibit C-3**).
- 6.4.4 All Modification Projects shall be constructed in a neat and workmanlike manner in accordance with sound engineering practices, all applicable rules, regulations, and laws, and in strict compliance with the approved Modification CDs.

6.4.5 On making the Modifications, Verizon shall provide to West Allis updated As-Built Drawings in the manner specified in Section 6.3.4, which drawings, when approved by West Allis, shall be attached as **Exhibit D-2** (subsequent As-Built Drawings shall be numbered sequentially—e.g., **Exhibit D-3**).

6.5 Additional Requirements

- 6.5.1 Once any CDs, Modification CDs, or supplemental materials as may be requested for West Allis's evaluation and written approval for the Modification Project within this Article 6 have been received by West Allis (collectively, the "Project Plans"), West Allis shall use reasonable efforts to complete its review and respond to Verizon with its detailed comments, disapproval, or approval of the Project Plans within 30 days.
- 6.5.2 Any damage done to the Property or the Tower during installation, maintenance, or operation of the Communications Facilities shall be immediately repaired at Verizon's expense and to West Allis's reasonable satisfaction. Verizon shall pay all costs and expenses in relation to maintaining the structural integrity of the Tower in connection with Verizon's installation and operation of the Communications Facilities.
- 6.6 Review/Inspection. As directed by West Allis, West Allis's consulting engineer shall review and periodically inspect any Modification Project beginning with the preconstruction conference and continuing through installation, construction, punch-list review, and verification of the As-Built Drawings. Before Verizon may energize its system (i.e., start-up), all punch-list items must be substantially completed as reasonably determined by West Allis.

6.7 Replacement/Repair

- 6.6.1 With the exception of emergencies, Verizon shall submit to West Allis advance written notice of the need for and the nature of any repair of Verizon's existing Antenna Facilities or the replacement of such facilities on a like-for-like basis, using the Antenna Site Service Notice form attached as Exhibit E ("Service Notice").
- 6.6.2 Once West Allis receives a complete Service Notice form, West Allis will have 10 business days in which reject or approve, in writing, the proposed replacement or repair work and to seek additional information, if needed. If West Allis rejects Verizon's Service Notice, Verizon may not proceed with the replacement or repair work without West Allis's written approval, which approval may not be unreasonably withheld, conditioned, or delayed. Verizon may resubmit a revised Service Notice as often as necessary until approved by West Allis.
- 6.6.3 In the case of an emergency, Verizon shall provide written notice to West Allis describing the replacement or repair, as well an explanation of the reason the repair or replacement constituted an emergency and did not require prior written notice to West Allis, with the written notice being transmitted by Verizon to West Allis

within 24 hours following the emergency replacement or repair. As used in this Agreement, "emergency" shall be deemed to exist only in instances in which the emergency conditions constitute an immediate threat to the health or safety of the public or immediate danger to the Tower and its operations.

6.6.4 For the sake of clarity, "**like-for-like basis**" means that the existing equipment is replaced with equipment that imposes no greater impact than the existing equipment (e.g., the dimensions are the same or smaller, weight is equal or less, radio frequency interference is equal or less, and that the new equipment is attached in the same manner as the then-existing equipment).

6.8 Responsibility for Costs.

- 6.7.1 Verizon shall reimburse West Allis for all third-party professional costs that West Allis incurs associated with a Project. Such costs shall include payments West Allis makes to West Allis's technical consultants for their work associated with a Project as well as payments made to outside legal counsel for their work associated with the Project (collectively, "Professional Costs").
- 6.7.2 If the Professional Costs exceed the amount of the deposit required under Section 6.3.1.2 or 6.4.1.2, West Allis shall provide Verizon with a detailed invoice for the excess amount within 30 days of Project Completion. "Project Completion" means the point at which West Allis has completed all post-construction inspection, Verizon has completed any and all remedial work to West Allis's satisfaction, and West Allis has approved in writing Verizon's As-Built Drawings. Verizon shall pay any such invoice within 30 days of its receipt.
- 6.7.3 If the Professional Costs are less than the amount of the deposit, West Allis shall return such unused amounts within 30 days of Project Completion.
- 6.7.4 Any work performed or service provided by West Allis under this Agreement, the cost of which is Verizon's responsibility, shall be charged out at West Allis's annually adopted fully loaded labor rate and transportation rate, which rates shall include a charge for administrative and general costs. West Allis will invoice Verizon for such costs, which invoice shall be due and payable within 30 days of its receipt.

ARTICLE 7: ACCESS

7.1 Verizon shall have 24/7 unsupervised access to its Antenna Facilities located on the Land Space portion of the Premises. Verizon may have supervised access to its Antenna Facilities on the Tower by requesting access 48 hours in advance. For instances involving regular maintenance, Verizon shall request access to the Tower by calling (414) 302-8830. If Verizon needs access to the Tower in an emergency, it shall give advance notice to West Allis as soon as reasonably possible by calling (414) 302-8830 between 7:00 a.m. and 3:00 p.m. or (414) 550-7402 between 3:00 p.m. and 7:00 a.m. Verizon shall reimburse West Allis for all costs West Allis incurs in sending its personnel to the Site and in supervising

- Verizon's Tower access. West Allis will invoice Verizon for such costs, which invoice shall be due and payable within 30 days of its receipt.
- 7.2 Verizon shall be subject to any and all emergency operation plans adopted by West Allis applicable to the Tower. When accessing the Tower, Verizon's employees, contractors, and agents shall have proper identification. Verizon shall be responsible for maintaining a written record of the names of its employees, contractors, and agents who perform work on the Tower, the nature of the work performed, and the date and time such work is performed. Verizon shall make such records available to West Allis upon request.

ARTICLE 8: INDEMNIFICATION

8.1 <u>Indemnification</u>. Verizon, and its employees, agents, and contractors or their subcontractors ("**Indemnifying Parties**") shall defend, indemnify, and hold harmless West Allis and its officers, officials, agents, and employees ("**Indemnified Parties**") against any and all liability, costs, damages, fines, taxes, special charges by others, penalties, payments (including payments made by West Allis under any Worker's Compensation Laws or under any plan for employee disability and death benefits), and expenses (including reasonable attorney's fees of West Allis and all other costs and expenses of litigation) (each a "**Covered Claim**") to the extent that such Covered Claims may be asserted against an Indemnified Party by any person or entity and arise in any way, (including any act, omission, failure, negligence, or willful misconduct, in connection with the construction, maintenance, repair, presence, removal, or operation of the Communications Facilities by Verizon or another Indemnifying Party, except to the extent West Allis's willful misconduct gives rise to such Covered Claim.

8.2 Procedure for Indemnification

- 8.2.1 West Allis shall give prompt written notice to Verizon of any claim or threatened claim, specifying the factual basis for such claim and the amount of the claim. If the claim relates to an action, suit, or proceeding filed by a third party against West Allis, West Allis shall give the notice to Verizon no later than 15 days after West Allis receives written notice of the action, suit, or proceeding.
- 8.2.2 West Allis's failure to give the required notice will not relieve Verizon from its obligation to indemnify West Allis unless, and only to the extent, that Verizon is materially prejudiced by such failure.
- 8.2.3 Verizon will have the right at any time, by notice to West Allis, to participate in or assume control of the defense of the claim with counsel of its choice, which counsel must be reasonably acceptable to West Allis. West Allis agrees to cooperate fully with Verizon. If Verizon assumes control of the defense of any third-party claim, West Allis shall have the right to participate in the defense at its own expense. If Verizon does not assume control or otherwise participate in the defense of any third-party claim, Verizon shall be bound by the results obtained by West Allis with respect to the claim.

- 8.2.4 If Verizon assumes the defense of a third-party claim as described above, then in no event will West Allis admit any liability with respect to, or settle, compromise, or discharge, any third-party claim without Verizon's prior written consent.
- 8.2.5 Verizon shall take prompt action to defend and indemnify the Indemnified Parties against Covered Claims, actual or threatened, but in no event later than notice by West Allis to Verizon of the service of a notice, summons, complaint, petition, or other service of a process against an Indemnified Party relating to a Covered Claim attributed in any way to the Agreement; the work to be performed under this Agreement; or the acts, fault, negligence, equipment, materials, properties, facilities, personnel, or property of Verizon or other Indemnifying Party. Verizon shall defend any such claim or threatened claim, including as applicable, engagement of legal counsel, to respond to, defend, settle, or compromise any claim or threatened claim.
- 8.3 Verizon understands and agrees it is responsible for any and all costs and expenses incurred by West Allis to enforce this indemnification provision.

ARTICLE 9: INSURANCE

- 9.1 Policies Required. At all times during the Term of this Agreement, Verizon shall keep in force and effect all insurance policies as described below. It is the intent of both Parties that the liability insurance in place in accordance with the provisions of this Article 9 shall be primary insurance and shall protect both Verizon and West Allis from losses caused, in whole or in part, from the performance of this Agreement.
 - 9.1.1 Worker's Compensation and Employers' Liability Insurance. Statutory worker's compensation benefits and employers' liability insurance with a limit of liability of \$1,000,000 each accident each accident/disease/policy limit. To the extent allowed by law, this policy shall include a waiver of subrogation with respect to West Allis.
 - 9.1.2 Commercial General Liability Insurance. As per ISO Form or equivalent, policy will be written to include coverage for premises-operations, products and completed operations, personal and advertising injury, contractual liability, independent contractor's coverage, and coverage for property damage from perils of explosion, collapse, or damage to underground utilities (commonly known as XCU coverage). Limits of liability shall be \$6,000,000 per occurrence for bodily injury and property damage and \$6,000,000 general aggregate, \$6,000,000 products/completed operations aggregate, \$6,000,000 personal and advertising injury.
 - 9.1.3 Automobile Liability Insurance. Commercial automobile policy covering all owned, hired, and non-owned vehicles. Limits of liability shall be \$6,000,000 combined single limit each accident for bodily injury and property damage.
 - 9.1.4 Property Insurance. Each Party to this Agreement will be responsible for maintaining property insurance on its own facilities, buildings, and other improvements, including all equipment, fixtures, and utility structures, fencing, or support systems that may be placed on, within, or around West Allis's Facilities to

fully protect against hazards of fire, vandalism and malicious mischief, and such other perils as are covered by policies of insurance commonly referred to and known as "extended coverage" insurance, or shall self-insure such exposures.

- 9.2 Self-Insurance. Notwithstanding the foregoing, Verizon may self-insure all or a portion of the insurance coverage and limit requirements required in this Agreement. In the event Verizon elects to self-insure its obligation to include West Allis as an additional insured. the following provisions shall apply in addition to those set forth in this Article 9: (i) Verizon or its parent company shall have and continuously maintain a tangible net worth of at least \$200,000,000; (ii) Verizon shall continuously maintain appropriate loss reserves for the amount of its self-insurance obligations under this Section 9.2, which reserves shall be annually approved by Ernst & Young, or any successor auditing company; (iii) Verizon shall undertake the defense of any self-insured claim for which a defense and/or coverage would have been available from the insurance company, including a defense of West Allis. at Verizon's sole cost and expense, with counsel selected by Verizon and reasonably acceptable to West Allis: (iv) Verizon shall use its own funds to pay any claim or replace property or otherwise provide the funding which would have been available from insurance proceeds but for Verizon's election to self-insure: (v) Verizon shall pay any and all amounts due in lieu of insurance proceeds which would have been payable if Verizon had carried the insurance policies, which amounts shall be treated as insurance proceeds for all purposes under this Agreement; and (vi) all amounts that Verizon pays or is required to pay and all loss or damages resulting from risks for which Verizon has elected to selfinsure shall not limit Verizon's indemnification obligations set forth in this Agreement. If Verizon self-insures, it will not be required, to the extent of the self-insurance, to name West Allis as an Additional Insured, as otherwise required in this Article 9.
- 9.3 Qualification/Priority/Contractors' Coverage. The insurer must be authorized to do business under the laws of the State of Wisconsin and have an "A-" or better rating in Best's Guide. All contractors and all of their subcontractors who perform work on behalf of Verizon shall carry, in full force and effect, substantially the same insurance with substantially the same limits as required of Verizon. Prior to any such contractor or its subcontractors performing any work for Verizon under this Agreement, Verizon shall furnish West Allis with a certificate of insurance for each such contractor or subcontractor.

9.4 <u>Certificate of Insurance/Other Requirements</u>

- 9.4.1 Upon the execution of this Agreement, annually thereafter, and within 30 days of the expiration or renewal of any liability policies required by this Agreement, Verizon will furnish West Allis with certificates of insurance and policy endorsements evidencing the required coverage. The certificates shall reference this Agreement and the worker's waivers of subrogation required by this Agreement. The certificates of insurance and endorsements shall be attached as Exhibit F, which shall be updated annually.
- 9.4.2 West Allis and its officers, officials, and employees shall be included as an "Additional Insured" as their interests may appear under this Agreement under all

- of the required policies, except worker's compensation and employer's liability, which shall be so stated on the certificate of insurance.
- 9.4.3 All policies, other than worker's compensation, shall be written on an occurrence, and not on a claims-made, basis.
- 9.5 <u>Prohibited Exclusions.</u> No policies of insurance required to be obtained by Verizon or its contractors or subcontractors shall contain provisions that exclude:
 - 9.5.1 Coverage of liability arising from excavating, collapse, or underground work, or
 - 9.5.2 Coverage for injuries to West Allis's employees or agents.
- 9.6 Reports. Verizon shall promptly furnish West Allis with copies of any accident or incident report(s) sent to Verizon's insurance carriers covering accidents/incidents occurring in connection with and/or as a result of the performance of the work under this Agreement.

ARTICLE 10: LIMITATION OF LIABILITY-

- 10.1 West Allis reserves to itself the right to maintain and operate the Tower and Property in the manner that will best enable it to fulfill its water utility service requirements. Verizon agrees to use the Property and Tower at its sole risk. Notwithstanding the foregoing, West Allis shall exercise reasonable precaution to avoid damaging Verizon's Communications Facilities and shall report to Verizon the occurrence of any such damage caused by West Allis. Subject to Section 10.2, West Allis agrees to reimburse Verizon for all reasonable costs Verizon incurs for the physical repair of its Communications Facilities to the extent damaged by West Allis's negligence or willful misconduct.
- 10.2 No provision of this Agreement is intended, nor shall be construed, to be a waiver for any purpose of any provision of Wis. Stat. §§ 893.80 or 345.05 or any other notice requirements, governmental immunities, or damages limitations that may apply to West Allis, its employees, officials, or agents.

ARTICLE 11: INTERFERENCE

- 11.1 Verizon agrees to install only equipment of the type and frequency that will not cause harmful interference measurable in accordance with then-existing industry standards to any equipment of West Allis (whenever installed) or preexisting radio frequency users on the Property, as long as those preexisting radio frequency user(s) operate and continue to operate within their respective frequencies and in accordance with all applicable laws and regulations.
- 11.2 Verizon's installation, operation, maintenance, and use of its Communications Facilities shall not damage or adversely interfere in any way with West Allis's communications equipment or its water utility operations, including the Tower and its related repair and maintenance activities. West Allis, at all times during this Agreement, reserves the right to take any action it deems necessary, in its sole discretion, to repair, maintain, alter, or improve the Tower as may be necessary in order to carry out any such activities. West Allis agrees

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to give at least 120 days' advance notice of such activities to Verizon, except in the case of an emergency, in which case West Allis shall notify Verizon as soon as reasonably possible. West Allis will permit Verizon, at Verizon's sole cost and expense, to place a cell tower on wheels ("COW") on the Property in a mutual agreeable location for the duration of the disruption. West Allis agrees to reasonably cooperate with Verizon to carry out such activities with a minimum amount of disruption to Verizon's transmission operations.

- 11.3 In the event any equipment installed by Verizon causes interference to West Allis's then-existing (i.e., at the time of the interference) equipment on the Property, and after West Allis has notified Verizon in writing of such interference, Verizon will immediately take all commercially reasonable steps necessary to correct and eliminate the interference, including, but not limited to, powering down such equipment and later powering up such equipment for intermittent testing.
- 11.4 West Allis agrees that other licensees or lessees on the Tower who currently or in the future have use of the Tower will be permitted to install only such equipment that is of the type and frequency that will not cause harmful interference, which is measurable in accordance with then-existing industry standards, to Verizon's then-existing equipment on the Tower.
- 11.5 Notwithstanding the above, West Allis agrees that each of its agreements with other future Tower users shall contain a provision substantially the same as Section 11.1 and that West Allis shall enforce such provisions in a nondiscriminatory manner with respect to all of its licensees or lessees. West Allis further agrees that West Allis and its employees, contractors, and agents shall use reasonable efforts, consistent with Section 11.2, not to cause interference with the operation of Verizon's Communications Facilities.
- 11.6 The Parties acknowledge that there will not be an adequate remedy at law for noncompliance with the provisions of this Article 11 and, therefore, either Party shall have the right to equitable remedies, such as, without limitation, injunctive relief, and specific performance.
- 11.7 In addition to all other remedies available to Verizon, in the event the equipment or activities of existing lessees/licensees or West Allis are causing interference to Verizon's Communications Facilities and such interference is not eliminated within 7 days after written notice to West Allis from Verizon, then Verizon shall have the right to terminate this Agreement.
- 11.8 For the purposes of this Agreement, "**interference**" may include, but is not limited to, any use of the Property that causes electronic interference with or physical obstruction or, or degradation of, the communications signals from the facilities of any permitted users of the Property.

ARTICLE 12: TOWER/PROPERTY MAINTENANCE

12.1 <u>Antenna Facilities Remain in Place</u>. The following process shall be followed when the Tower is to be painted and/or reconditioned and West Allis, in its sole discretion,

determines that it is reasonable to keep all or any portion of the Antenna Facilities in place while such work is performed.

- 12.1.1 West Allis shall notify Verizon prior to the end of any calendar year during which West Allis has planned and budgeted for Tower painting and/or reconditioning in the subsequent year and shall further notify Verizon at least 90 days in advance of the week when the work on the Tower is to be scheduled.
- 12.1.2 West Allis shall use the following method to determine the impact of the Antenna Facilities on the cost of painting the Tower:
 - 12.1.2.1 The painting contractor will bid on the cost of painting the Tower both with and without the Antenna Facilities. The contractor will then proceed to paint the Tower with the Antenna Facilities left in place.
 - 12.1.2.2 Verizon shall be responsible for the difference between the two bids and shall pay any such invoice therefor within 30 days of its receipt.
- 12.2 Temporary Relocation of Antenna Facilities. When, in West Allis's sole discretion, maintenance, repair, repainting, restoration, or other such activity with respect to the Tower requires the Antenna Facilities to be temporarily relocated, West Allis shall give Verizon at least 6 months' prior written notice of the date such work has been scheduled. Within that 6-month period, Verizon shall relocate its equipment on a temporary basis to another location on the Property. If Verizon requires the use of a COW, West Allis shall permit Verizon, at Verizon's sole expense, to place a COW on the Property in a location mutually agreed upon by West Allis and Verizon. Verizon shall cooperate with West Allis regarding the placement of the COW on the Property.
- 12.3 Temporary Emergency Relocation. In case of an emergency that requires removal of Verizon's Antenna Facilities, West Allis shall provide advance telephone notice to Verizon as soon as practical by calling its 24 hours a day, 7 days a week Network Operations Center (NOC) at (800) 264-6620. Verizon shall respond within six (6) hours of the call after which the parties shall work together to effectuate the prompt temporary emergency relocation. In the event the use of Verizon's Antenna Facilities is interrupted, Verizon shall have the right to maintain a COW temporarily on the Property in a location approved by West Allis. If the Property will not accommodate a COW, it is Verizon's responsibility to locate alternative sites. If Verizon does not respond within six (6) hours of the call or is unable to remove its Antenna Facilities within a reasonable time depending upon the nature of the emergency, West Allis may cause the Antenna Facilities to be removed.
- 12.4 <u>Premises Maintenance</u>. Verizon will keep and maintain the Premises, including the Land Space, in good condition, reasonable wear and tear, and damage from the elements excepted. No materials may be used in the installation of the Antenna Facilities or transmission lines that will cause corrosion or rust or deterioration of the Tower structure or its appurtenances. All Antenna Facilities on the Tower must be identified by a marking fastened securely to its bracket on the Tower and all transmission lines must be tagged at the conduit opening where they enter Verizon's equipment shelter.

- 12.5 Compliance with Laws. Verizon, at its expense, shall diligently, faithfully, and promptly wholly obey and conform with all federal, state, and local orders, rules, regulations, and laws, including all Federal Communications Commission ("FCC") and Federal Aviation Administration ("FAA") rules, in relation to any of its business activities or other operations conducted upon, above, or adjacent to the Property and including the American National Standards Institute's ("ANSI") "Safety Levels with respect to Human Exposure to Radio Frequency Electromagnetic Fields" as set forth in the current ANSI standard or any FCC standard which supersedes that standard or any Environmental Protection Agency rules or regulations that may hereinafter be adopted which supersede this standard. In addition, Verizon shall adhere to all Occupational Safety and Health Administration safety requirements. Verizon shall provide to West Allis a copy of any written notice received by Verizon from any governing authority regarding non-compliance with any federal, state. or local order, rule, regulation, or law within 30 days of Verizon's receipt of such notice of non-compliance. Any fines or penalties imposed for improper or illegal operation of Verizon's Communications Facilities shall be Verizon's sole responsibility.
- 12.6 <u>FAA Compliance</u>. Verizon shall be solely responsible for taking all steps necessary to ensure that, in installing its Communications Facilities on the premises, the Tower remains in compliance with any and all applicable FAA regulations. Notwithstanding anything to the contrary in this Agreement, if Verizon's Communications Equipment causes the Tower to fall out of compliance with FAA regulations, Verizon shall be solely responsible for any and all costs associated with bringing the Tower into compliance, including, among other things, installing and maintaining any lighting equipment that may be required.
- 12.7 <u>Advertisements</u>. Verizon shall not advertise on the Property or on any structure on the Property, except for company identification as required by FCC regulation.

ARTICLE 13: REMOVAL/BOND

- 13.1 Upon termination or expiration of this Agreement, Verizon shall have 90 days to remove the Communications Facilities from the Property, except underground utilities, which Verizon shall disconnect, and foundations, which shall be removed to a depth of 4 feet below grade, and shall restore the Tower and the Property to the condition they were in on the Effective Date, ordinary wear and tear and loss by casualty or other causes beyond Verizon's control excepted, all at Verizon's sole cost and expense. Before removing any part of its Antenna Facilities from the Tower upon termination or expiration of this Agreement, Verizon agrees on behalf of itself and its successors and assigns to provide West Allis with reasonable advance notice of its intentions to remove such facilities and agrees to coordinate such removal with West Allis.
- 13.2 On or before the Effective Date, Verizon shall provide to West Allis a bond with an entity and in a form satisfactory to the City Attorney for West Allis. The initial amount of the bond shall be \$35,000.00, the bond shall be renewed annually at an amount that is 3 percent greater than the amount in the preceding year, and the bond shall be kept in full force so long as the Communications Facilities are on the Premises. The purpose of the bond is to ensure the removal of the Communications Facilities (and any other equipment or

15

- improvements of Verizon) and the restoration of the Property at the termination or expiration of this Agreement.
- 13.3 In the event that Verizon fails to comply with the removal and restoration requirements of this Agreement, West Allis shall have the right, using its own personnel or a contractor, to perform such removal and restoration, and Verizon agrees to reimburse West Allis for West Allis's actual costs of such removal and restoration within 60 days of receiving an invoice therefor. If Verizon fails to reimburse West Allis within such 60-day period, then West Allis may go against the bond referenced in Section 13.2.
- 13.4 In the event West Allis does not exercise its right of removal under Section 13.3 and Verizon fails to completely remove its Communications Facilities from the Premises, or fails to restore the Tower and Property as required, Verizon shall continue to pay a License Fee equal to 150% of the License Fee in effect during the last month of the Term, prorated for each and every day of every month during which any part of Verizon's Communications Facilities remains on the Property. Whether or not any or all of the Communications Facilities are in use or functioning shall not be considered a factor when determining Verizon's payment obligations under this Article 13.

ARTICLE 14: ASSIGNMENT/NO SUBLICENSING-

- 14.1 Without West Allis's approval or consent, this Agreement may be sold, assigned, or transferred to (i) any entity in which Verizon directly or indirectly holds an equity or similar interest; (ii) any entity which directly or indirectly holds an equity or similar interest in Verizon; or (iii) any entity directly or indirectly under common control with Verizon. Verizon may assign this Agreement to any entity which acquires all or substantially all of Verizon's assets in the market defined by the Federal Communications Commission in which the Property is located by reason of a merger, acquisition, or other business reorganization without approval or consent of West Allis. As to other parties, this Agreement may not be sold, assigned, or transferred without West Allis's written consent, which consent will not be unreasonably withheld, delayed, or conditioned. No change of stock ownership, partnership interest, or control of Verizon or transfer upon partnership or corporate dissolution of Verizon shall constitute an assignment hereunder.
- 14.2 No assignment or transfer under this Agreement shall be effective until the assignee or transferee agrees in writing to assume all the obligations of Verizon arising under this Agreement. Verizon shall furnish West Allis with prior written notice of the transfer or assignment, together with the name and address of the transferee or assignee.
- 14.3 Nothing contained in this Agreement shall be deemed expressly or by implication to give Verizon any right or power to mortgage West Allis's fee or any other interest of West Allis's in or to the Premises or the Property.

ARTICLE 15: NOTICES

15.1 All notices hereunder must be in writing and shall be deemed validly given if sent by certified mail, return receipt requested or by commercial courier, provided the courier's regular business is delivery service and provided further that it guarantees delivery to the

addressee by the end of the next business day following the courier's receipt from the sender, addressed as follows (or to any other address that the Party to be notified may have designated to the sender by like notice):

West Allis: West Allis Water Utility

7525 West Greenfield Avenue

West Allis, WI 53214

With a copy to: West Allis City Attorney

7525 West Greenfield Avenue

West Allis, WI 53214

Verizon Wireless

180 Washington Valley Road Bedminster, New Jersey 07921

Attention: Network Real Estate

With a copy to: TBD

- 15.2 Notice shall be effective upon actual receipt or refusal as shown on the receipt obtained pursuant to the foregoing.
- 15.3 Telephone numbers and email addresses for the Parties are as follows:

West Allis: (414) 302-8830

water@westalliswi.gov

Verizon: (___) ___-__ (TBD)

______(TBD)

15.4 Except where otherwise provided, a telephone call or email will not constitute notice. In case of emergency, each Party will attempt to contact the other Party in the most expeditious manner possible.

ARTICLE 16: ENVIRONMENTAL

16.1 Verizon shall use its best efforts to ensure that its use of the Property will not generate any Hazardous Substances. Verizon agrees that it will not store or dispose of on the Property or transport to or over the Property any Hazardous Substances and that its Communications Facilities do not constitute or contain and will not generate any Hazardous Substance in violation of state or federal law now or hereafter in effect, including any amendments. West Allis will otherwise be responsible for addressing any environmental condition on the Property except to the extent the condition is caused by Verizon.

16.2 "Hazardous Substances" shall be interpreted broadly to mean any substance or material designated or defined as hazardous or toxic waste, hazardous or toxic material, hazardous or toxic or radioactive substance, or other similar term by any federal, state, or local laws, regulations, or rules now or hereafter in effect, including any amendments.

ARTICLE 17: CASUALTY/DECOMMISSIONING

- 17.1 If the Tower is damaged for any reason, other than by reason of the willful misconduct or negligence of Verizon, its employees, contractors, or agents, so as to render it substantially unusable for Verizon's intended use, the License Fee shall abate until West Allis, at West Allis's expense and option, restores the Tower to its condition prior to such damage. If West Allis elects not to restore the Tower, it shall give Verizon written notice of such election and of the immediate termination of the Agreement.
- 17.2 In the event Verizon is unable to install a COW or its functional equivalent in a mutually agreed upon location for Verizon's use during the Tower repairs or West Allis does not begin Tower repairs within 14 business days following the date the Tower was damaged, Verizon shall have the right to terminate this Agreement by giving West Allis written notice thereof, as long as Verizon has not resumed operations upon the Property.
- 17.3 West Allis, in its absolute discretion, may decommission and dismantle the Tower at any time. West Allis shall give Verizon 365 days' prior written notice of the date by which its Communications Facilities must be removed from the Property in accordance with Article 13. This Agreement will terminate at the end of the 365-day notice period or whatever longer time to which the Parties may agree.

ARTICLE 18: DEFAULT/REMEDIES

- 18.1 The following will be deemed a default by Verizon and a breach of this Agreement:
 - 18.1.1 The License Fee or other sum owed to West Allis remains unpaid for more than 20 days after receipt of written notice from West Allis of such failure to pay; or
 - 18.1.2 Verizon's failure to perform any other term or condition or failure to correct Verizon's breach of any warranty or covenant under this Agreement within 30 days after receipt of written notice from West Allis specifying the failure.
- 18.2 No such failure by Verizon under Section 18.1.2, however, will be deemed to exist if Verizon has commenced to cure such default within such 30-day period and provided that such efforts are prosecuted to completion with reasonable diligence. Delay in curing a default will be excused if due to causes beyond Verizon's reasonable control. If Verizon remains in default beyond any applicable cure period, West Allis will have any and all rights available to it under law and equity.
- 18.3 In the event of any default by Verizon, West Allis, in addition to all other rights and remedies available to West Allis at law or equity, shall have the right to serve a written notice upon Verizon that West Allis elects to terminate this Agreement upon a specified date not less than 10 days but no more than 30 days after the date of serving such notice,

and this Agreement shall terminate on the date so specified as if that date had been originally fixed as the termination date of the Term granted. In the event this Agreement is so terminated, Verizon shall immediately pay to West Allis a sum of money equal to the total of any unpaid consideration accrued through the date of termination.

- 18.4 The following will be deemed a default by West Allis and a breach of this Agreement:
 - 18.4.1 West Allis's failure to provide access to the Premises within 48 hours of a request for access under Article 7.
 - 18.4.2 West Allis's failure to perform any other term or condition or failure to correct West Allis's breach of any warranty or covenant under this Agreement within 30 days after receipt of written notice from Verizon specifying the failure.
- 18.5 No failure of West Allis under Section 18.4.2, however, will be deemed to exist if West Allis has commenced to cure the default within such 30-day period and provided such efforts are prosecuted to completion with reasonable diligence. Delay in curing a default will be excused if due to causes beyond West Allis's reasonable control. If West Allis remains in default beyond any applicable cure period, Verizon will have any and all rights available to it under law and equity.
- 18.6 Verizon's sole remedy for West Allis's failure to provide access timely is the right to seek specific performance.

ARTICLE 19: AUTHORITY

- 19.1 Each Party warrants to the other that the person or persons executing this Agreement on the Party's behalf have the full right, power, and authority to enter into and execute this Agreement on such Party's behalf.
- 19.2 The Parties agree that this Agreement is not binding on either Party until fully executed and delivered.
- 19.3 The Parties agree that West Allis has proprietary ownership rights and control over the Property and the Tower. The Parties agree that FCC 18-133, Section 6409 of the Middle Class Tax Relief and Job Creation Action (47 U.S.C. § 1455) and other state or federal orders, rulings, and laws governing West Allis's regulatory functions do not limit West Allis's authority as to this Agreement.

ARTICLE 20: ADDITIONAL PROVISIONS

20.1 <u>Compliance with Laws</u>. During the Term, West Allis and Verizon shall conduct their activities at the Property and the Tower so as to comply with all applicable laws, rules, regulations, ordinances, directives, covenants, easements, permits, zoning and land use regulations, restrictions of record, and building codes, and the requirements of any applicable fire insurance underwriter or rating bureau, now in effect or which may hereinafter come into effect (including, without limitation, the Americans with Disabilities act and laws relating to Hazardous Substances).

- 20.2 <u>Recording and Further Assurances.</u> West Allis and Verizon agree to execute a Memorandum of this Agreement in the form attached as **Exhibit G**, which Verizon shall record with the appropriate recording officer, within 30 days of the Effective Date. West Allis and Verizon agree as part of the basis of their bargain for this Agreement to cooperate fully in executing any and all documents (including amendments to this Agreement) necessary to correct any factual or legal errors, omissions, or mistakes, and to take any and all additional action, that may be necessary or appropriate to give full force and effect to the terms and intent of this Agreement.
- 20.3 <u>Subordination and Non-Disturbance</u>. West Allis agrees that if the Property is or becomes encumbered by a deed to secure a debt, mortgage, or other security interest, West Allis will provide promptly to Verizon a mutually agreeable subordination, non-disturbance, and attornment agreement.
- 20.4 <u>Survival</u>. The provisions of the Agreement relating to indemnification and insurance shall survive any termination or expiration of this Agreement. Additionally, any provisions of this Agreement that require performance subsequent to the termination or expiration of this Agreement shall also survive such termination or expiration.
- 20.5 Governing Law. This Agreement and the performance thereof shall be governed, interpreted, construed, and regulated by the laws of the State of Wisconsin, without regard to its conflict of law provisions.
- 20.6 <u>Entire Agreement</u>. This Agreement, including its recitals and exhibits, contains all agreements, promises, and understandings between West Allis and Verizon with respect to the subject matter of this Agreement, and no verbal or oral agreements, promises, or understandings shall be binding upon either West Allis or Verizon in any dispute, controversy, or proceeding at law.
- 20.7 Quiet Enjoyment. West Allis covenants that Verizon, on paying the License Fee and performing the covenants herein, shall peaceably and quietly have, hold, and enjoy the Premises.
- 20.8 <u>Amendment</u>. Any amendment or modification of this Agreement shall be void and ineffective unless made in writing and signed by both Parties.
- 20.9 <u>Severability</u>. In the event any provision of the Agreement is found to be invalid or unenforceable, such finding shall not affect the validity and enforceability of the remaining provisions of this Agreement.
- 20.10 No Waiver. The failure of either Party to insist upon strict performance of any of the terms or conditions of this Agreement or to exercise any of its rights under the Agreement shall not waive such rights and such Party shall have the right to enforce such rights at any time and take such action as may be lawful and authorized under this Agreement, in law or in equity.
- 20.11 <u>Successors</u>. This Agreement shall extend to and bind the heirs, personal representatives, successors, and permitted assigns of the Parties.

The Parties have formed this Agreement as of the Effective Date.

[SIGNATURE PAGE FOLLOWS]

** 21

	Wireless
By:	By:
Print Name:	Print Name:

Verizon Wireless Personal Communications LP d/b/a Verizon

Title: _____

City of West Allis, Wisconsin

Title:

EXHIBIT A-1

LEGAL DESCRIPTIONS

Property

[Verizon to Provide]

Land Space

[Verizon to Provide]

Easements

[Verizon to Provide]

EXHIBIT A-2

SITE SURVEY

[Verizon to Provide]


EXHIBIT B-1

ANTENNA SITE APPLICATION

[City to Provide]

EXHIBIT C-1

APPROVED CONSTRUCTION DRAWINGS

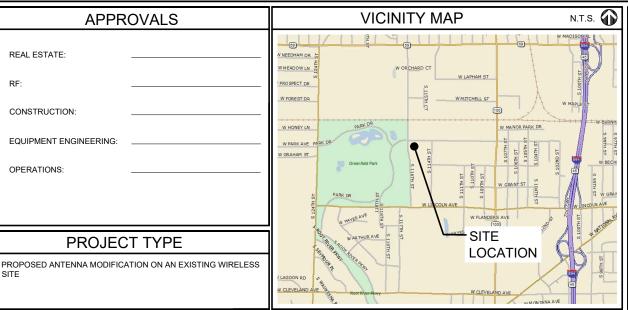

N.T.S. **REGIONAL MAP** LOCATION

CONSULTANT TEAM

PROJECT CONSULTANT: TERRA CONSULTING GROUP, LTD

600 BUSSE HIGHWAY PARK RIDGE, IL 60068 (847) 698-6400

STRUCTURAL CONSULTANT: KRECH OJARD & ASSOCIATES, PA (TOWER ANALYSIS)

101 PUTNAM STREET EAU CLAIRE, WI 54703 (715) 552-7374 (715) 552-7336 (FAX)

STRUCTURAL CONSULTANT: BY OTHERS

(MOUNT ANALYSIS)

OCCUPANCY:

MOUNT ANALYSIS STATUS:

COMPLETE

MOUNT ANALYSIS RESULTS:

MODIFICATIONS DESIGNED

MOUNT ANALYSIS DATE: 09/28/2022 STRUCTURAL ANALYSIS DATE: 03/15/2021 LERR

CONTRACTOR PMI REQUIREMENTS

PMI ACCESSED AT: HTTPS://PMI.VZWSMART.COM

10031841 SMART TOOL VENDOR PROJECT #

VZW LOCATION CODE (PSLC): 113278

> ***PMLAND REQUIREMENTS ALSO EMBEDDED IN MOUNT ANALYSIS REPORT

MOUNT MODIFCATION REQUIRED:

PHONE: (847) 619-5397

YES

VZW APPROVED SMART KIT VENDORS

REFER TO MOUNT MODIFICATION DRAWINGS PAGE FOR VZW SMART KIT APPROVED VENDORS

verizon

1701 GOLF ROAD, TOWER 2, SUITE 400

ROLLING MEADOWS. ILLINOIS 60008

FAX: (847) 706-7415

GENERAL CONTRACTOR TO FOLLOW ALL APPLICABLE BUILDING CODES OBSERVED BY LOCAL JURISDICTION

PROJECT INFORMATION

UNINHABITED

11515 W ROGERS ST SITE ADDRESS:

MILWAUKEE, WI 53227

43° 00' 28.30" N LATITUDE: (APPROXIMATE) LONGITUDE 88° 03' 21 90" W (APPROXIMATE)

STRUCTURE OWNER: CITY OF WEST ALLIS

CONTACT PERSON MICHAEL BROEKA

MBROFKA@WESTALLISWI.GOV

APPLICANT: **VERIZON WIRELESS**

1701 GOLF ROAD TOWER 2 SUITE 400

ROLLING MEADOWS, IL 60008

REAL ESTATE MANAGER: KIM KUESTER (630) 903-5403


RFE FCC COMPLIANCE ASSESSMENT

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		ADDITIC		REVIS		

LOCATION NUMBER: 113278

SITE NAME: WEST ROGERS WT

11515 W ROGERS ST MILWAUKEE, WI 53227

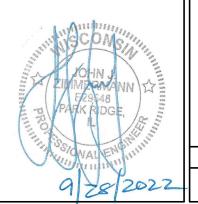

SHEET	DRAWING INDEX	REVISION
T-1	TITLE SHEET	1.
C-1	SITE LAYOUT	١.
A-1		-
	SHELTER LAYOUT	-
ANT-1	SITE ELEVATION	1.
ANT-2	ANTENNA LAYOUT	-
ANT-2A	PROPOSED ANTENNA LAYOUT	1.,3.
ANT-2B	PROPOSED ANTENNA LAYOUT	1.
ANT-3	ANTENNA INFORMATION	-
ANT-3A	COMBINER CABLE DATA & CABLE DIAGRAM	-
ANT-4	DETAILS	-
EX-1	PHOTO EXHIBIT	-
	22" x 34" IS FULL SCALE 11" x 17" IS HALF SCALE	
	ATTACHMENTS	
	POWER UPGRADE DRAWING	

WEST ROGERS WT


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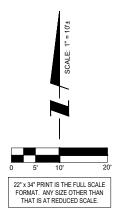
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CHECKED BY:	AU
DATE:	02/11/21
PROJECT #:	124-878

SHEET TITLE TITLE SHEET



DISTRICTS AND COMPANIES SHALL ALSO BE NOTIFIED



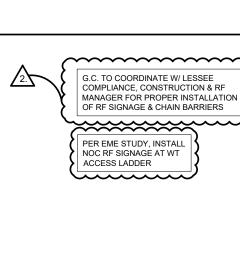



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	DATE	02/11/2021	04/28/2021	12/02/2021	09/28/2022		
REVISIONS	DESCRIPTION	ISSUED FOR REVIEW	ADDITION OF REVISED MA/ISSUED FOR PERMITTING	ISSUED FOR FINALS	REVISED PER UPDATED MOUNT MODIFICATIONS		
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LOC. # 113278

WEST ROGERS WT

11515 W ROGERS ST MILWAUKEE, WI 53227


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CHECKED BY:	AU
DATE:	02/11/21
PROJECT #:	124-878

SHEET TITLE

SITE LAYOUT

SHEET NUMBE

C-1

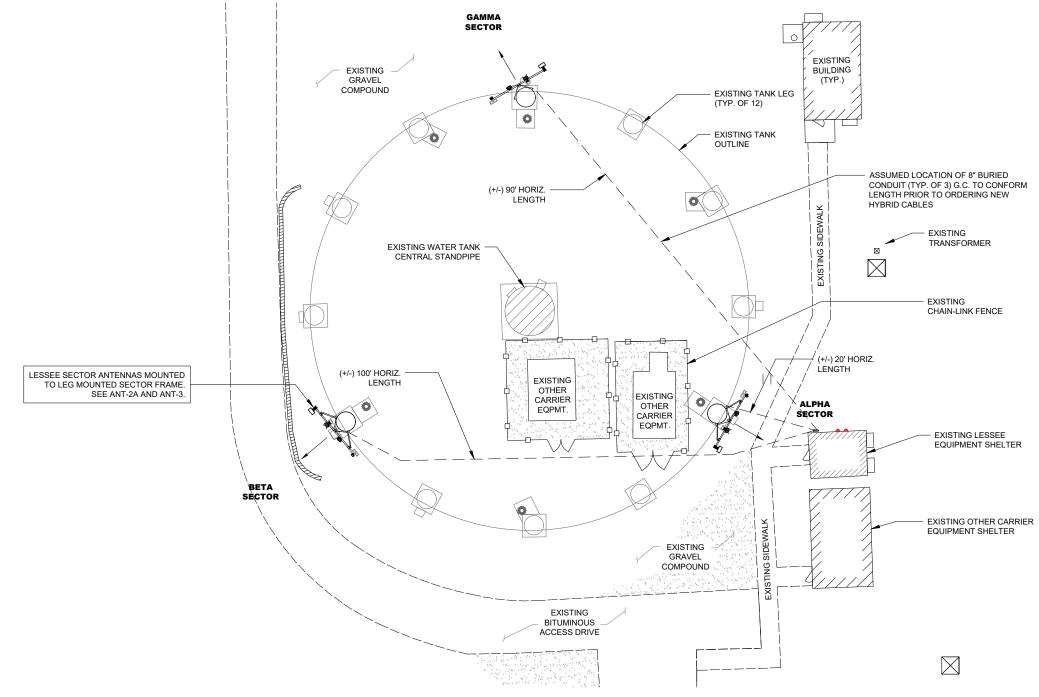

1) SITE LAYOUT


EXISTING SITE CONDITIONS SUPPLIED BY LESSEE. SITE VISIT WAS NOT PERFORMED FOR THIS UPGRADE.



EXISTING RAYCAP JUNCTION BOX IN SHELTER



EXISTING RAYCAP JUNCTION BOX IN SHELTER

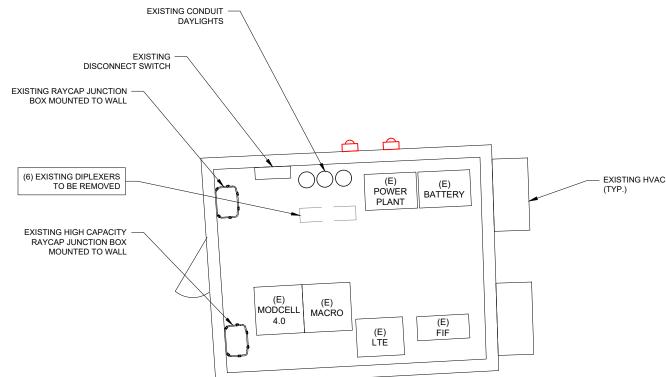

22" x 34" PRINT IS THE FULL SCALE FORMAT. ANY SIZE OTHER THAN THAT IS AT REDUCED SCALE.



NO. DESCRIPTION - ISSUED FOR REVIEW 1. ADDITION OF REVISED BOAT PERMITTING 2. ISSUED FOR FINALS 3. REVISED PER UPDATED MOUNT MODIFICATIONS	REVISIONS		
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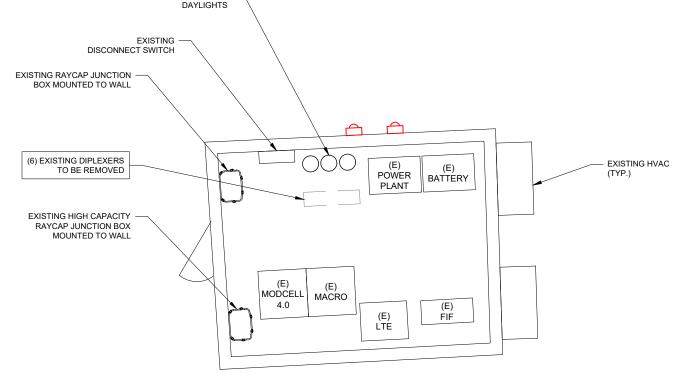
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CHECKED BY:	AU
DATE:	02/11/21
PROJECT #:	124-878

SHEET TITLE

SHELTER LAYOUT

A-1



SHELTER LAYOUT

NOTES:
RAYCAP JUNCTION BOX WILL HAVE 24" OF VERTICAL
CLEARANCE TO ALLOW FOR THE COVER TO SLIDE OFF.

MAXIMUM CABLE LENGTH OF 30' BETWEEN LTE CABINET AND RAYCAP JUNCTION BOX.

 $\ensuremath{\mathsf{G.C.}}$ TO GROUND ALL NEW COMPONENTS TO EXISTING GROUND SYSTEM.

ALL LESSEE PORTS TO BE WEATHERPROOFED AND SEALED W/ APPROPRIATE BOOTS.

NOTES:

THIS DRAWING IS FOR EXHIBIT AND LAYOUT PURPOSES ONLY.

PLEASE REFER TO TOWER ANALYSIS PROVIDED BY KRECH OJARD & ASSOCIATES, PA AND MOUNT ANALYSIS PROVIDED BY OTHERS FOR ANALYSIS AND STRUCTURAL REQUIREMENTS.

MOUNT MODIFICATIONS REQUIRED. NO ANTENNA WORK TO BEGIN PRIOR TO COMPLETION OF REINFORCEMENT INSTALLATION.

THE ANALYSIS OF THE ANTENNA MOUNT WAS PERFORMED BY OTHERS. TERRA CONSULTING GROUP IS NOT RESPONSIBLE FOR THE ANTENNA MOUNT. THE OWNER DIRECTLY CONTRACTED THE MOUNT ANALYSIS WITH OTHERS.

EXISTING WATER TOWER **BEACON LIGHT** WEST ALLIS MOUNT MODIFICATIONS REQUIRED. PLEASE REFER TO MOUNT ANALYSIS AND "S" SHEETS PROVIDED BY OTHERS EXISTING OTHER CARRIER LESSEE ANTENNA LEVEL. FOR ANTENNA CONFIGURATION SEE ANT-2, ANT-2A & ANT-3. FOR ANCILLARY **EQUIPMENT CONFIGURATION SEE** - EXISTING WATER TOWER (2) PROPOSED RAYCAP JUNCTION BOXES MOUNTED TO SECTOR FRAME. SEE ANT-2A AND ANT-3. (3) EXISTING RRUS TO BE REMOVED AND REPLACED W/ (9) RADIOS. SEE ANT-2A AND ANT-3. (2) HYBRIDS TO REMAIN - G.C. TO DETERMINE IF ENOUGH SLACK ON THIRD HYBRID CABLE AND REPLACE OR REUSE AS NEEDED EXISTING (6) 1-5/8" COAX CABLES CONDUITS TO REMAIN EXISTING (3) 8" CONDUITS ROUTED UNDERGROUND TO TOWER LEGS EXISTING LESSEE EQUIPMENT SHELTER - EXISTING TREE (TYP.) FULL SCALE PRINT IS ON 22"x34" MEDIA HALF SCALE PRINT IS ON 11"x17" MEDIA





LOC. # 113278

WEST ROGERS WT

11515 W ROGERS ST MILWAUKEE, WI 53227

DRAWN BY: 02/11/21 DATE: 124-878

PROJECT #:

SHEET TITLE **ELEVATION**

ANT-1

SCALE: 3/32" = 1'-0" ±

NORTH ELEVATION

EXISTING SITE CONDITIONS SUPPLIED PERFORMED FOR THIS UPGRADE

NOTES:

- THIS DRAWING IS FOR EXHIBIT AND LAYOUT PURPOSES ONLY.
 VERIZON WIRELESS HAS PROVIDED A MOUNT ANALYSIS (BY OTHERS)
 THAT NEEDS TO BE REVIEWED BY THE CONTRACTOR. IF THERE IS ANY
 DISCREPANCY BETWEEN THE MOUNT ANALYSIS AND THIS DRAWING,
 CONTRACTOR IS TO NOTIFY VERIZON WIRELESS. THE MOUNT
 ANALYSIS IS THE GOVERNING DOCUMENT.
- 2. NO ANTENNA OR LINE WORK TO BEGIN PRIOR TO CONFIRMATION OF ADEQUATE TOWER AND MOUNT CAPACITY.
- G.C. TO VERIFY ANTENNA TECHNOLOGIES PRIOR TO REMOVAL OF ANY ANTENNAS.
- REFER TO ANT-3 & ANT-3A FOR DETAIL ON EXISTING & PROPOSED RF CONFIGURATION.


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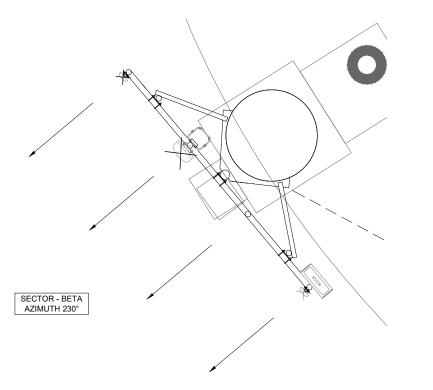
THIS DRAWING IS FOR EXHIBIT AND LAYOUT PURPOSES ONLY.


PLEASE REFER TO TOWER ANALYSIS PROVIDED BY KRECH OJARD & ASSOCIATES, PA AND MOUNT ANALYSIS PROVIDED BY OTHERS FOR ANALYSIS AND STRUCTURAL REQUIREMENTS.

MOUNT MODIFICATIONS REQUIRED. NO ANTENNA WORK TO BEGIN PRIOR TO COMPLETION OF REINFORCEMENT INSTALLATION.

THE ANALYSIS OF THE ANTENNA MOUNT WAS PERFORMED BY OTHERS. TERRA CONSULTING GROUP IS NOT RESPONSIBLE FOR THE ANTENNA MOUNT. THE OWNER DIRECTLY CONTRACTED THE MOUNT ANALYSIS WITH OTHERS.



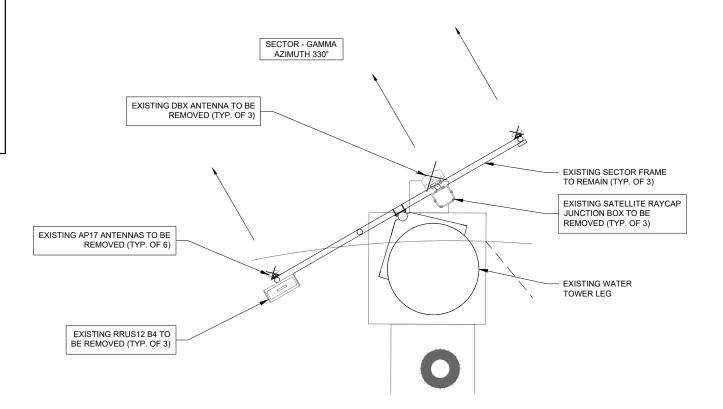

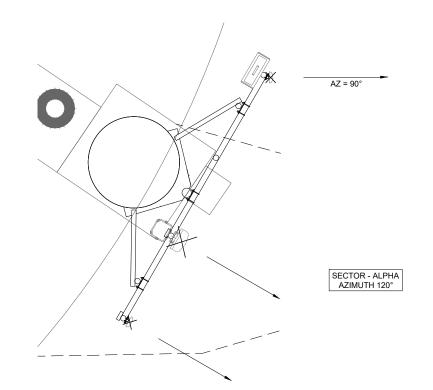

EXISTING SITE CONDITIONS SUPPLIED BY LESSEE. SITE VISIT WAS NOT PERFORMED FOR THIS UPGRADE.









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	В	Ξ	æ	KSS	\$		
	DATE	02/11/2021	04/28/2021	12/02/2021	09/28/2022		
REVISIONS	DESCRIPTION	ISSUED FOR REVIEW	ADDITION OF REVISED MA / ISSUED FOR PERMITTING	ISSUED FOR FINALS	REVISED PER UPDATED MOUNT MODIFICATIONS		
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LOC. # 113278

WEST ROGERS WT

11515 W ROGERS ST MILWAUKEE, WI 53227

DRAWN BY: TH

CHECKED BY: AU

DATE: 02/11/21

PROJECT #: 124-878

SHEET TITLE

ANTENNA LAYOUT

SHEET NUMBER

ANT-2

NOTES:

- THIS DRAWING IS FOR EXHIBIT AND LAYOUT PURPOSES ONLY. VERIZON WIRELESS HAS PROVIDED A MOUNT ANALYSIS (BY OTHERS) THAT NEEDS TO BE REVIEWED BY THE CONTRACTOR. IF THERE IS ANY DISCREPANCY BETWEEN THE MOUNT ANALYSIS AND THIS DRAWING, CONTRACTOR IS TO NOTIFY VERIZON WIRELESS. THE MOUNT ANALYSIS IS THE GOVERNING DOCUMENT.
- 2. NO ANTENNA OR LINE WORK TO BEGIN PRIOR TO CONFIRMATION OF ADEQUATE TOWER AND MOUNT CAPACITY.
- G.C. TO VERIFY ANTENNA TECHNOLOGIES PRIOR TO REMOVAL OF ANY ANTENNAS.
- REFER TO ANT-3 & ANT-3A FOR DETAIL ON EXISTING & PROPOSED RF CONFIGURATION.


NOTES:


THIS DRAWING IS FOR EXHIBIT AND LAYOUT PURPOSES ONLY.


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MOUNT MODIFICATIONS REQUIRED. NO ANTENNA WORK TO BEGIN PRIOR TO COMPLETION OF REINFORCEMENT INSTALLATION.

THE ANALYSIS OF THE ANTENNA MOUNT WAS PERFORMED BY OTHERS. TERRA CONSULTING GROUP IS NOT RESPONSIBLE FOR THE ANTENNA MOUNT. THE OWNER DIRECTLY CONTRACTED THE MOUNT ANALYSIS WITH OTHERS.



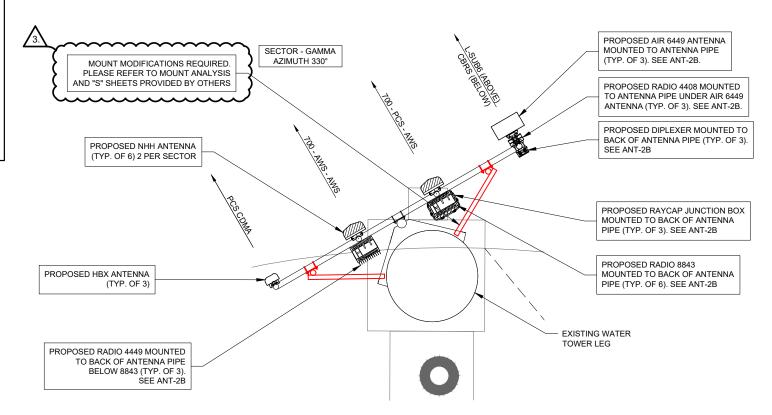

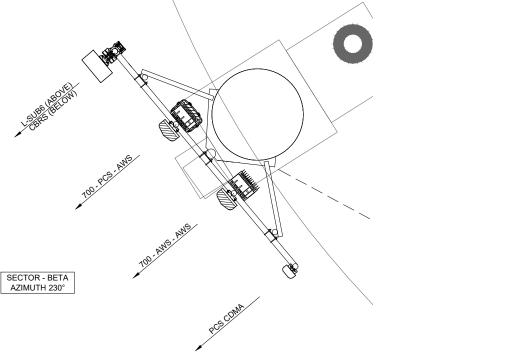

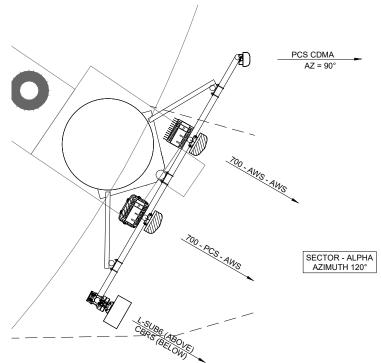EXISTING SITE CONDITIONS SUPPLIED BY VERIZON WIRELESS AND ARE NOTED IN THE MOUNT ANALYSIS (BY OTHERS). SITE VISIT WAS NOT PERFORMED FOR THIS UPGRADE.

NOTE:

THE GENERAL CONTRACTOR IS TO REFER TO THE STRUCTURAL MOUNT ANALYSIS PERFORMED BY OTHERS. THIS IS A REPRESENTATION TAKEN DIRECTLY FROM THAT ANALYSIS. IF THERE IS CONFLICT BETWEEN THE ANALYSIS AND DRAWINGS, THE ANALYSIS TAKES PRECEDENT. VERIZON WIRELESS CONTRACTED DIRECTLY WITH THE MOUNT ANALYSIS ENGINEER; TERRA IS NOT RESPONSIBLE FOR THE MOUNT ANALYSIS.

PROPOSED ANTENNA LAYOUT
N.T.S.





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	DATE	02/11/2021	04/28/2021	12/02/2021	09/28/2022			
REVISIONS	DESCRIPTION	ISSUED FOR REVIEW	ADDITION OF REVISED MA / ISSUED FOR PERMITTING	ISSUED FOR FINALS	REVISED PER UPDATED MOUNT MODIFICATIONS			
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LOC. # 113278

WEST ROGERS WT

11515 W ROGERS ST MILWAUKEE, WI 53227

DRAWN BY:	TH
CHECKED BY:	AU
DATE:	02/11/21
PROJECT #:	124-878

SHEET TITLE

PROPOSED ANTENNA LAYOUT

SHEET NUMBER

ANT-2A




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Structure: 113278-VZW - WEST ROGERS WT -- 698801

 Sector:
 A
 9/28/2022

 Structure Type:
 Water Tank
 10170920

 Mount Elev:
 101.00
 Page: 1

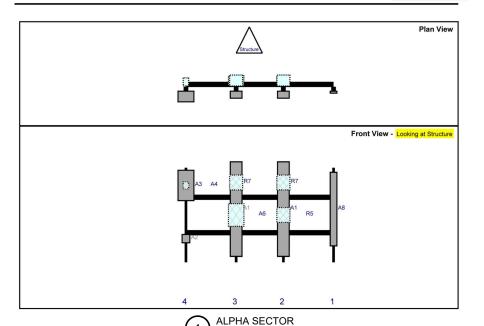


Structure: 113278-VZW - WEST ROGERS WT -- 698801

 Sector:
 C
 9/28/2022

 Structure Type: Water Tank
 10170920
 DF PAUL J. FORD

 Mount Elev:
 101.00
 Page: 3

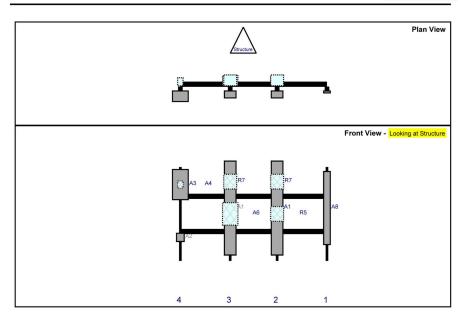


GAMMA SECTOR

Structure: 113278-VZW - WEST ROGERS WT -- 698801

 Sector:
 B
 9/28/2022

 Structure Type:
 Water Tank
 10170920

 Mount Elev:
 101.00
 Page: 2

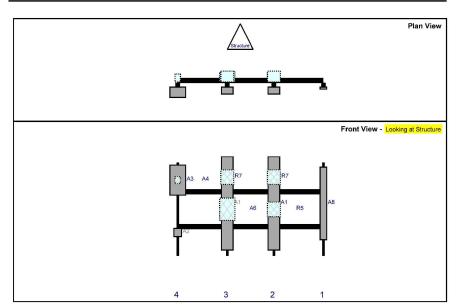

2 BETA SECTOR

ALPHA SECTOR

		Height	Width	H Dist	Pipe	Pipe	Ant	C. Ant	Ant		
Re#	Model	(in)	(in)	Fm L.	#	Pos V	Pos	Frm T.	H Off	Status	Validation
A8	HBX-9016DS-VTM	74.7	6.8	150	1	а	Front	42	0	Added	
A1	NHH-65C-R2B	96	11.9	99	2	а	Front	42	0	Added	
R5	4449	15	13.2	99	2	а	Behind	48	0	Added	
R7	8843	15	13.2	99	2	а	Behind	15	0	Added	
A1	NHH-65C-R2B	96	11.9	51	3	а	Front	42	0	Added	
A6	RC3DC-3315-PF-48	23	15.7	51	3	a	Behind	48	0	Added	
R7	8843	15	13.2	51	3	a	Behind	15	0	Added	
A2	4408 w/ KRE 105 281/1	8.4	7.9		4	а	Front	72	0	Added	
A3	AIR 6449	30.8	16.1		4	а	Front	18	0	Added	
A4	CDX1923Q-DS-43	6.9	5.5		4	а	Behind	18	0	Added	

BETA SECTOR

		rieigitt	v would	II LAISE	ripe	Libe	Aut	C. All	Air		
Re#	Model	(in)	(in)	Frm L.	#	Pos V	Pos	Frm T.	H Off	Status	Validation
8A	HBX-9016DS-VTM	74.7	6.8	150	1	а	Front	42	0	Added	
A1	NHH-65C-R2B	96	11.9	99	2	а	Front	42	0	Added	
R5	4449	15	13.2	99	2	а	Behind	48	0	Added	
R7	8843	15	13.2	99	2	a	Behind	15	0	Added	
A1	NHH-65G-R2B	96	11.9	51	3	а	Front	42	0	Added	
A6	RC3DC-3315-PF-48	23	15.7	51	3	а	Behind	48	0	Added	
R7	8843	15	13.2	51	3	а	Behind	15	0	Added	
A2	4408 w/ KRE 105 281/1	8.4	7.9		4	а	Front	72	0	Added	
A3	AIR 6449	30.8	16.1		4	а	Front	18	0	Added	
A4	CDX1923Q-DS-43	6.9	5.5		4	а	Behind	18	0	Added	

GAMMA SECTOR

		Height	Width	H Dist	Pipe	Pipe	Ant	C. Ant	Ant		
Re#	Model	(in)	(in)	Frm L	#	Pos V	Pos	Frm T.	H Off	Status	Validation
A8	HBX-9016DS-VTM	74.7	6.8	150	1	a	Front	42	0	Added	
A1	NHH-65C-R2B	96	11.9	99	2	а	Front	42	0	Added	
R5	4449	15	13.2	99	2	а	Behind	48	0	Added	
R7	8843	15	13.2	99	2	а	Behind	15	0	Added	
A1	NHH-65C-R2B	96	11.9	51	3	a	Front	42	0	Added	
A6	RC3DC-3315-PF-48	23	15.7	51	3	а	Behind	48	0	Added	
R7	8843	15	13.2	51	3	a	Behind	15	0	Added	
A2	4408 W/ KRE 105 281/1	8.4	7.9		4	а	Front	72	0	Added	
А3	AIR 6449	30.8	16.1		4	а	Front	18	0	Added	
A4	CDX1923Q-DS-43	6.9	5.5		4	а	Behind	18	0	Added	

NOTE:

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LOC. # 113278

WEST ROGERS WT

11515 W ROGERS ST MILWAUKEE, WI 53227


DRAWN BY:	TH
CHECKED BY:	AU
DATE:	02/11/21
PROJECT #:	124-878

SHEET TITLE

PROPOSED ANTENNA LAYOUT

SHEET NUMBER

ANT-2B

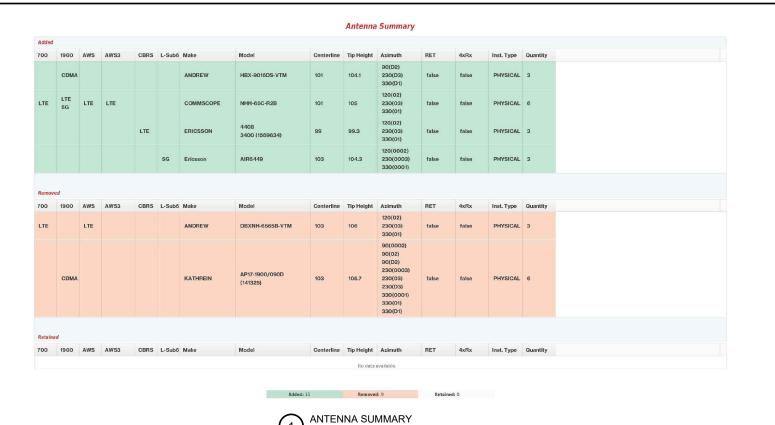

Equipment Summary

Added													
Equipment Type	Location	700	1900	AWS	AWS3	CBRS	L-Sub6	Make	Model	Cable Length	Cable Size	Install Type	Quantity
Diplexer	Tower							Commscope	CDX1923Q-DS-43			PHYSICAL	3
RRU	Tower					LTE		Ericsson	4408 B48			PHYSICAL	3
RRU	Tower	LTE						Ericsson	4449			PHYSICAL	3
RRU	Tower			LTE	LTE			Ericsson	8843			PHYSICAL	3
RRU	Tower						5G	Ericsson	AIR6449			PHYSICAL	3
OVP Box	Tower							Raycap	3315			PHYSICAL	3
OVP Box	Shelter							Raycap	6627			PHYSICAL	1
Removed													
Equipment Type	Location	700	1900	AWS	AWS3	CBRS	L-Sub6	Make	Model	Cable Length	Cable Size	Install Type	Quantity
Coaxial Cables	Tower							Andrew	Coax		15/8"	PHYSICAL	3
OVP Box	Tower							Commscope	1064			PHYSICAL	3
BAIST	Tower							Commscope	ATSBT-TOP-MF (Bias-T)			PHYSICAL	3
Diplexer	Tower							Commscope	DBC-7CAP			PHYSICAL	6
RRU	Tower			LTE				Ericsson	RRUS12 B4			PHYSICAL	3
RRU	Tower	LTE						Ericsson	RUL01 B13			PHYSICAL	6
Diplexer	Shelter							Commscope	DBC-7CAP			PHYSICAL	6
Retained													
Equipment Type	Location	700	1900	AWS	AWS3	CBRS	L-Sub6	Make	Model	Cable Length	Cable Size	Install Type	Quantity
Coaxial Cables	Tower							Andrew	Coax		15/8"	PHYSICAL	6
Hybrid Cable	Tower							Commscope	6x12			PHYSICAL	3
RRU	Move to Tower		LTE 5G					Ericsson	8843			PHYSICAL	3

1701 GOLF ROAD, 1701 GOLF ROAD, TOWER 2, SUITE 400 ROLLING MEADOWS, IL 60008 PHONE: (847) 706-7415 FAX: (847) 706-7415



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	DATE	02/11/2021	04/28/2021	12/02/2021	09/28/2022		
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LOC. # 113278

WEST ROGERS WT

11515 W ROGERS ST MILWAUKEE, WI 53227

DRAWN BY:	ТН
CHECKED BY:	AU
DATE:	02/11/21
PROJECT #:	124-878


SHEET TITLE
ANTENNA
INFORMATION

SHEET NUMBER

ANT-3

RF EMISSIONS REPORT PROVIDED							
X YES	NO						
DATE OF REPORT: _	10/19/2021						
SIGNAGE/BARI	RIERS REQUIRED						
YES	NO						

EXISTI	EXISTING EQUIPMENT TO BE REUSED							
LOCATION	COMPONENT	COUNT						
TOP	MAIN RAYCAP	0						
ВОТТОМ	MAIN RAYCAP	2						
EXIST	EXISTING CABLING TO BE REUSED							
TYPE	SIZE	COUNT						
HYBRID	MAIN TRUNK	3						
COAX	1-5/8" Ø	6						

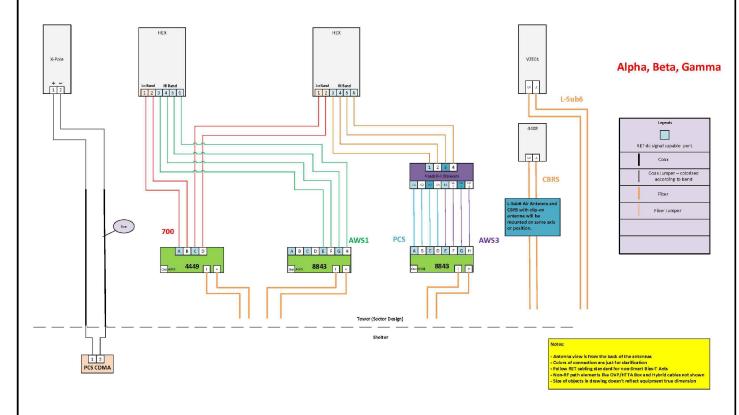

CABLE DIAGRAM

N.T.S.





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	DATE	02/11/2021	04/28/2021	12/02/2021	09/28/2022		
REVISIONS	DESCRIPTION	ISSUED FOR REVIEW	ADDITION OF REVISED MA/ISSUED FOR PERMITTING	ISSUED FOR FINALS	REVISED PER UPDATED MOUNT MODIFICATIONS		
	ON		- -	2.	69		

LOC. # 113278

WEST ROGERS WT

11515 W ROGERS ST MILWAUKEE, WI 53227


DRAWN BY:	TH
CHECKED BY:	AU
DATE:	02/11/21
PROJECT #:	124-878

SHEET TITLE

COMBINER CABLE DATA & CABLE DIAGRAM

SHEET NUMBER

ANT-3A

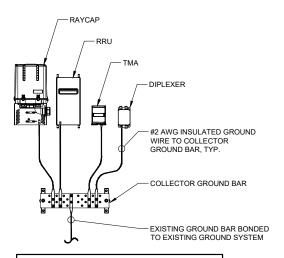

- DETAIL IS CONCEPTUAL ONLY. PLEASE SEE ECR AND LAYOUT SHEETS FOR ACTUAL EQUIPMENT
- GROUND CONNECTIONS MUST BE DOUBLE HOLE CONNECTION. SPECIAL EXCEPTION ONLY TO EQUIPMENT THAT WILL NOT ALLOW FOR A DOUBLE HOLE CONNECTION.





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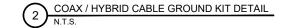
1. DO NOT INSTALL CABLE GROUND KIT AT A BEND AND ALWAYS DIRECT GROUND WIRE DOWN TO GROUND BAR.

- 2. THIS DETAIL IS TYPICAL FOR EACH COAX CABLE WHERE IT IS SPECIFIED TO BE GROUNDED
- 3. CABLE TO BE GROUNDED AT ANTENNA LEVEL AND PRIOR TO ENTERING SHELTER ENTRY PANEL.
- 4. CABLE ALSO TO BE GROUNDED TO GROUND BAR AT TOWER BASE IF APPLICABLE.
- 5. USE ONLY TIN PLATED GROUNDING KITS.





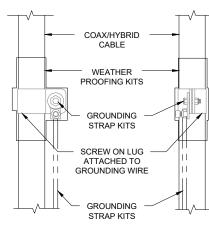

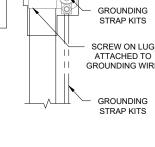

SPECIFICATIONS DC SURGE PROTECTION FOR RRU/INTEGRATED ANTENNA RADIO HEAD

APPLICATION: TOWER / BASE / ROOFTOP / ROOFTOP DISTRIBUTION MODELS WEIGHT: 32LBS (14.51 KG)

[mm]

INCHES

PROPOSED RAYCAP JUNCTION BOX MODEL# RCMDC-3315-PF-48 OR RCMDC-3300-PF-48 LOC. # 113278

> **WEST ROGERS** WT


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11515 W ROGERS ST MILWAUKEE, WI 53227

DRAWN BY:	TH
CHECKED BY:	AU
DATE:	02/11/21
PROJECT #:	124-878
CHEET TITLE	

DETAILS

ANT-4

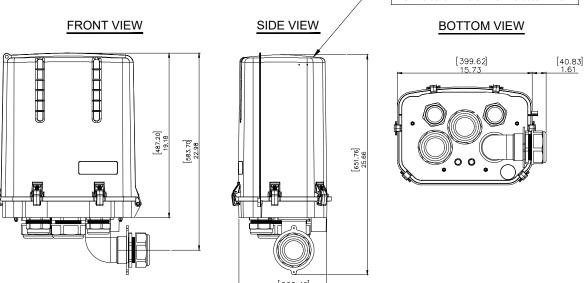


RAYCAP JUNCTION BOX DETAIL





ALPHA SECTOR ANTENNAS

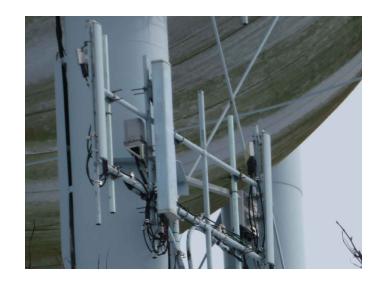

BETA SECTOR ANTENNAS



GAMMA SECTOR ANTENNAS





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	DATE	02/11/2021	04/28/2021	12/02/2021	09/28/2022		
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LOC. # 113278

WEST ROGERS WT

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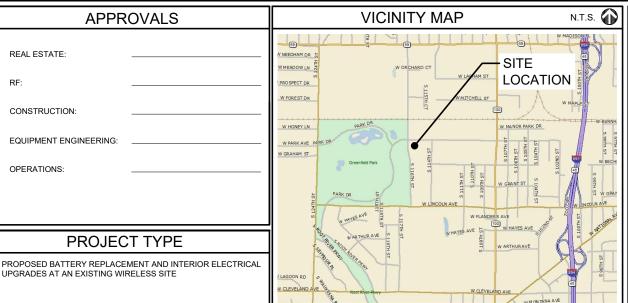
DRAWN BY:	TH
CHECKED BY:	AU
DATE:	02/11/21
PROJECT #:	124-878

SHEET TITLE
PHOTO EXHIBIT

SHEET NUMBER

EX-1

OVERALL WATER TOWER PHOTO





GENERAL CONTRACTOR TO FOLLOW ALL APPLICABLE BUILDING CODES OBSERVED BY LOCAL JURISDICTION

verizon

1701 GOLF ROAD, TOWER 2, SUITE 400 **ROLLING MEADOWS, ILLINOIS 60008** PHONE: (847) 619-5397 FAX: (847) 706-7415

LOCATION NUMBER: 113278

SITE NAME: WEST ROGERS WT

11515 W ROGERS ST MILWAUKEE, WI 53227



CONSULTANT TEAM

PROJECT CONSULTANT: TERRA CONSULTING GROUP, LTD.

600 BUSSE HIGHWAY PARK RIDGE, IL 60068

(847) 698-6400

STRUCTURAL CONSULTANT:



CONSULTING GROUP, 600 BUSSE HIGHWAY	PARK RIDGE, IL 60068 PH: 847-698-6400	FAX: 847-698-6401		
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	B	APD	Ŧ	APD	KSS	3	
	DATE	04/30/2021	06/04/2021	11/03/2021	12/02/2021	09/08/2022	
REVISIONS	DESCRIPTION	ISSUED FOR REVIEW	UPDATED PER POWER COORDINATION	UPDATED PER POWER COORDINATION	ISSUED FOR FINALS	REMOVED GENERATOR	
	ON		-	2.	69	4.	
				•			

LOC. # 113278

WEST ROGERS WT

11515 W ROGERS ST MILWAUKEE, WI 53227

CHECKED BY: 03/24/2021 PROJECT #: 124-878

> SHEET TITLE TITLE SHEET

PROJECT INFORMATION

UNINHABITED OCCUPANCY:

11515 W ROGERS ST SITE ADDRESS: MILWAUKEE, WI 53227

LATITUDE: 43° 00' 28.30" N (APPROXIMATE) LONGITUDE:

STRUCTURE OWNER CITY OF WEST ALLIS

CONTACT PERSON: T.B.D

APPLICANT: VERIZON WIRELESS

1701 GOLF ROAD, TOWER 2, SUITE 400 ROLLING MEADOWS, IL 60008

CONSTRUCTION MANAGER: BRIAN KIM

REAL ESTATE MANAGER: KIM KUESTER (630) 903-5403

SPECIAL NOTES

HANDICAPPED REQUIREMENTS:

FACILITY IS LINMANNED AND NOT FOR HUMAN HABITATION HANDICAPPED ACCESS REQUIREMENTS NOT

PLUMBING REQUIREMENTS:

FACILITY HAS NO PLUMBING OR REFRIGERANTS

FAA AND FCC REQUIREMENTS:

THIS FACILITY SHALL MEET OR EXCEED ALL FAA AND FCC REQUIREMENTS

CONSTRUCTION REQUIREMENTS

ALL WORK MUST CONFORM TO VERIZON WIRELESS CONSTRUCTION INSTALLATION STANDARDS & ALL APPLICABLE CODES AND ORDINANCES

SHEET	DRAWING INDEX	REVISION
T-1	TITLE SHEET	-
LP	EXISTING LOCATION PLAN	-
C-1	CIVIL DEMOLITION PLAN	-
A-1	DEMOLITION FLOOR PLAN	-
A-2	PROPOSED FLOOR PLAN	-
A-3	EQUIPMENT DETAILS	-
EX-1	PHOTO EXHIBIT	-
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22" x 34" IS FULL SCALE | 11" x 17" IS HALF SCALE



OTHER UTILITIES NOT INCLUDED IN DIGGERS HOTLINE AND LOCAL UTILITY DISTRICTS AND COMPANIES SHALL ALSO BE NOTIFIED

WE ENERGIES POWER CONTACT INFORMATION
WORK REQUEST #: 4642143
REP: SARAH LARSON

| REP: SARAH LARSON | PH: (414) 944-5749

PH: (414) 944-5749

*PLEASE NOTE - PER POWER COMPANY AN ADDITIONAL FEE FOR INSTALLATION IS REQUIRED AND A WORK ORDER/QUOTE HAS BEEN SUPPLIED.

WE ENERGIES GAS CONTACT INFORMATION WORK REQUEST #: 4703970 REP: SARAH LARSON

*PLEASE NOTE - PER POWER COMPANY AN ADDITIONAL FEE FOR INSTALLATION IS REQUIRED AND A WORK ORDER/QUOTE HAS BEEN SUPPLIED.

"Call 3 Work Days
Before You Dig!"


TOIL FREE 1-800-242-8511
MM.W. AREA (414) 259-1181
TIDD 1-100-942-2289

OTHER UTILITIES NOT INCLUDED IN DIGGERS HOTLINE AND LOCAL UTILITY DISTRICTS AND COMPANIES SHALL ALSO BE NOTIFIED

THIS SITE PLAN WAS CREATED OFF OF FIELD
MEASUREMENTS BY THE DESIGNER AND ARCHIVE
SURVEY INFORMATION AS A BOUNDARY SURVEY WAS
NOT SUPPLIED FOR PURPOSES OF SITE LAYOUT.

GENERAL SITE NOTES

- CONTRACTOR IS RESPONSIBLE FOR ANY DAMAGE TO EXISTING PAVEMENT.
 CONTRACTOR SHALL PHOTOGRAPH AND VIDEOTAPE EXISTING PAVEMENT
 PRIOR TO CONSTRUCTION. ANY DAMAGE CAUSED DURING CONSTRUCTION
 SHALL BE REPLACED TO EXISTING OR BETTER CONDITION AT NO
 ADDITIONAL COST.
- 2. THE CONTRACTOR WILL, UPON BECOMING AWARE OF SUBSURFACE OR LATENT PHYSICAL CONDITIONS DIFFERING FROM THOSE DISCLOSED BY THE ORIGINAL SOIL INVESTIGATION WORK, PROMPTLY NOTIFY THE OWNER VERBALLY AND IN WRITING, AS TO THE NATURE OF THE DIFFERING CONDITIONS. NO CLAIM BY THE CONTRACTOR FOR ANY CONDITIONS DIFFERING FROM THOSE ANTICIPATED IN THE PLANS AND SPECIFICATIONS AND DISCLOSED BY THE SOIL STUDIES WILL BE ALLOWED UNLESS THE CONTRACTOR HAS SO NOTIFIED THE OWNER, VERBALLY AND IN WRITING, AS REQUIRED ABOVE, OF SUCH DIFFERING SUBSURFACE CONDITIONS.
- 3. CONTRACTOR TO PROVIDE APPROXIMATE 50'X50' STAGING AREA AND TEMPORARY ROAD. CONTRACTOR SHALL COORDINATE WITH ANTENNA CONTRACTOR, A STAGING AREA AND TEMPORARY ROAD THAT IS ACCEPTABLE TO THE OWNER. STAGING AREA AND TEMPORARY ROAD SHALL BE RESTORED TO EXISTING CONDITIONS AS NECESSARY UPON COMPLETION OF THE PROJECT.
- 4. BEFORE AND DURING CONSTRUCTION, THE CONTRACTOR SHALL PROVIDE ADEQUATE EROSION CONTROL AS NECESSARY IN THE FORM OF SILT FENCES FOR THE SITE AND BALES AROUND ANY EXISTING MANHOLES, INLETS, OR CATCH BASINS SUSCEPTIBLE TO EROSION. EROSION CONTROL MEASURES SHALL BE PERIODICALLY INSPECTED TO ENSURE PROPER FUNCTION. EROSION CONTROL SHALL BE REMOVED UPON COMPLETION OF WORK.

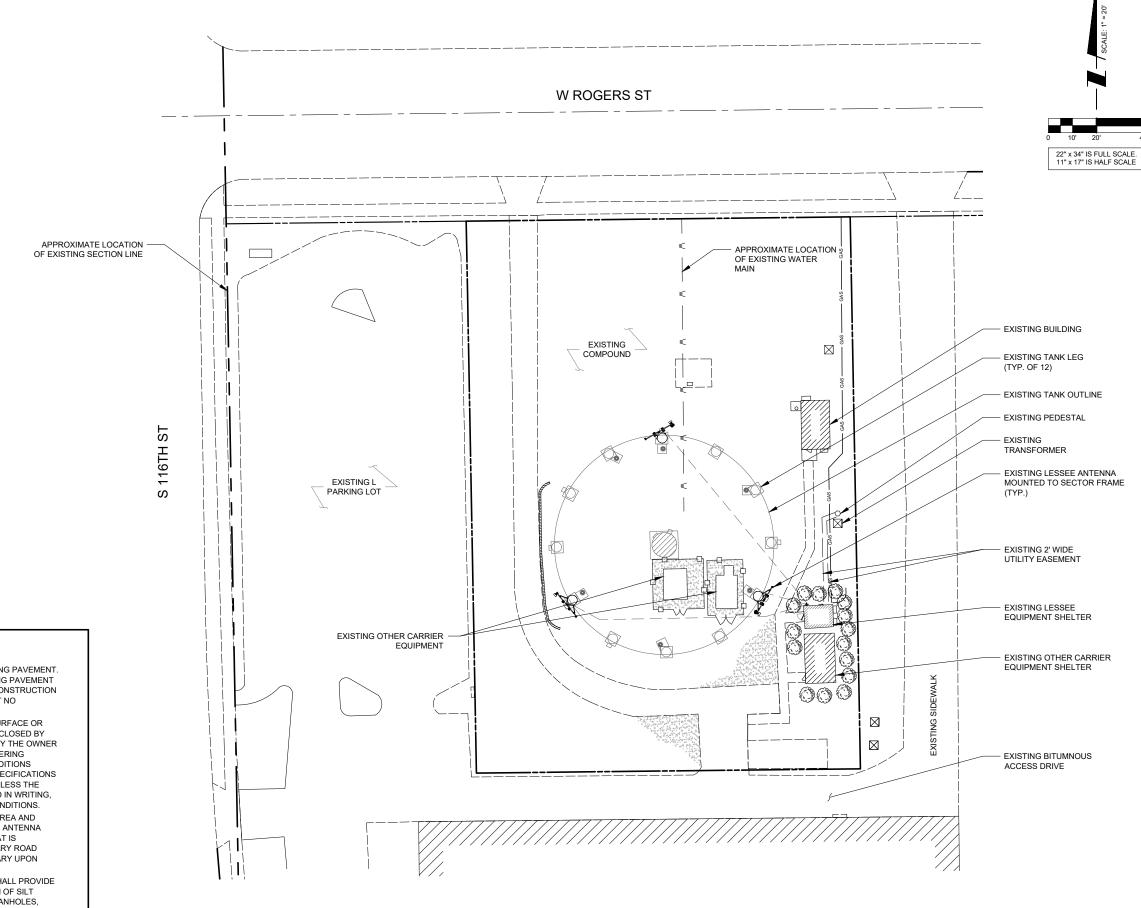

LOCATION PLAN





ВУ	APD	H	APD	KSS	λ	
DATE	04/30/2021	06/04/2021	11/03/2021	12/02/2021	09/08/2022	
DESCRIPTION	ISSUED FOR REVIEW	UPDATED PER POWER COORDINATION	UPDATED PER POWER COORDINATION	ISSUED FOR FINALS	REMOVED GENERATOR	
Ŏ.		+	2.	6.	4.	

LOC. # 113278

WEST ROGERS WT

11515 W ROGERS ST MILWAUKEE, WI 53227

 DRAWN BY:
 JV

 CHECKED BY:
 DM

 DATE:
 03/24/2021


 PROJECT #:
 124-878


SHEET TITLE


EXISTING LOCATION PLAN

SHEET NUMBER



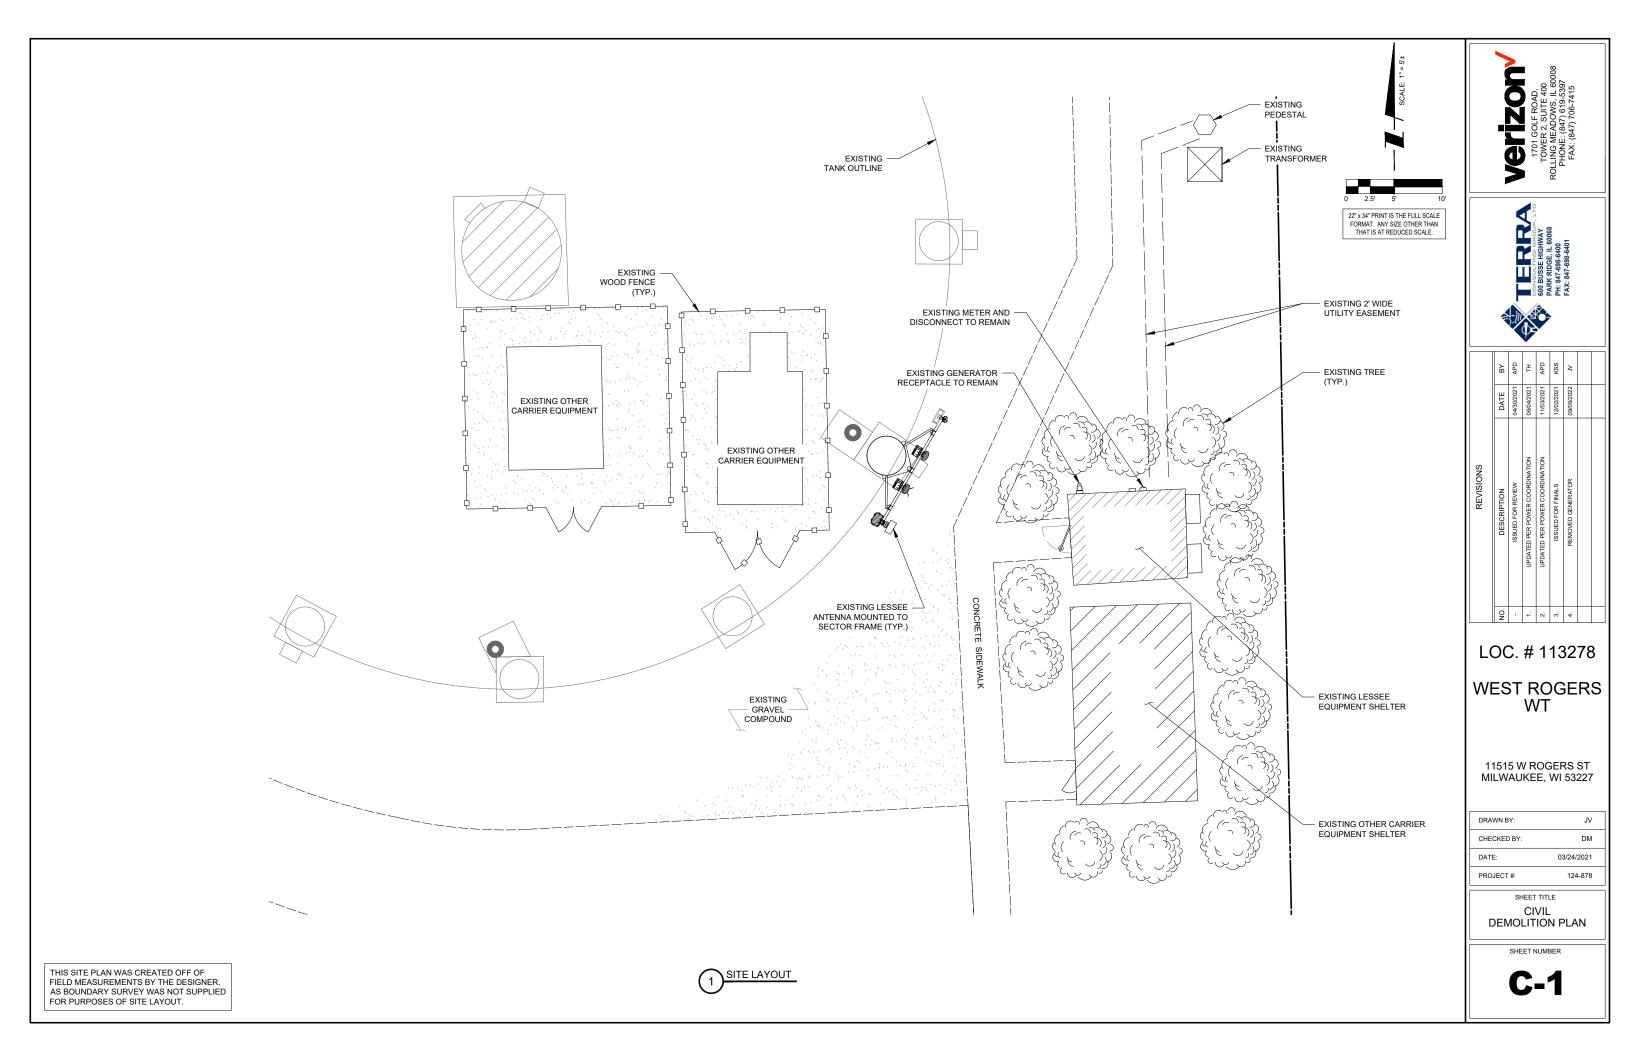

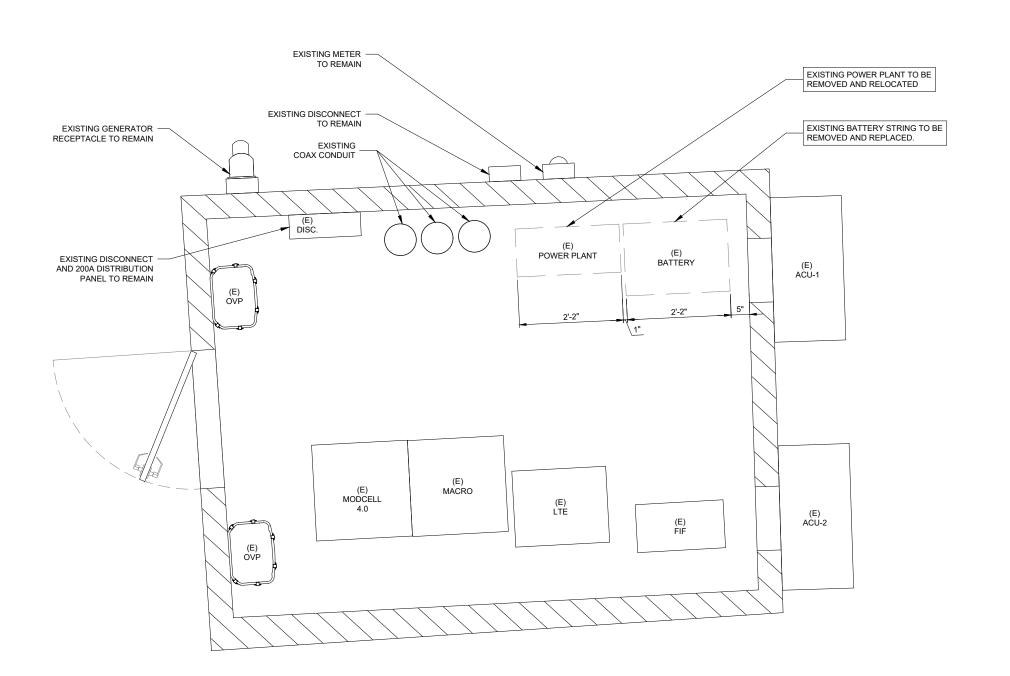

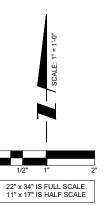

VEFIZOR1701 GOLF ROAD,
TOWER 2, SUITE 400
ROLLING MEADOWS, IL 60008
PHONE: (847) 619-5397
FAX: (847) 706-7415



	REVISIONS		
Š.	DESCRIPTION	DATE	₽
	ISSUED FOR REVIEW	04/30/2021	APD
-	UPDATED PER POWER COORDINATION	06/04/2021	Ŧ
2.	UPDATED PER POWER COORDINATION	11/03/2021	APD
e,	ISSUED FOR FINALS	12/02/2021	KSS
4	REMOVED GENERATOR	09/08/2022	3

LOC. # 113278

WEST ROGERS WT


11515 W ROGERS ST MILWAUKEE, WI 53227


DRAWN BY:	JV
CHECKED BY:	DM
DATE:	03/24/2021
PROJECT #:	124-878

SHEET TITLE
DEMOLITION
FLOOR PLAN

SHEET NUMBER

A-1

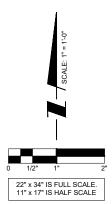

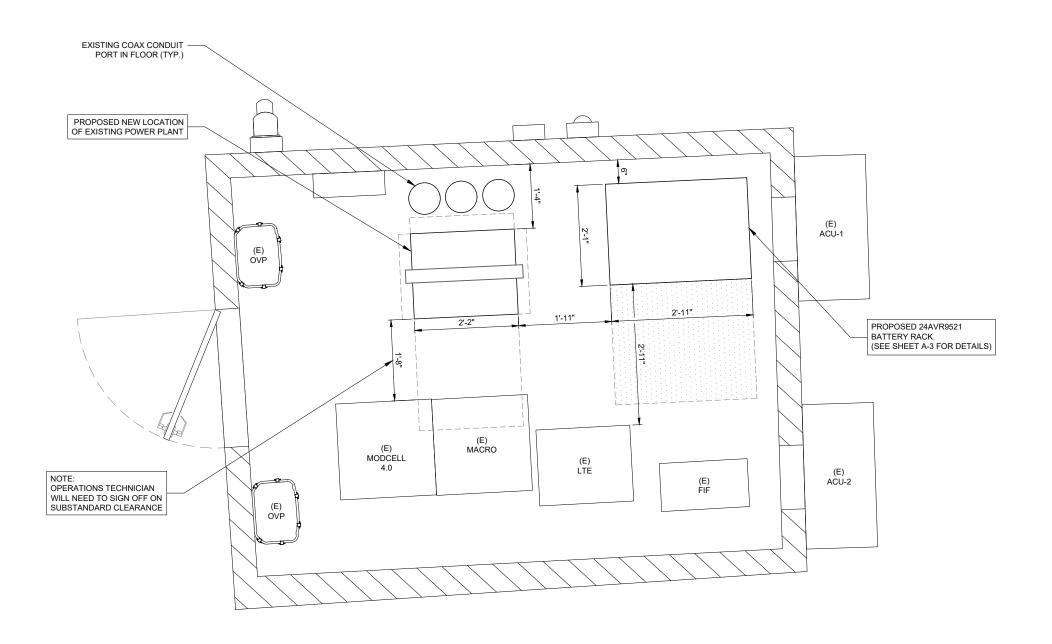





	REVISIONS		
Š.	DESCRIPTION	DATE	₽
	ISSUED FOR REVIEW	04/30/2021	APD
-	UPDATED PER POWER COORDINATION	06/04/2021	Ŧ
2.	UPDATED PER POWER COORDINATION	11/03/2021	APD
e,	ISSUED FOR FINALS	12/02/2021	KSS
4	REMOVED GENERATOR	09/08/2022	3

LOC. # 113278

WEST ROGERS WT

11515 W ROGERS ST MILWAUKEE, WI 53227

DRAWN BY:	JV
CHECKED BY:	DM
DATE:	03/24/2021
PROJECT #:	124-878

SHEET TITLE
PROPOSED
FLOOR PLAN

SHEET NUMBER

A-2

	Capacity	# of cells per module (3 wide)			# (# of cells per module (6 wide)				Donath?		II-laha	
Plate Number	C/8 @	Ler	ngth	We	ight	Lei	ıgth	Weight		Depth ²		Height	
	1.75 vpc	in	mm	lb	kg	in	mm	lb	kg	in	mm	in	mm
AVR9	5												
7	285					19.00	483	339	154				
9	380					23.50	597	426	194				
11	475					28.00	711	512	233				
13	570					32.50	826	600	273				
15	665					37.00	940	688	313				
17	760	21.90	556	404	184								
19	855	24.15	613	448	204					27.12	689	9.48	241
21	950	26.40	671	491	223								
23	1045	28.65	728	535	243								
25	1140	30.90	785	578	263								
27	1235	33.15	842	618	281								
29	1330	35.40	899	665	302								
31	1425	37.65	956	705	320					1			
33	1520	39.90	1013	749	340								

System Dimension

System Length = module length x # of stacks System Height' = (module height - 1.44) x(# of tiers high) + 4.00"


Example: 24AVR95-33 (3 wide x 8 high system) System Length = 39.90" x 1 stack = 39.90" System Height¹ = (9.48" - 1.44) x 8 + 4.00" = 68.32" 1 = Height includes base

² = Depth includes safety shield

Termination

Top Termination - Add 7.75" to overall height Side Termination - Add 4.50" for each side termination



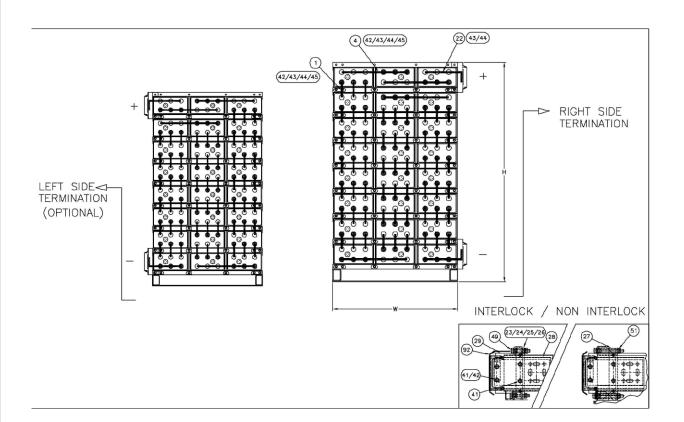







DATE BY				_				
REVISIONS DESCRIPTION ISSUED FOR REVIEW UPDATED FOR ROWER COORDINATION UPDATED FOR FOWER COORDINATION ISSUED FOR FINALS REMOVED GENERATOR		ВУ	APD	Ŧ	APD	KSS	λ.	
		DATE	04/30/2021	06/04/2021	11/03/2021	12/02/2021	09/08/2022	
	REVISIONS		ISSUED FOR REVIEW	UPDATED PER POWER COORDINATION	UPDATED PER POWER COORDINATION	ISSUED FOR FINALS	REMOVED GENERATOR	
II Z " " "		Š.		÷.	2	69	4	

LOC. # 113278

WEST ROGERS WT

11515 W ROGERS ST MILWAUKEE, WI 53227

 DRAWN BY:
 JV

 CHECKED BY:
 DM

 DATE:
 03/24/2021

 PROJECT #:
 124-878

SHEET TITLE

EQUIPMENT DETAILS

SHEET NUMBER

A-3

NOT USE



1 EXISTING METER



2 EXISTING METER & DISCONNECT SWITCH

NOT USED



EXISTING POWER PLANT TO BE RELOCATED



5 EXISTING BATTERY RACK TO BE REMOVED



6 EXISTING TRANSFORMER

1701 GOLF ROAD;
TOWER 2, SUITE 400
ROLLING MEADOWS, IL 60008
PHONE: (847) 706-7415



		REVISIONS		
Z	NO.	DESCRIPTION	DATE	
		ISSUED FOR REVIEW	04/30/2021	<
		UPDATED PER POWER COORDINATION	06/04/2021	
	2.	UPDATED PER POWER COORDINATION	11/03/2021	<
	3.	ISSUED FOR FINALS	12/02/2021	
4		REMOVED GENERATOR	09/08/2022	,

LOC. # 113278

WEST ROGERS WT

11515 W ROGERS ST MILWAUKEE, WI 53227

DRAWN BY:	JV
CHECKED BY:	DM
DATE:	03/24/2021
PROJECT #:	124-878

SHEET TITLE
PHOTO EXHIBIT

SHEET NUMBER

EX-1

verizon /

Radio Frequency Exposure FCC Compliance Assessment

☑ Pre-Activation □ Post-Activation

	SITE-SPECIFIC-INFORMATION							
Site Name	West Rogers WT	Multi-Licensee Facility	Yes					
Street Address	11515 W Rogers Street	Is Verizon a Significant						
City, State, Zip	Milwaukee, Wisconsin 53227	Contributor To Co-Locator Areas Requiring Mitigation?	No					
Verizon's Max % MPE	N/A	Verizon's Max % MPE	0.0900					
(Measured - Occupational)	IN/A	(Predictive - Occupational)	Occupational					
Structure Type	Water Tank	Assessment Date	N/A					
Broadcast (AM/FM/TV) Co-Locators	No	Assessment Purpose	Modification					
Total Access Points	Unknown	Total Report Revisions	0					
Original Report Date	October 19, 2021	Report Revision Date	N/A					
Compliance Status	Mitigation Required							

	VERIZON'S WORST-CASE RF EMISSIONS IN ACCESSIBLE AREAS AT THIS FACILITY
×	BELOW the General Population MPE limit
	ABOVE the General Population MPE limit and BELOW the Occupational MPE limit
	ABOVE the Occupational MPE limit and BELOW 10x the Occupational MPE limit
	ABOVE 10x the Occupational MPE limit

Final Compliant Configuration	A NOTICE of the part of the pa	NOTICE ((***)) ((**	CAUTION Section 1 Section 2 Section	WARNING Was to see the second of the second	INFORMATION This was ACCESS PORT to are present in forecasting enterests, forecasting enter		M
	GUIDELINES	NOTICE	CAUTION	WARNING	NOC INFO	В	ARRIER/MARKER
Access Point(s)	[1]				⊠[1]		
Alpha							
Beta							
Gamma							


NOTE: The table above represents EVERY compliance item that MUST be implemented at this location; Also in Sec. 4 (B)

Additional Compliance Requirements:

There are no barriers recommended on this site. Barriers are not recommended for installation because there are no exceedances on any walking/working surface. Signage is recommended at the access points and/or the Verizon antennas as noted in the table above. To reduce the risk of exposure and/or injury, EBI recommends that access to the water tank or areas associated with the active antenna installation be restricted and secured where possible.

Consultant Legal Name	EBI Consulting	Phone/Fax	781-273-2500
Address	21 B Street, Burlington, MA 01803	3	

b. Signage/Barrier Diagram

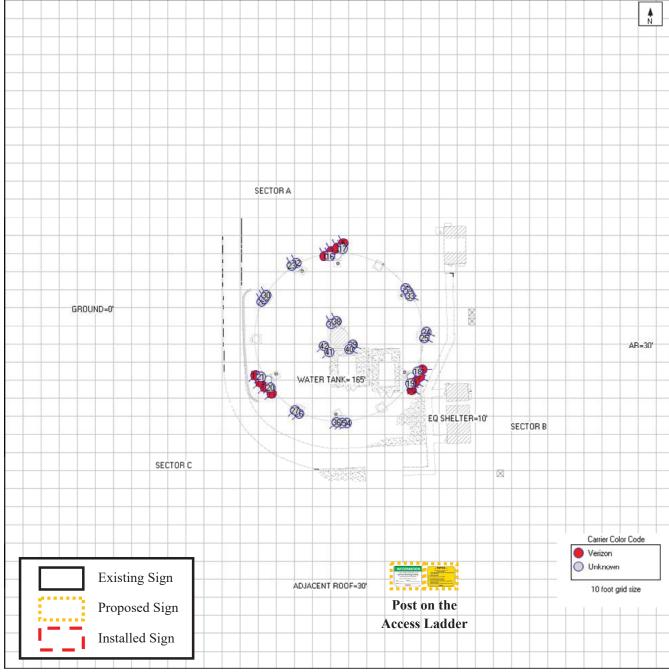

Final Compliant Configuration	NOTICE (more flesh requiring PP) (more flesh r	NOTICE Washington Washin Washington Washington Washington Washington Washington Wa	CAUTION The state of the state	WARNING The state of the state	INFORMATION This is a ACCIST-POINT to an extra with transcribing unknown, which is a contract of the transcribing unknown, which is a contract of the transcribing unknown and transcribe unknown and transcri		M
	GUIDELINES	NOTICE	CAUTION	WARNING	NOC INFO	В	ARRIER/MARKER
Access Point(s)	⊠[1]				⊠[1]		
Alpha							
Beta							
Gamma							

NOTE: The table above represents EVERY compliance item that MUST be implemented at this location.

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c. Signage/Barrier Installation Detail

Mitigation Actions Required/Taken	General Badia Badia S. Data A.: opposition of the state	un han han kunikutui, giassa suunding getensi getensi pi, kunius, se olaal matari, pingafia sansa E tiasa an an	((<u>~</u>))		A =	The following common that the following comm	A =	- Control of the Cont	This is an ACC area with transmin to the desired area of the series area of the series area of the series are of the series are on the ser	reference i Pitagene Militario reconstitutario. Militari		M
	GUIDE	LINES	NOT	TICE	CAU	ΓΙΟN	WAR	NING	NOC	INFO	BAR	RIER/MARKER
Access Point(s)	$\boxtimes [1]$								$\boxtimes [1]$			
Alpha												
Beta												
Gamma												
	ADD	REM	ADD	REM	ADD	REM	ADD	REM	ADD	REM	A	DD ONLY

NOTE: The table represents either the signage/barriers installed / removed OR items required by the market (if mitigation is not installed by consultant/vendor).

SPECIAL MITIGATION INSTRUCTIONS					
Items to be Installed	Install GUIDELINES and NOC INFO signs on the water tank access ladder.				
Items to be Removed	N/A				
Items to be Repaired/Replaced	N/A				
Access Requirements	To reduce the risk of exposure and/or injury, EBI recommends that access to the water tank or areas associated with the active antenna installation be restricted and secured where possible.				

Barriers are not recommended for installation because there are no exceedances on any walking/working surface.

c. RF Signage

Areas or portions of any transmitter site may be susceptible to high power densities that could cause personnel exposures in excess of the FCC guidelines. These areas must be demarcated by conspicuously posted signage that identifies the potential exposure. Signage must be viewable regardless of the viewer's position. Signs must be legible and readily viewable and readable at a minimum distance of five feet (1.52 meters) from the boundary (and as necessary on approach to this boundary) at which the applicable limits are exceeded, and that controls or indicators be placed at compliance boundaries. The minimum readable letter height at 5 feet from the signage is 0.20 inches for the Message and 0.44 inches for the Signal.

GUIDELINES	NOTICE	CAUTION	WARNING		
This sign will inform anyone of the basic recautions to follow when an access point to a rarea with transmitting adiofrequency equipment. This sign indicates that RF emissions may exceed the FCC General Population MPE limit.		This sign indicates that RF emissions may exceed the FCC Occupational MPE limit.	This sign indicates that RF emissions may exceed at least 10x the FCC Occupational MPE limit.		
A NOTICE General Radio Frequency (RF) Safety Guidelines Until ALL applicable antennas have been deactivated, please observe the following:	Transmitting Antenna(s) Radio frequency fields beyond this point MAY Excito the PCC owners Population exposure Call Vertices at 1-80-264-6420/RIOR to Septiment States and sine guidelines. Call Vertices at 1-80-264-6420/RIOR to Septiment States and sine publications. Setting Symposium. SECTION/NEOSE: Vertizon Vertizon	Transmitting Antenna(s) Transmitting Antenna(s) Radio frequency fletch beyond this point MAY EXECUTION TO THE CONTROL OF THE	Transmitting Antenna(s) Radio Inequancy fields beyond this point RECED the FCC Congressional exposure limit. Obey all posted signs and site guidelines. Colley all posted signs and site guidelines. Obey all posted signs and site guidelines. SITE 0: SHITCH SITE 0: SHI		

NOC INFORMATION

Information signs are used as a means to provide contact information for any questions or concerns. They will include specific cell site identification information and the Verizon Wireless Network Operations Center phone number.



d. Physical Barriers

Physical barriers are control measures that require awareness and participation of personnel. Physical barriers are employed as an additional administration control to complement RF signage and physically demarcate an area in which RF exposure levels may exceed the FCC General Population limit. Example: chain-connected stanchions

e. Indicative Markers

Indicative markers are visible control measures that require awareness and participation of personnel, as they cannot physically prevent someone from entering an area of potential concern. Indicative markers are employed as an additional administration control to complement RF signage and visually demarcate an area in which RF exposure levels may exceed the FCC General Population limit. Example: paint stripes

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WEST > Upper Midwest > Illinois/Wisconsin > Wisconsin > WEST ROGERS WT

Patel, Dhwani - dhwani.patel@verizonwireless.com - 6/14/2021 11:38:7

Project Details
FUZE Project ID: 16233638
Project Name: 5G L-Sub6 - Carrier Add
Project Alt Name:
Project Type: Modification
Modification Type: RF
Designed Sector Carrier 4G: 18
Designed Sector Carrier 5G: 3
Additional Sector Carrier 4G: N/A
Additional Sector Carrier 5G: N/A
FP Solution Type & Tech Type: MODIFICATION;4G_AWS3,4G_CBRS,5G_L-Sub Prep
Carrier Aggregation: false
MPT Id:
eCIP-0: false
Suffix:

nwireless.com - 6/14/2021 11:38:7	
Location Information	
Site ID: 698801	
E-NodeB ID: 209323,2099323,2099411,0209323	
PSLC: 113278	
Switch Name: New Berlin	
Tower Owner:	
Tower Type: Tank	
Site Type: MACRO	
Site Sub Type: TRADITIONAL	
Street Address: 11515 W Rogers St	
City: Milwaukee	
State: WI	
Zip Code: 53227	
County: MILWAUKEE	
Latitude: 43.007861 / 43° 0' 28.2996" N	
Longitude: -88.056083 / 88° 3' 21.8988" W	

RFDS Project Scope:

Proprietary and Confidential. Not for disclosure outside of Verizon.

Page 1 of 10

Added														
quipment Type	Location	700	1900	AWS	AWS3	CBRS	L-Sub6	Make	Model	Cable Length	Cable Size	Install Type	Quantity	
Diplexer	Tower							Commscope	CDX1923Q-DS-43			PHYSICAL	3	
RRU	Tower					LTE		Ericsson	4408 B48			PHYSICAL	3	
RRU	Tower	LTE						Ericsson	4449			PHYSICAL	3	
RRU	Tower			LTE	LTE			Ericsson	8843			PHYSICAL	3	
RRU	Tower						5G	Ericsson	AIR6449			PHYSICAL	3	
OVP Box	Tower							Raycap	3315			PHYSICAL	3	
OVP Box	Shelter							Raycap	6627			PHYSICAL	1	
Removed														
Equipment Type	Location	700	1900	AWS	AWS3	CBRS	L-Sub6	Make	Model	Cable Length	Cable Size	Install Type	Quantity	
Coaxial Cables	Tower							Andrew	Coax		15/8"	PHYSICAL	3	
OVP Box	Tower							Commscope	1064			PHYSICAL	3	
BAIST	Tower							Commscope	ATSBT-TOP-MF (Bias-T)			PHYSICAL	3	
Diplexer	Tower							Commscope	DBC-7CAP			PHYSICAL	6	
RRU	Tower			LTE				Ericsson	RRUS12 B4			PHYSICAL	3	
RRU	Tower	LTE						Ericsson	RUL01 B13			PHYSICAL	6	
Diplexer	Shelter							Commscope	DBC-7CAP			PHYSICAL	6	
Retained														
Equipment Type	Location	700	1900	AWS	AWS3	CBRS	L-Sub6	Make	Model	Cable Length	Cable Size	Install Type	Quantity	
Coaxial Cables	Tower							Andrew	Coax		15/8"	PHYSICAL	6	
Hybrid Cable	Tower							Commscope	6x12			PHYSICAL	3	
RRU	Move to Tower		LTE 5G					Ericsson	8843			PHYSICAL	3	


Proprietary and Confidential. Not for disclosure outside of Verizon.


CDMA	CDMA CDMA CDMA CDMA CDMA CDMA CDMASCOPE NHH-65C-R2B 101 104.1 330(0) 161se 161se PHYSICAL 6 CDMASCOPE NHH-65C-R2B 101 105 230(03) 161se 161se PHYSICAL 6 CDMASCOPE CDMASCOPE NHH-65C-R2B 101 105 230(03) 161se 161se PHYSICAL 6 CDMASCOPE CDMASCOPE NHH-65C-R2B 101 105 230(03) 161se 161se PHYSICAL 3 CDMASCOPE CDMASCOPE NHH-65C-R2B 101 105 230(03) 161se 161se PHYSICAL 3 CDMASCOPE CDMASCOPE CDMASCOPE NHH-65C-R2B 101 103 104.3 230(003) 161se 161se PHYSICAL 3 CDMASCOPE CDMASC	Added															
CDMA	CDMA	700	1900	AWS	AWS3	CBRS	L-Sub6	Make	Model	Centerline	Tip Height		RET	4xRx	Inst. Type	Quantity	
LTE SG LTE LTE LTE COMMSCOPE NHH-65C-R2B 101 105 230(03) false false PHYSICAL 0 LTE ERICSSON 4408 3400 (1569634) 99 99.3 230(03) false false PHYSICAL 3 Removed Re	LTE		CDMA					ANDREW	HBX-9016DS-VTM	101	104.1	230(D3)	false	false	PHYSICAL	3	
LTE	CDMA	LTE	LTE 5G	LTE	LTE			COMMSCOPE	NHH-65C-R2B	101	105	230(03)	false	false	PHYSICAL	6	
False Physical 3 3 3 3 3 3 3 3 3	Removed					LTE		ERICSSON		99	99.3	230(03)	false	false	PHYSICAL	3	
AWS AWS CBRS L-Sub6 Make Model Centerline Tip Height Azimuth RET 4xRx Inst. Type Quantity	AWS AWS CBRS L-Sub6 Make Model Centerline Tip Height Azimuth RET 4xRx Inst. Type Quantity						5G	Ericsson	AIR6449	103	104.3	230(0003)	false	false	PHYSICAL	3	
LTE	AWS AWS CBRS L-Sub6 Make Model Centerline Tip Height Azimuth RET 4xRx Inst. Type Quantity																
LTE	LTE			41410	41100	oppo	1.0-1-0	Mala	M. 4.1	0	The Hadala	A	DET	4	to at Tona	0	
CDMA	CDMA	700	1900	AWS	AW53	CBRS	L-Subb	маке	Model	Centerline	TIP Height		KEI	4XKX	inst. Type	Quantity	
CDMA CDMA KATHREIN API7-1900/090D 103 105.7 230(003)	CDMA CDMA KATHREIN KATHREIN API7-1900/090D (141325) 103 105.7 230(03) 230(003) 230(003) 330(001) 330(01) 330(01) 330(01) 330(01) 330(01) 300(01) 330(01) 300(0	LTE		LTE				ANDREW	DBXNH-6565B-VTM	103	106	230(03)	false	false	PHYSICAL	3	
700 1900 AWS AWS3 CBRS L-Sub6 Make Model Centerline Tip Height Azimuth RET 4xRx Inst. Type Quantity	700 1900 AWS AWS3 CBRS L-Sub6 Make Model Centerline Tip Height Azimuth RET 4xRx Inst. Type Quantity No data available.		CDMA					KATHREIN		103	105.7	90(02) 90(D2) 230(0003) 230(03) 230(D3) 330(0001) 330(01)	false	false	PHYSICAL	6	
700 1900 AWS AWS3 CBRS L-Sub6 Make Model Centerline Tip Height Azimuth RET 4xRx Inst. Type Quantity	700 1900 AWS AWS3 CBRS L-Sub6 Make Model Centerline Tip Height Azimuth RET 4xRx Inst. Type Quantity No data available.	n-t-i															
	No data available.			AWS	AWS3	CBRS	L-Sub6	Make	Model	Centerline	Tip Height	Azimuth	RET	4xRx	Inst. Type	Quantity	
																•	

			Service Info			
700 MHz LTE		0001			5GLS	
Sector	01	02	03	01	02	03
Azimuth Cell / ENode B ID	330 209323	120 209323	230 209323	330 209323	120 209323	230 209323
Antenna Model	DBXNH-6565B-VTM	DBXNH-6565B-VTM	DBXNH-6565B-VTM	NHH-65C-R2B	NHH-65C-R2B	NHH-65C-R2B
Antenna Make	ANDREW	ANDREW	ANDREW	COMMSCOPE	COMMSCOPE	COMMSCOPE
Antenna Centerline(Ft) Mechanical Down-Tilt(Deg.)	103 0	103 0	103 0	101 0	101 0	101 0
Electrical Down-Tilt	4	9	6	4	8	6
Tip Height	106	106	106	105	105	105
Regulatory Power	70.59	79.94	67.11	196.72	190.69	191.05
Total ERP (W) TMA Make						
TMA Model						
RRU Make	Ericsson	Ericsson	Ericsson	Ericsson	Ericsson	Ericsson
RRU Model Number of Tx, Rx Lines	2xRUL01 B13 2,2	2xRUL01 B13 2,2	2xRUL01 B13 2,2	4449 4,4	4449 4,4	4449 4,4
Position						
Transmitter Id	9945498	9945500	9945502	7889875	7889879	7889883
Source	ATOLL_API	ATOLL_API	ATOLL_API	ATOLL_API	ATOLL_API	ATOLL_API
1900 MHz LTE		0001			5GLS	
Sector	01	02	03	01	02	03
Azimuth Cell / ENode B ID	330 209323	90 209323	230 209323	330 209323	120 209323	230 209323
Antenna Model	AP17-1900/090D (141325)	AP17-1900/090D (141325)	AP17-1900/090D (141325)	209323 NHH-65C-R2B	209323 NHH-65C-R2B	209323 NHH-65C-R2B
Antenna Make	KATHREIN	KATHREIN	KATHREIN	COMMSCOPE	COMMSCOPE	COMMSCOPE
Antenna Centerline(Ft) Mechanical Down-Tilt(Deg.)	103 0	103 0	103 1	101 0	101 0	101 0
Electrical Down-Tilt	0	0	Ô	4	4	4
Tip Height	105.7	105.7	105.7	105	105	105
Regulatory Power	328.08	328.08	328.08	443.58	443.58	443.58
Total ERP (W) TMA Make						
TMA Model						
RRU Make	Ericsson	Ericsson	Ericsson	Ericsson	Ericsson	Ericsson
RRU Model Number of Tx, Rx Lines	8843 2,2	8843 2,2	8843 2,2	8843 4,4	8843 4,4	8843 4,4
Position	2,2	2,2	2,2	4,4	4,4	4,4
Transmitter Id	9945511	9945518	9945524	7889876	7889880	7889884
Source	ATOLL_API	ATOLL_API	ATOLL_API	ATOLL_API	ATOLL_API	ATOLL_API
1900 MHz CDMA		0001			5GLS	
Sector	D1	D2	D3	D1	D2	D3
Azimuth Cell / ENode B ID	330	90	230	330	90	230
Antenna Model	AP17-1900/090D (141325)	AP17-1900/090D (141325)	AP17-1900/090D (141325)	HBX-9016DS-VTM	HBX-9016DS-VTM	HBX-9016DS-VTM
Antenna Make	KATHREIN	KATHREIN	KATHREIN	ANDREW	ANDREW	ANDREW
Antenna Centerline(Ft)	103	103	103	101	101	101
Mechanical Down-Tilt(Deg.) Electrical Down-Tilt	0	0	1 0	0	0	0
Tip Height	105.7	105.7	105.7	104.1	104.1	104.1
Regulatory Power	197.34	312.76	197.34	441.79	441.79	441.79
Total ERP (W)						
TMA Make TMA Model						
RRU Make						
RRU Model						
Number of Tx, Rx Lines Position						
Transmitter Id	9945505	9945507	9945509	7889888	7889890	7889892
Source	ATOLL_API	ATOLL_API	ATOLL_API	ATOLL_API	ATOLL_API	ATOLL_API

0002 90 2099411 AP17-1900,0900 (141325) KATHREIN 103 0 105.7 328.08 Ericsson 8843 2,2 9945530 ATOLL, API 0001 02 120 209323 DBXNN+65658-VTM ANDREW 103 0 0 0 0 0 0 0 0 0 0 0 0 0 0 0 0 0 0	0003 230 230 2099411 AP17-19000/9900 (141325) KATHREIN 103 1 0 105.7 328.08 Ericsson 8843 2,2 9945531 ATOLL_API 03 230 209323 DBXNH-6565B-VTM	0001 330 2099323 NHH-65C-R2B COMMSCOPE 101 0 4 104.99916666667 420.24 Ericsson B843 4,4 7889758 ATOLL_API 01 330 209323	0002 120 2099323 NHH-65C-R2B COMMSCOPE 101 0 4 104.99916666667 420.24 Ericsson 8843 4,4 7889759 ATOLL_API 60L5 02	0003 2:30 2:099323 NHH-65C-R28 COMMSCOPE 101 0 4 104.999166666667 420.24 Ericsson 8843 4,4 7.889760 ATOLL_API
2099411 AP17-1900/0900 L41325) KATHREIN 103 0 0 105.7 328.08 Ericsson 8843 2:2 9945530 ATOLL_API 0001 02 02 03 200323 DBXNH-6565B-VTM ANDREW 103	2099411 AP17-10900/900 (141325) KATHREIN 103 1 0 105.7 328.08 Ericsson 8843 2,2 9945531 ATOLL API 03 230 209323 DBXNH-65658-VTM	2099323 NHH-65C-R2B COMMSCOPE 101 0 4 104.999166666667 420.24 Ericsson 8843 4,4 7889758 ATOLL_API	2099323 NHH-65C-R2B COMMSCOPE 101 0 1 104.999156666667 420.24 Ericsson 8843 4,4 7889759 ATOLL_API 50LS	2099323 NHH-65C-R2B COMMSCOPE 101 0 4 4 104-9916666667 420.24 Ericsson 8843 4,4 7889760
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328.08 Ericsson 8843 2,2 9945530 ATOLL API 0001 02 120 209323 DBXNH-65658-VTM ANDREW 103	328.08 Ericsson 8843 2.2 9945531 ATOLL_API 03 230 209323 DBXNH-6565B-VTM	420.24 Ericson 8843 4,4 7889758 ATOLL_API 01 330	420.24 Ericsson 8843 4,4 7889759 ATOLL_API 5GLS	420.24 Ericsson 8843 4,4 7889760
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ATOLL_API 0001 02 120 209323 DBXNH-6565B-VTM ANDREW 103	03 230 29323 DBXNH-6565B-VTM	ATOLL_API 01 330	ATOLL_API 5GLS	
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02 120 209323 DBXNH-6565B-VTM ANDREW 103	230 209323 DBXNH-6565B-VTM	330		
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ANDREW 103			209323	209323
103		NHH-65C-R2B	NHH-65C-R2B	NHH-65C-R2B
	ANDREW	COMMSCOPE	COMMSCOPE	COMMSCOPE
	103	101	101	101
	0	0	0	0
2	0	0	2	0
106 243.13	106 243.13	105 316.19	105 353.87	105 316.19
243.13	243.13	310.19	333.07	310.19
Ericsson	Ericsson	Ericsson	Ericsson	Ericsson
RRUS12 B4	RRUS12 B4	8843	8843	8843
2,2	2,2	4,4	4,4	4,4
	9945503			7889885 ATOLL_API
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		330	120	230
				209323
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		00111100000	COMMISSION	COMMSCOPE
				101
				0
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		105	105	105
		501.46	501.46	501.46
		E4	F4	F4
		Ericsson	ERICSSON	Ericsson 8843
				8843 4,4
		4,4	4,4	4,4
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Station				
Sector 0001				
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Antenna Make Antenna Genterina (Pt) Antenna Make Antenna	Sector	0001	0002	0003
Antenna Make Antenna Genterina (Pt) Antenna Make Antenna	Azimuth	330	120	230
Antenna Make Antenna Genterina (Pt) Antenna Make Antenna	Cell / ENode B ID	0209323	0209323	0209323
Antenna Centerline(Ft) Mechanical Down-Till (Te) Belcrical Down-Till Fulght Belcrical Down-Till Fulght Belgulatory Power Total ERP (W) TTMA Make TMA MAKE TM	Antenna Model	AIR6449	AIR6449	AIR6449
Antenna Centerline(Ft) Mechanical Down-Till (Te) Belcrical Down-Till Fulght Belcrical Down-Till Fulght Belgulatory Power Total ERP (W) TTMA Make TMA MAKE TM				
Mechanical Down-Tilt(Deg)	Antenna Make	Ericsson	Ericsson	Ericsson
Electrical Down-Tilt	Antenna Centerline(Ft)	103	103	103
Tip Height 104.3 104.3 104.3 Regulatory Power 2711.04 2711.04 2711.04 2711.04 Total ERP (W) THA Make 2711.04 2711.04 2711.04 RRU Make 3711.04 2711.04 RRU Make 471.04 RRU Make 571.04 571.04 RRU Make 671.05 571.05	Mechanical Down-Tilt(Deg.)	0	0	0
Regulatory Power 271.04	Electrical Down-Tilt	6	6	6
TMA Make TMA Model RRU Make RRU Make RRU Model Alf6449	Ip Height	104.3	104.3	104.3
TMA Make TMA Model RRU Make RRU Make RRU Model Alf6449	Hegulatory Power	2/11.04	2/11.04	2/11.04
TMA Model RRU Make Ericsson Ericsson RRU Model AIR6449 AIR6449 AIR6449 Number of Tx, Rx Lines 4,4 4,4 4,4 Position 761995 761996 7461997 Transmitter Id 7461995 7461996 7461997 Source ATOLL, API ATOLL, API ATOLL, API	TMA Mel-			
RRU Make Ericsson Ericsson Ericsson Ericsson RRU Make RU Model Alf8649	TMA Model			
RRU Model AIR6449 AIR6449 Number of T. Rx Lines 4, 4, 4 4, 4 4, 4 Position Transmitter Id 746195 7461996 7461997 Source ATOLL_API ATOLL_API ATOLL_API ATOLL_API	RRII Make	Fricsson	Fricsson	Fricsson
Number Of Tx, Fix Lines 4.4 4.4 4.4 Position 7461995 7461996 7461996 Transmitter Id 7461995 7461996 7461996 Source ATOLL,API ATOLL,API ATOLL,API	RRII Model	AIR6449	AIR6449	AIR6449
Position 7461995 7461996 7461997 Transmitter Id ATOLL_API ATOLL_AP	Number of Tv. Rv Lines	A A	A A	4.4
Transmitter Id 7461995 7461996 7451997 Source ATOLL_API ATOLL_API<	Position	4,4		7,7
Source ATOLLAR	Transmitter Id	7461995	7461996	7461997
de Connetos	Source	ATOLL API	ATOLL API	ATOLL API
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l Confidential. Not for disclosure outside of Verizon.				



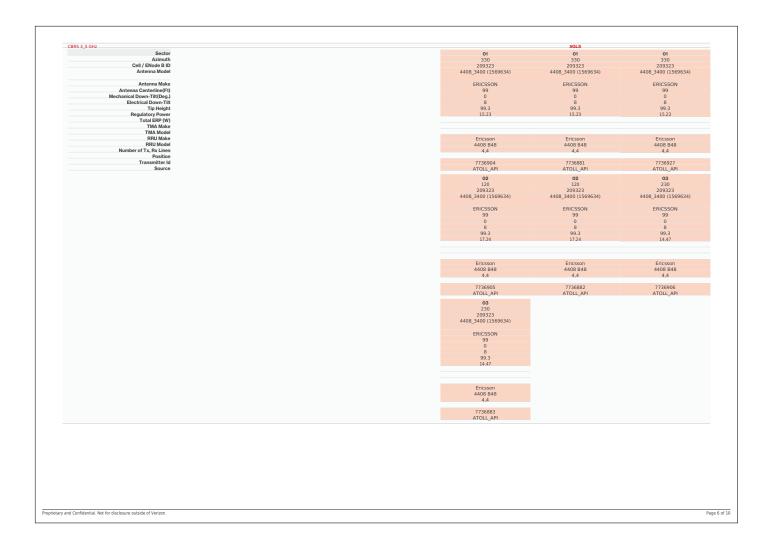

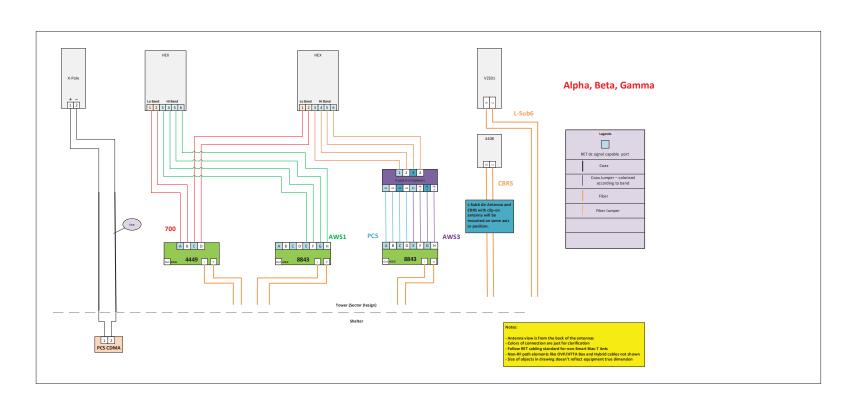



Paul J. Ford and Company 250 East Broad Street Suite 600 Columbus, OH 43215 (614) 221-6679 PJFmount@pauljford.com

Post-Modification Antenna Mount Analysis Report and PMI Requirements

Mount Fix

SMART Tool Project #: 10170920

Paul J. Ford Project #: 24322-2340.001.8189

September 28, 2022

<u>Site Information</u> Site ID: 113278-VZW / WEST ROGERS WT -- 698801

Site Name: WEST ROGERS WT -- 698801

Carrier Name: Verizon Wireless Address: 11515 W Rogers St

Milwaukee, Wisconsin 53227, Milwaukee

County County

Latitude: 43.007900° Longitude: -88.056080°

<u>Structure Information</u> Tower Type: 181-Ft Water Tank

Mount Type: 12.50-Ft Sector Frame

FUZE ID # 16233638

Analysis Results

12.50-Ft Sector Frame: 79.3% Pass w/ Modifications*

*Antennas and equipment to be installed in compliance with PMI Requirements of this mount analysis.

***Contractor PMI Requirements:

Included at the end of this MA report
Available & Submitted via portal at https://pmi.vzwsmart.com
For additional questions and support, please reach out to:
pmisupport@pauljford.com

Report Prepared By: Brandon Saline

KAT



Executive Summary:

The objective of this report is to summarize the analysis results of the antenna support mount including the proposed modifications at the subject facility for the final wireless telecommunications configuration, per the applicable codes and standards.

This analysis is inclusive of the mount structure only and does not address the structural capacity of the supporting structure. This mounting frame was not analyzed as an anchor attachment point for fall protection. All climbing activities are required to have a fall protection plan completed by a competent person.

Sources of Information:

Document Type	Remarks
Radio Frequency Data Sheet (RFDS)	Verizon RFDS, 16233638, dated April 10, 2022
Previous Mount Analysis Report	Paul J. Ford, Project # 24320-0436.002.8190, dated December 22, 2020
Mount Mapping Report	SGS Tower, Project # 698801, dated November 24, 2020
Proposed Mount Modification	Paul J. Ford, Project # 24322-2340.001.8189, dated September 28, 2022

Analysis Criteria:

Codes and Stan	ıdards: ANS	I/TIA-222-H
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Codes and Standards.	ANOI/11A-222-11	
Wind Parameters:	Basic Wind Speed (Ultimate 3-sec. Gust), Vult: Ice Wind Speed (3-sec. Gust): Design Ice Thickness: Risk Category: Exposure Category: Topographic Category: Topographic Feature Considered: Topographic Method: Ground Elevation Factor, Ke:	114 mph 40 mph 1.50 in III C 1 N/A N/A 0.973
Seismic Parameters:	Ss: S ₁ :	0.076 g 0.048 g
Maintenance Parameters:	Wind Speed (3-sec. Gust): Maintenance Live Load, Lv: Maintenance Live Load, Lm:	30 mph 0 lbs. 0 lbs.
Analysis Software:	RISA-3D (V17.0.3)	

Final Loading Configuration:

The following equipment has been considered for the analysis of the mounts:

Mount Elevation (ft)	Equipment Elevation (ft)	Quantity	Manufacturer	Model	Status
	103.00	3	Ericsson	AIR 6449	Added
		3	Ericsson	8843	Retained
		6	Commscope	NHH-65C-R2B	
		3	Commscope	CDX1923Q-DS-43	
101.00±	101.00	3	Ericsson	4449	
		3	Raycap	RC3DC-3315-PF-48	Added
		3	Ericsson	8843	
		3	Andrew	HBX-9016DS-VTM	
	99.00	3	Ericsson	4408 w/ KRE 105 281/1	

The recent mount mapping reported existing OVP units. It is acceptable to install up to any three (3) of the OVP model numbers listed below as required at any location other than the mount face without affecting the structural capacity of the mount. If OVP units are installed on the mount face, a mount re-analysis may be required unless replacing an existing OVP.

Model Number	Ports	AKA
RHSDC-1064-PF-48	2	OVP-2
RC3DC-3315-PF-48	6	OVP-6
RC3DC-3300-PF-48	6	OVP-6
RC3DC-4750-PF-48	6	OVP-6
RHSDC-6627-PF-48	12	OVP-12
RHSDC-6600-PF-48	12	OVP-12

Standard Conditions:

- All engineering services are performed on the basis that the information provided to Paul J. Ford and Company and used in this analysis is current and correct. The existing equipment loading has been applied at locations determined from the supplied documentation. Any deviation from the loading locations specified in this report shall be communicated to Paul J. Ford and Company to verify deviation will not adversely impact the analysis.
- 2. Mounts are assumed to have been properly fabricated, installed and maintained in good condition, twist free and plumb in accordance with its original design and manufacturer's specifications.

Obvious safety and structural issues/deficiencies noticed at the time of the mount mapping and reported in the Mount Mapping Report are assumed to be corrected and documented as part of the PMI process and are not considered in the mount analysis.

The mount analysis and the mount mapping are not a condition assessment of the mount. Proper maintenance and condition assessments are still required post analysis.

 For mount analyses completed from other data sources (including new replacement mounts) and not specifically mapped in accordance with the NSTD-446 Standard, the mounts are assumed to have been properly fabricated, installed and maintained in good condition, twist free and plumb in accordance with its original design and manufacturer's specifications.

- 4. All member connections are assumed to have been designed to meet or exceed the load carrying capacity of the connected member unless otherwise specified in this report.
- 5. The mount was checked up to, and including, the bolts that fasten it to the mount collar/attachment and threaded rod connections in collar members if applicable. Local deformation and interaction between the mount collar/attachment and the supporting tower structure are outside the scope of this analysis.
- 6. All services are performed, results obtained, and recommendations made in accordance with generally accepted engineering principles and practices. Paul J. Ford and Company is not responsible for the conclusion, opinions, and recommendations made by others based on the information supplied.
- 7. Structural Steel Grades have been assumed as follows, if applicable, unless otherwise noted in this analysis:

Channel, Solid Round, Angle, Plate
 HSS (Rectangular)
 Pipe
 Threaded Rod
 Bolts
 ASTM A36 (Gr. 36)
 ASTM 500 (Gr. B-46)
 ASTM A53 (Gr. B-35)
 F1554 (Gr. 36)
 ASTM A325

8. Any mount modifications listed under Sources of Information are assumed to have been installed per the design specifications.

Discrepancies between in-field conditions and the assumptions listed above may render this analysis invalid unless explicitly approved by Paul J. Ford and Company.

Analysis Results:

Component	Utilization %	Pass/Fail
Face Horizontals	71.8%	Pass
Standoff Members	16.5%	Pass
Tie Backs	7.9%	Pass
Mount Pipes	61.5%	Pass
Mount to Tower Connection	79.3%	Pass

Structure Rating – (Controlling Utilization of all Components)	79.3%	

Mount Steel (EPA)a per ANSI/TIA-222-H Section 2.6.11.2:

Ice	Mount Pipe	s Excluded	Mount Pipes Included					
Thickness (In)	Front (EPA)a (Sq. Ft.)	Side (EPA)a (Sq. Ft.)	Front (EPA)a (Sq. Ft.)	Side (EPA)a (Sq. Ft.)				
0	34.3	29.5	52.6	47.7				
0.5	43.3	47.7	74.8	68.0				
1	54.2	59.9	95.0	86.3				

Notes:

- (EPA)a values listed above may be used in the absence of more precise information
- (EPA)a values in the table above include 3 sector(s).
- Ka factors included in (EPA)a calculations

Requirements:

The existing mounts will be **SUFFICIENT** for the final loading configuration (attachment 2) after the modifications detailed in attachment 3 are successfully completed.

ANSI/ASSP rigging plan review services compliant with the requirements of ANSI/TIA 322 are available for a Construction Class IV site or other, if required. Separate review fees will apply.

Attachments:

- 1. Contractor Required PMI Report Deliverables
- 2. Antenna Placement Diagrams
- 3. Mount Modification Drawings
- 4. Mount Photos
- 5. Mount Mapping Report (for reference only)
- 6. Analysis Calculations

Mount Desktop – Post Modification Inspection (PMI) Report Requirements

Documents & Photos Required from Contractor – Mount Modification

Electronic pdf version of this can be downloaded at https://pmi.vzwsmart.com
For additional questions and support, please reach out to pmisupport@pauliford.com

PSLC #: 113278 SMART Project #: 10170920 Fuze Project ID: 16233638

<u>Purpose</u> – to upload the proper documentation to the SMART Tool in order to allow the SMART Tool engineering vendor to complete the required Mount Desktop review of the Post Modification Inspection Report.

- Contractor is responsible for making certain the photos provided as noted below provide confirmation that the modification was completed in accordance with the modification drawings.
- Contractor shall relay any data that can impact the performance of the mount or the mount modification, this includes safety issues.

Base Requirements:

- If installation of the modification will cause damage to the structure, the climbing facility, or safety climb if present or any installed system, SMART Tool vendor to be notified prior to install. Any special photos outside of the standard requirements will be indicated on the drawings.
- Provide "as built drawings" showing contractor's name, preparer's signature, and date. Any deviations from the drawings (proposed modification) shall be shown. NOTE: If loading is different than what is conveyed in the post-modification passing mount analysis (MA) contact the SMART Tool vendor immediately.
- Each photo shall be time and date stamped.
- Photos should be high resolution.
- Contractor shall ensure that the safety climb wire rope is not adversely impacted by the install
 of the modification components. This may involve the install of wire rope guides, or other items
 to protect the wire rope. If there is conflict, contact the SMART Tool engineer for
 recommendations.
- The PMI can be accessed at the following portal: https://pmi.vzwsmart.com

Photo Requirements:

- Photos taken at ground level
 - o Photo of Gate Signs showing the tower owner, site name, and number.
 - Overall tower structure after installation of the modifications.
 - Photos of the mount after installation of the modifications; if the mounts are at different rad elevations, pictures must be provided for all elevations that the modifications were installed

• Photos taken at Mount Elevation

- Photos showing the safety climb wire rope above and below the mount prior to modification.
- Photos showing the climbing facility and safety climb if present.

- Photos showing each individual sector after installation of modifications. Each entire sector must be in one photo to show the interconnection of members.
 - These photos shall also certify that the placement and geometry of the equipment on the mount is as depicted in the antenna placement diagram in this form.
- Photos that show the model number of each antenna and piece of equipment installed per sector.
- Photos of each installed modification per the modification drawings; pictures shall also include connection hardware (U-bolts, bolts, nuts, all-threaded rods, etc.)
- Photos showing the distances (relative distance between collars) of the installed modifications from the appropriate reference locations shown in the modification drawings.
- Photos showing the installed modifications onto the tower (i.e. ring/collar mounts, tiebacks, V-bracing kits, etc.); if the existing mount elevation needs to be changed according to the modification drawings, an elevation measurement shall be provided before the elevation change.

Material Certification:

- Materials utilized must be as per specification on the drawings or the equivalent as validated by the SMART Tool vendor.
 - If the materials are as specified on the drawings
 - The contractor shall provide the packing list, or the materials certifications for the materials utilized to perform the mount modification
 - Commscope, Metrosite, Perfect Vision, Sabre, and Site Pro have all agreed to support Verizon vendors with the necessary material certifications
 - If seeking permission to use an equivalent
 - It is required that the SMART Tool engineering vendor approval of such is included in the contractor submission package. There may be an additional

charge for approval if the equivalent submission doesn't meet specifications as prescribed in the drawings.						
\square All hardware has been properly installed, and the existing hardware was inspected.						
☐ The material utilized was as specified on the SMART Tool engineering vendor Mount Modification Drawings and included in the material certification folder is a packing list or invoice for these materials.						
OR						
\Box The material utilized was approved by a SMART Tool engineering vendor as an "equivalent" and this approval is included as part of the contractor submission.						
Antenna & Equipment Placement and Geometry Confirmation:						
\Box The contractor certifies that the photos support and the equipment on the mount is as depicted on the sketch and table included in this form and with the mount analysis provided.						

\Box The contractor notes that the equipment on the mount is not in accordance with the sketch and has noted the differences below and provided photo documentation of any alterations.							
Comn	nents:						
Was t	<u>he mount moc</u>	dification completed in conjunction with the equipment change / installation?					
	□Yes	□No					
<u>Specia</u>	al Instructions	/ Validation as required from the MA or Mod Drawings:					
Issue:							
Respo	onse:						
<u>Specia</u>	al Instruction C	Confirmation:					
	☐ The contra	ctor has read and acknowledges the above special instructions.					
Comn	nents:						
<u>Contr</u>	actor certifies	that the climbing facility / safety climb was not damaged prior to starting work:					
	□Yes	□No					
<u>Contr</u>	actor certifies	no new damage created during the current installation:					
	□Yes	□No					
<u>Contr</u>	actor to certify	the condition of the safety climb and verify no damage when leaving the site:					
	☐ Safety Climb in Good Condition ☐ Safety Climb Damaged						
Comn	nents:						

Certifying Individual:	
Company:	
Company: Employee Name:	
Contact Phone:	
Email:	
Date:	

Structure: 113278-VZW - WEST ROGERS WT -- 698801

S Α r:

Sr

r T : W r T


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9/28/2022

PF PAUL J. FORD

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P :1



		Н	W d	ΗD	Р	Р		Α	C. A	Α		
R #	M d	()	()	Frm L.	#	Р	٧	Р	Frm T.	НО	S	V d
A8	HBX-9016DS-VTM	74.7	6.8	150	1			Fr	42	0	Add d	
A1	NHH-65C-R2B	96	11.9	99	2			Fr	42	0	Add d	
R5	4449	15	13.2	99	2			B d	48	0	Add d	
R7	8843	15	13.2	99	2			B d	15	0	Add d	
A1	NHH-65C-R2B	96	11.9	51	3			Fr	42	0	Add d	
A6	RC3DC-3315-PF-48	23	15.7	51	3			B d	48	0	Add d	
R7	8843	15	13.2	51	3			B d	15	0	Add d	
A2	4408 / KRE 105 281/1	8.4	7.9		4			Fr	72	0	Add d	
A3	AIR 6449	30.8	16.1		4			Fr	18	0	Add d	
A4	CDX1923Q-DS-43	6.9	5.5		4			B d	18	0	Add d	

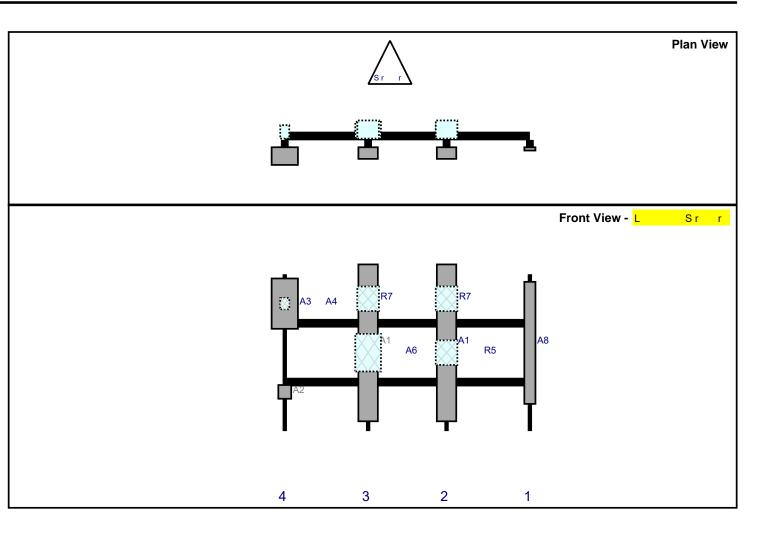Structure: 113278-VZW - WEST ROGERS WT -- 698801


S r: **B**

Sr r T : W r T 10170920

9/28/2022

PAUL J. FORD

M E : 101.00 P : 2

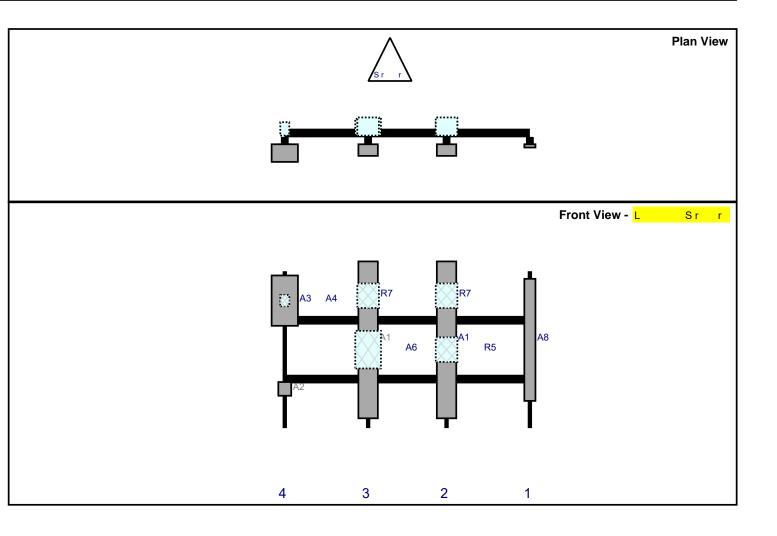

		Н	W d	ΗD	Р	Р		Α	C. A	Α		
R #	M d	()	()	Frm L.	#	Р	٧	Р	Frm T.	НО	S	V d
A8	HBX-9016DS-VTM	74.7	6.8	150	1			Fr	42	0	Add d	
A1	NHH-65C-R2B	96	11.9	99	2			Fr	42	0	Add d	
R5	4449	15	13.2	99	2			B d	48	0	Add d	
R7	8843	15	13.2	99	2			B d	15	0	Add d	
A1	NHH-65C-R2B	96	11.9	51	3			Fr	42	0	Add d	
A6	RC3DC-3315-PF-48	23	15.7	51	3			B d	48	0	Add d	
R7	8843	15	13.2	51	3			B d	15	0	Add d	
A2	4408 / KRE 105 281/1	8.4	7.9		4			Fr	72	0	Add d	
A3	AIR 6449	30.8	16.1		4			Fr	18	0	Add d	
A4	CDX1923Q-DS-43	6.9	5.5		4			B d	18	0	Add d	

Structure: 113278-VZW - WEST ROGERS WT -- 698801


S r: **C**

Sr r T : W r T 10170920

PF PAUL J. FORD

9/28/2022

M E : 101.00 P : 3

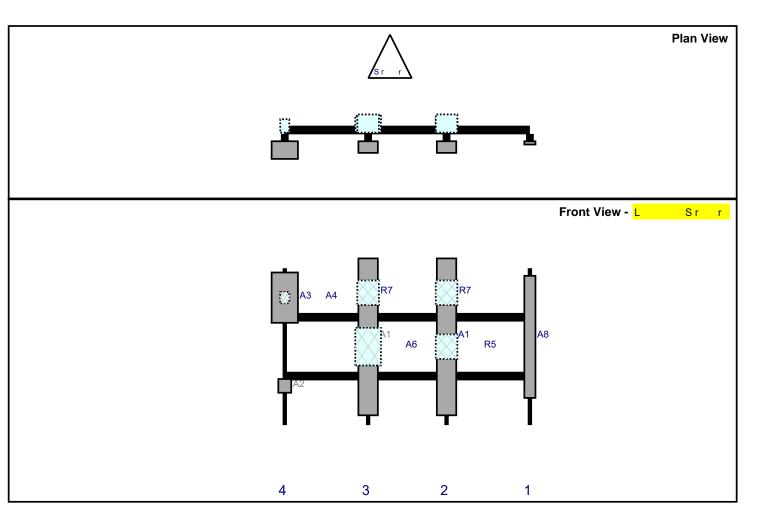

		Н	W d	ΗD	Р	Р		Α	C. <i>I</i>	4	Α		
R #	M d	()	()	Frm L.	#	Р	٧	Р	Frm	n T.	НО	S	V d
A8	HBX-9016DS-VTM	74.7	6.8	150	1			Fr	42		0	Add d	
A1	NHH-65C-R2B	96	11.9	99	2			Fr	42		0	Add d	
R5	4449	15	13.2	99	2			В	d 48		0	Add d	
R7	8843	15	13.2	99	2			В	d 15		0	Add d	
A1	NHH-65C-R2B	96	11.9	51	3			Fr	42		0	Add d	
A6	RC3DC-3315-PF-48	23	15.7	51	3			В	d 48		0	Add d	
R7	8843	15	13.2	51	3			В	d 15		0	Add d	
A2	4408 / KRE 105 281/1	8.4	7.9		4			Fr	72		0	Add d	
A3	AIR 6449	30.8	16.1		4			Fr	18		0	Add d	
A4	CDX1923Q-DS-43	6.9	5.5		4			В	d 18		0	Add d	

MOUNT MODIFICATION DRAWINGS PROPOSED CARRIER: VERIZON

113278-VZW / WEST ROGERS WT -- 698801

11515 W ROGERS ST MILWAUKEE, WISCONSIN 53227 MILWAUKEE COUNTY LAT: 43° 00' 28.30"; LONG: -88° 03' 21.90"

STRUCTURE OWNER: CITY OF WEST ALLIS

FUZE ID # 16233638

	CONTRACTOR PMI REQUIREMENTS					
	PMI ACCESSED AT HTTPS://PMI.VZWSMART.COM					
	SMART TOOL VENDOR PROJECT#	10170920				
VZW LOCATION CODE (PSLC) 113278						
	*** PMI AND REQUIREMENTS ALSO EMBEDDED WITHIN MOUNT ANALYSIS REPORT					

VZW APPROVED SMART KIT VENDORS
REFER TO BILL OF MATERIALS SHEET FOR VZW SMART KIT APPROVED VENDORS

SHEET INDEX					
SHEET DESCRIPTION REV					
ST-1	TITLE SHEET	0			
SBOM	BILL OF MATERIALS	0			
SGN-1	GENERAL NOTES	0			
SS-1	MODIFICATION DETAILS	0			
SS-2	MODIFICATION DETAILS	0			
SS-3	MODIFICATION DETAILS	0			
SS-4	MOUNT PHOTOS	0			
	SPECIFICATION SHEETS				



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VERIZON WIRELESS

MILWAUKEE, WISCONSIN MOUNT MODIFICATION DRAWINGS 698801

113278-VZW / WEST ROGERS WT

24322-2340.001.818 PROJECT No: RAWN BY ESIGNED BY: 09/28/202

> TITLE SHEET

ST-1

NOTE: ALL MATERIALS REQUIRED FOR THE DESIGN MODIFICATIONS BUT NOT LISTED IN THIS SHEET ARE ASSUMMED TO BE PROVIDED BY THE CONTRACTOR.

VZWSMART KITS - APPROVED VENDORS						
VENDOR	CONTACT	EMAIL	PHONE NUMBER			
PERFECT VISION	WIRELESS SALES	WIRELESSSALES@PERFECT-VISION.COM	(844) 884-6723			
SITEPRO	PAULA BOSWELL	PAULA.BOSWELL@VALMONT.COM	(972) 236-9843			
SABRE INDUSTRIES INC.	ANGIE WELCH	AKWELCH@SABREINDUSTRIES.COM	(866) 428-6937			
METROSITE FABRICATORS, LLC	KENT RAMEY	KENT@METROSITELLC.COM	(706) 335-7045			
COMMSCOPE	SALVADOR ANGUIANO	SALVADOR.ANGUIANO@COMMSCOPE.COM	(817) 304-7492			
BETTER METAL, LLC	DAVID STANSBERRY	DLS@BETTERMETAL.COM	(615) 535-0990			
NEWAVE TOWER COMPONENTS	NEWAVE SALES TEAM	SALES@NEWAVEATC.COM	(971) 239-4762			

TOTAL WEIGHT =

165.90

THE MANUFACTURER'S LISTED ARE THE APPROVED VENDORS FOR THE VZW MOUNT KITS. EACH MANUFACTURER WILL BE AWARE OF WHICH KITS HAVE BEEN THROUGH THE VZW APPROVAL PROCESS AND THE ARE IN TURN APPROVED TO SELL. PLEASE NOTE THAT THE MATERIAL UTILIZED ON THE MOUNT MODIFICATIONS WILL BE REVIEWED AS A PART OF THE DESKTOP PMI COMPLETED BY THE SMART TOOL VENDOR. IT WILL BE REQUIRED THAT THE VZW KITS SPECIFIED ARE UTILIZED IN THE MODIFICATION.

ALL PARTS ARE GALVANIZED UNLESS NOTED OTHERWISE

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VERIZON WIRELE

113278-VZW / WEST ROGERS WT MILWAUKEE, WISCONSIN MOUNT MODIFICATION DRAWINGS 698801

PROJECT No:	24322-2340.001.8189
DRAWN BY:	BRS
DESIGNED BY:	BRS
CHECKED BY:	KAT
DATE:	09/28/2022

ROBERT C.
KOZAK
E-49033
COLUMBUS

COLUMBUS.

09/28/2022

BILL OF MATERIALS


SBOM

GENERAL NOTES:

- . PAUL J. FORD AND COMPANY WAS NOT PROVIDED WITH THE EXACT LOCATION OF EVERY EXISTING ANTENNA MOUNT CONNECTION, CABLE CLIP, ETC THAT COULD POTENTIALLY INTERFERE WITH THE MODIFICATIONS AS INDICATED ON THESE DRAWINGS. THE CONTRACTOR SHALL FIELD VERIFY THAT THE MATERIAL CAN BE INSTALLED AS SHOWN ON THESE DRAWINGS BEFORE FABRICATING ANY MATERIAL. THE CONTRACTOR SHALL BE SOLELY RESPONSIBLE FOR THE PROPER FIT AND CLEARANCE OF THE REINFORCING MATERIAL IN THE FIELD. IF THE CONTRACTOR DISCOVERS ANY EXISTING CONDITIONS THAT ARE NOT AS REPRESENTED ON THESE DRAWINGS, PAUL J. FORD AND COMPANY SHALL BE CONTACTED IMMEDIATELY TO EVALUATE THE STRUCTURAL SIGNIFICANCE OF THE DEVIATION.
- WORK SHALL BE IN ACCORDANCE WITH LOCAL CODES. THE CONTRACTOR SHALL BE RESPONSIBLE FOR CONTACTING THE LOCAL BUILDING OFFICIALS FOR ANY INSPECTIONS THAT MAY BE REQUIRED.
- 3. THE CONTRACTOR MUST BE EXPERIENCED IN THE PERFORMANCE OF WORK SIMILAR TO THAT DESCRIBED ON THESE DRAWINGS. BY ACCEPTANCE OF THIS PROJECT, THE CONTRACTOR IS ATTESTING THAT HE DOES HAVE SUFFICIENT EXPERIENCE AND ABILITY, THAT HE IS KNOWLEDGEABLE OF THE WORK TO BE PERFORMED AND THAT HE IS PROPERLY LICENSED TO DO THIS WORK IN THE JURISDICTION IN WHICH THE WORK IS TO BE PERFORMED.
- 4. THE CONTRACTOR SHALL SUPERVISE AND DIRECT THE WORK AND SHALL BE SOLELY RESPONSIBLE FOR ALL CONSTRUCTION. ALL STRUCTURES ARE DESIGNED TO BE STABLE AND SELF-SUPPORTING AT THE COMPLETION OF CONSTRUCTION. THIS DRAWING DOES NOT INDICATE THE METHOD OF CONSTRUCTION. IT IS THE CONTRACTOR'S SOLE RESPONSIBILITY TO DETERMINE THE ERECTION PROCEDURES, METHODS, MEANS, TECHNIQUES, AND SEQUENCES TO ENSURE THE STABILITY AND SAFETY OF THE STRUCTURE AND ITS COMPONENT PARTS, AND THE ADEQUACY OF TEMPORARY OR INCOMPLETE CONNECTIONS DURING CONSTRUCTION. THIS INCLUDES, BUT IS NOT LIMITED TO, THE ADDITION OF WHATEVER TEMPORARY BRACING THAT MAY BE NECESSARY AND ENGINEERING ASSESSMENT OF CONSTRUCTION STRESSES WITH INSTALLATION MAXIMUM WIND SPEED AND/OR TEMPORARY BRACING AND SHORING. SUCH MATERIAL IS NOT INDICATED ON THE DRAWINGS AND, IF PROVIDED, SHALL BE REMOVED, AS CONDITIONS PERMIT AND REMAIN THE PROPERTY OF THE CONTRACTOR.
- 5. ANY EXISTING ATTACHMENTS AND/OR PROJECTIONS ON THE STRUCTURE THAT MAY INTERFERE WITH THE INSTALLATION OF THE MODIFICATION SYSTEM WILL HAVE TO BE REMOVED AND RELOCATED, REPLACED, OR RE-INSTALLED AS REQUIRED AFTER THE MODIFICATION IS SUCCESSFULLY COMPLETED. THE CONTRACTOR SHALL IDENTIFY AND COORDINATE THESE ITEMS PRIOR TO CONSTRUCTION WITH OWNER, TESTING AGENCY, AND EOR.
- THE CONTRACTOR SHALL BE SOLELY RESPONSIBLE FOR INITIATING, MAINTAINING, AND SUPERVISING ALL SAFETY PROGRAMS AND PRECAUTIONS IN CONNECTION WITH THE WORK.
- 7. CONTRACTOR SHALL TAKE ALL PRECAUTIONS NECESSARY TO PREVENT DAMAGE TO EXISTING STRUCTURES, EQUIPMENT AND UTILITIES. ANY DAMAGE TO EXISTING STRUCTURES, EQUIPMENT, AND UTILITIES AS A RESULT OF THE CONTRACTOR'S WORK OR FROM DAMAGE DUE TO OTHER CAUSES SHALL BE REPAIRED AT THE CONTRACTOR'S EXPENSE TO THE SATISFACTION OF THE OWNER.
- WORK SHALL BE PERFORMED DURING CALM DRY DAYS (WINDS LESS THAN 30-MPH) IN ACCORDANCE WITH OPERATIONAL WIND CONDITIONS PER TIA-322
- 9. THE MOUNTING SYSTEM SHALL NOT BE USED AS A TIE OFF POINT.
- 10. THE STRUCTURAL ANALYSIS ASSUMES THAT ALL STRUCTURAL COMPONENTS ARE IN BRAND-NEW CONDITION, FREE FROM FAULTS AND DEFECTS AND IN CONFORMANCE WITH THE CONTRACT DOCUMENTS. NO ALLOWANCE WAS MADE FOR ANY DAMAGED, MISSING, OR RUSTED MEMBERS. IF ANY OF THESE CONDITIONS ARE DISCOVERED, THE CONTRACTOR SHALL BRING THEM TO THE ATTENTION OF THE OWNER'S REPRESENTATIVE. ANY AND ALL SUBSTITUTIONS MUST BE PROPERLY APPROVED AND AUTHORIZED IN WRITING BY OWNER AND EOR PRIOR TO INSTALLATION. THE CONTRACTOR SHALL FURNISH SATISFACTORY EVIDENCE AS TO THE KIND AND QUALITY OF MATERIALS AND EQUIPMENT BEING SUBSTITUTED.
- 11. IF MATERIALS, QUANTITIES, STRENGTHS, OR SIZES INDICATED BY THE DRAWINGS OR SPECIFICATIONS ARE NOT IN AGREEMENT WITH THESE NOTES, THE BETTER QUALITY AND/OR GREATER QUANTITY, STRENGTH, OR SIZE INDICATED, SPECIFIED, OR NOTED SHALL BE PROVIDED.
- 12. OBSERVATION VISITS TO THE SITE BY OWNER AND/OR THE EOR SHALL NOT INCLUDE INSPECTIONS OF THE PROTECTIVE MEASURES OR THE CONSTRUCTION PROCEDURES.
- 13. ANY SUPPORT SERVICES PERFORMED BY THE EOR DURING CONSTRUCTION ARE SOLELY FOR THE PURPOSE OF ASSISTING IN QUALITY CONTROL AND IN ACHIEVING GENERAL PERFORMANCE WITH CONTRACT DOCUMENTS. THEY DO NOT GUARANTEE CONTRACTORS PERFORMANCE AND SHALL NOT BE CONSTRUED AS SUPERVISION OF CONSTRUCTION
- 14. THE CLIMBING FACILITIES, SAFETY CLIMB, AND ALL PARTS THEREOF SHALL NOT BE IMPEDED, MODIFIED, OR ALTERED WITHOUT THE APPROVAL OF THE FOR.
- 15. AFTER THE CONTRACTOR HAS SUCCESSFULLY COMPLETED THE INSTALLATION OF THE MODIFICATION SYSTEM AND THE WORK HAS BEEN ACCEPTED BY THE OWNER, THE OWNER WILL BE RESPONSIBLE FOR THE LONG TERM/PERPETUAL INSPECTION AND MAINTENANCE OF THE STRUCTURE AND MODIFICATION SYSTEM.
- 16. DO NOT SCALE DRAWINGS.
- 17. THE MOUNTING SYSTEM SHALL NOT BE USED FOR RIGGING PURPOSES. IF RIGGING TO THE MOUNT IS REQUIRED, ALL RIGGING PLANS SHALL ADHERE TO ANSI/ASSE A10.48 (LATEST EDITION), INCLUDING THE REQUIRED INVOLVEMENT OF A QUALIFIED ENGINEER FOR CLASS IV CONSTRUCTION TO CERTIFY THE SUPPORTING STRUCTURE(S) IN ACCORDANCE WITH THE ANSI/TIA-322 (LATEST EDITION).
- 18. ALL MANUFACTURER'S HARDWARE ASSEMBLY INSTRUCTIONS SHALL BE FOLLOWED, UNO. CONFLICTING NOTES SHALL BE BROUGHT TO THE ATTENTION OF THE EOR.
- 19. IF REMOVAL OF EXISTING MODIFICATIONS IS REQUIRED PER THE MODIFICATION SCOPE, THE GC SHALL CLEAN AND COLD GALVANIZE ANY EXISTING EMPTY BOLT HOLES, UNO. IF ADDITIONAL UNEXPECTED, OVERSIZED, OR SLOTTED HOLES ARE FOUND, THE GC SHALL CONTACT THE EOR FOR GUIDANCE PRIOR TO PROCEEDING WITH THE MODIFICATION.

STRUCTURAL STEEL:


- STRUCTURAL STEEL MATERIALS, FABRICATION, DETAILING, AND WORKMANSHIP SHALL CONFORM TO THE LATEST ADDITION OF THE FOLLOWING REFERENCE STANDARDS:
- A. BY THE AMERICAN INSTITUTE OF STEEL CONSTRUCTION (AISC):
- "SPECIFICATION FOR STRUCTURAL STEEL BUILDINGS"
- "SPECIFICATION FOR STRUCTURAL JOINTS USING ASTM HIGH STRENGTH BOLTS" AS APPROVED BY THE RESEARCH COUNCIL ON STRUCTURAL CONNECTIONS.
- "CODE OF STANDARD PRACTICE FOR STEEL BUILDINGS AND BRIDGES"
- B. BY THE AMERICAN WELDING SOCIETY (AWS):
- "STRUCTURAL WELDING CODE- STEEL D1.1"
- "STANDARD SYMBOLS FOR WELDING, BRAZING, AND NON-DESTRUCTIVE EXAMINATION"
- 2. NEW STEEL (UNLESS NOTED OTHERWISE) SHALL CONFORM TO THE REQUIREMENTS OF THE ASTM STANDARD SPECIFICATION FOR STRUCTURAL STEEL NOTED BELOW:
 - W ASTM A992 (50 KSI YIELD POINT MATERIAL)
 - HSS RECTANGULAR ASTM A500 GR. B (46 KSI YIELD POINT MATERIAL)
 - HSS ROUND ASTM A500 GR. B (42 KSI YIELD POINT MATERIAL) PIPE - ASTM A53 GR. B (35 KSI YIELD POINT MATERIAL)
 - C, MC, L, PLATES, BARS & ALL OTHER STEEL ASTM A36 (36KSI YIELD POINT MATERIAL)
 - BOLTS ASTM A325
 - U-BOLTS ASTM A307 GRADE A, OR SAE J429 GRADE 2
 - THREADED RODS ASTM A36 NUTS - ASTM A563 GRADE DH
 - WASHERS ASTM F436 TYPE
- ALL NEW STEEL SHALL BE HOT-DIP GALVANIZED AFTER FABRICATION IN ACCORDANCE WITH ASTM A123, ASTM 153/A153M, OR ASTM A653 G90.
- ALL BOLTS, U-BOLTS, AND THREADED RODS SHALL BE PROVIDED WITH LOCK-WASHERS, OR LOCK-NUTS, OR PAL-NUTS TORQUED TO THE SNUG-TIGHT CONDITION AS DEFINED BY AISC.
- 5. ALL HOLES, EITHER PUNCHED OR DRILLED, IN THE EXISTING STEEL MEMBERS SHALL BE 1/16 INCH LARGER THAN THE BOLT DIAMETER, UNLESS NOTED OTHERWISE. BURNING OF MEMBERS SHALL NOT BE PERMITTED. SLOTTED HOLES ARE NOT PERMITTED. THE MINIMUM BOLT SPACING SHALL BE 3 TIMES THE BOLT DIAMETER AND THE MINIMUM EDGE DISTANCE SHALL BE 1.5 TIMES THE BOLT DIAMETER UNLESS NOTED OTHERWISE. ALL BOLT HOLES SHALL BE PLACED AT AISC STANDARD GAGE DIMENSIONS, UNLESS NOTED OTHERWISE.
- 6. IF ANY EXISTING ASTM A325 BOLTS ARE REMOVED, THEY MUST BE REPLACED WITH NEW A325 BOLTS OR GREATER.
- ALL EXISTING PAINTED OR GALVANIZED SURFACES DAMAGED DURING CONSTRUCTION SHALL BE WIRE BRUSHED CLEAN, REPAIRED BY FILM GALVANIZING BRUSH APPLIED PAINT (ZINGA OR EQUAL), AND REPAINTED TO MATCH THE EXISTING FINISH CONFORMING TO ASTM A780
- 8. ALL PARTS ARE TO MARKED WITH ITEM NUMBERS USING 3/4" HIGH STEEL STENCILS.
- 9. SHOP SHALL ASSEMBLE AND VERIFY FIT AND GAPS BEFORE BREAKDOWN FOR GALVANIZING
- 10. NO FIELD WELDING SHALL BE DONE TO THE EXISTING STRUCTURE WITHOUT THE PRIOR APPROVAL OF THE OWNER AND SUPERVISION BY THE INSPECTION/TESTING AGENCY.
- 11. ALL REQUIRED CUTS SHALL BE CUT WITHIN THE DIMENSIONS SHOWN ON THE DRAWINGS. NO CUTS SHALL EXTEND BEYOND THE OUTLINE OF THE DIMENSIONS SHOWN ON THE DRAWINGS. ALL CUT EDGES SHALL BE GROUND SMOOTH AND DE-BURRED. CONTRACTOR TO AVOID 90 DEGREE CORNERS. IT MAY BE NECESSARY TO DRILL STARTER HOLES AS BEQUIRED. TO MAKE THE CUT.
- 12. ALL JOINTS ARE BEARING TYPE CONNECTIONS, UNO. IF NO BOLT LENGTH IS GIVEN IN THE BILL OF MATERIALS, THE CONNECTION MAY INCLUDE THREADS IN THE SHEAR PLANE, AND THE GC IS RESPONSIBLE FOR SIZING THE LENGTH OF THE BOLT. IT IS NOT PERMITTED FOR THE BOLT END TO BE BELOW THE FACE OF THE NUT AFTER TIGHTENING IS COMPLETED.

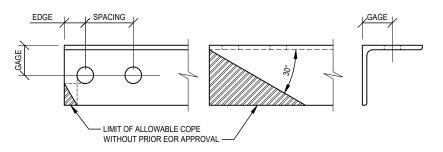

ALLOWABLE COPING

	BOLT SCHEDULE (IN)						
BOLT DIAMETER	STANDARD HOLE	SHORT SLOT	MIN EDGE DISTANCE	SPACING			
1/2	9/16	9/16 x 11/16	7/8	1 1/2			
5/8	11/16	11/16 x 7/8	1 1/8	1 7/8			
3/4	13/16	13/16 x 1	1 1/4	2 1/4			
7/8	15/16	15/16 x 1 1/8	1 1/2	2 5/8			
1	1 1/16	1 1/16 x 1 5/16	1 3/4	3			


WORKABLE GAGES (IN)				
LEG	GAGE			
4	2 1/2			
3 1/2	2			
3	1 3/4			
2 1/2	1 3/8			
2	1 1/8			

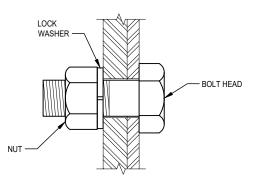

TYP BOLT ASSEMBLY

NOTE:

- I. ALL DIMENSIONS REPRESENTED IN THE ABOVE TABLES ARE AISC MINIMUM REQUIREMENTS. CONTRACTOR SHALL VERIFY EXISTING CONDITIONS IN FIELD AND NOTIFY ENGINEER IF DISTANCES ARE LESS THAN THOSE PROVIDED.
- 2. THE DIMENSIONS PROVIDED ARE MINIMUM REQUIREMENTS. ACTUAL DIMENSIONS OF PROPOSED MEMBERS WITHIN THESE DRAWINGS MAY VARY FROM THE AISC MINIMUM REQUIREMENTS.
- SHORT SLOT HOLES SHALL ONLY BE USED WHEN DEPICTED IN THE DRAWING.
- MATCH EXISTING GAGES WHEN APPLICABLE, UNLESS MINIMUM EDGE DISTANCES ARE COMPROMISED.

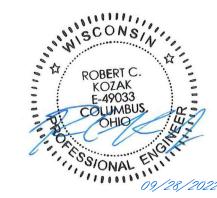

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ROGERS

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WT -- 250 E Broad St, Ste 66 Phone 614.221.6679

698801 MILWAUKEE, WISCONSIN MOUNT MODIFICATION DRAWINGS

PROJECT No: 24322-2340.001.8189

DRAWN BY: BRS

DESIGNED BY: BRS

CHECKED BY: KAT

DATE: 09/28/2022

GENERAL NOTES

SGN-1


NOTES:

- PRIOR TO FABRICATION AND INSTALLATION, CONTRACTOR SHALL FIELD VERIFY ALL LENGTHS AND QUANTITIES GIVEN. LENGTH AND QUANTITIES PROVIDED ARE FOR QUOTING PURPOSE ONLY AND SHALL NOT BE USED FOR FABRICATION.
- 2. ALL MODIFICATIONS SHOWN ARE TYPICAL ALL SECTORS UNLESS NOTED OTHERWISE.
- 3. SOME MEMBERS NOT SHOWN FOR CLARITY.
- 4. RADIO AND/OR TME POSITIONS SHALL BE ADJUSTED VERTICALLY AS NEEDED IN ORDER TO ACHIEVE INSTALLATION OF MODIFICATION KITS AS SHOWN. EOR SHALL BE NOTIFIED IF EQUIPMENT NEEDS TO BE RELOCATED TO ANOTHER MOUNT PIPE.
- 5. MEMBERS IN BLUE COLOR ARE NEW REINFORCEMENTS AND MEMBERS IN AQUA COLOR (IF SHOWN) ARE RELOCATED MEMBERS.
- 6. ALL SHOWN DIMENSIONS HAVE AN INSTALLABLE TOLERANCE OF ±0'-3", UNLESS NOTED OTHERWISE.

|--|

ISOMETRIC MODIFIED MOUNT VIEW (GAMMA) SCALE: NTS

MOUNT MODIFICATION SCHEDULE						
	ELEVATION	MOUNT MODIFICATION DESCRIPTION	REFERENCE SHEETS			
1	101'-0"±	INSTALL NEW MOUNT PIPES USING NEW CROSSOVER PLATES (GAMMA SECTOR ONLY)	SS-1			
2	101'-0"±	INSTALL NEW CUSTOM ANGLE TIEBACKS (GAMMA SECTOR ONLY)	SS-1			

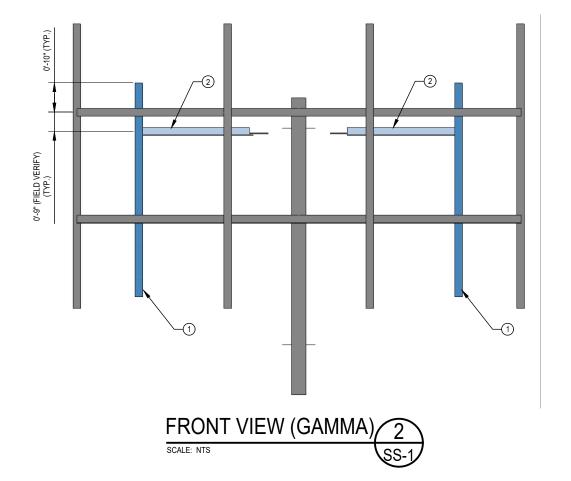

ROBERT JUMBUS. SSIONAL ELL

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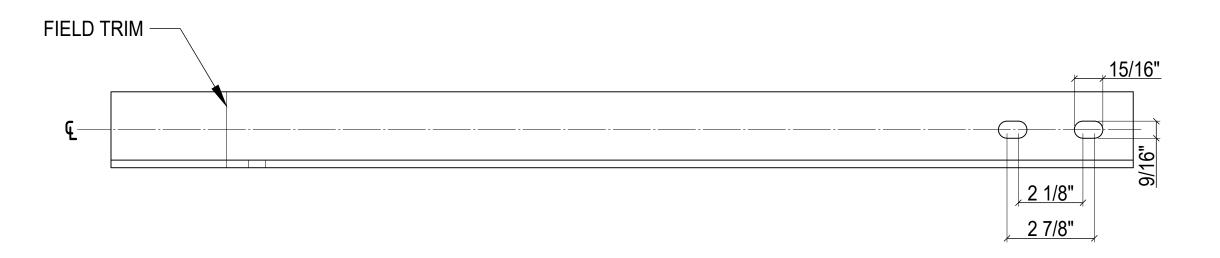
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VERIZON WIRELE

113278-VZW / WEST ROGERS WT MILWAUKEE, WISCONSIN MOUNT MODIFICATION DRAWINGS 698801

PROJECT No: 24322-2340.001.8189 RAWN BY: BRS ESIGNED BY: KAT CHECKED BY: DATE: 09/28/2022

MODIFICATION DETAILS



FIELD DRILL 9/16"ø HOLE (TYP)

CUSTOM ANGLE TIEBACK DETAIL

L2.5 x 2.5 x1/4



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JL J. FORD

F ROMPA Road St, Ste 600: Columbu


VERIZON WIRELESS

698801
MILWAUKEE, WISCONSIN
MOUNT MODIFICATION DRAWINGS

113278-VZW / WEST ROGERS WT

PROJECT No:	24322-2340.001.8189
DRAWN BY:	BRS
DESIGNED BY:	BRS
CHECKED BY:	KAT
DATE:	09/28/2022

MODIFICATION DETAILS

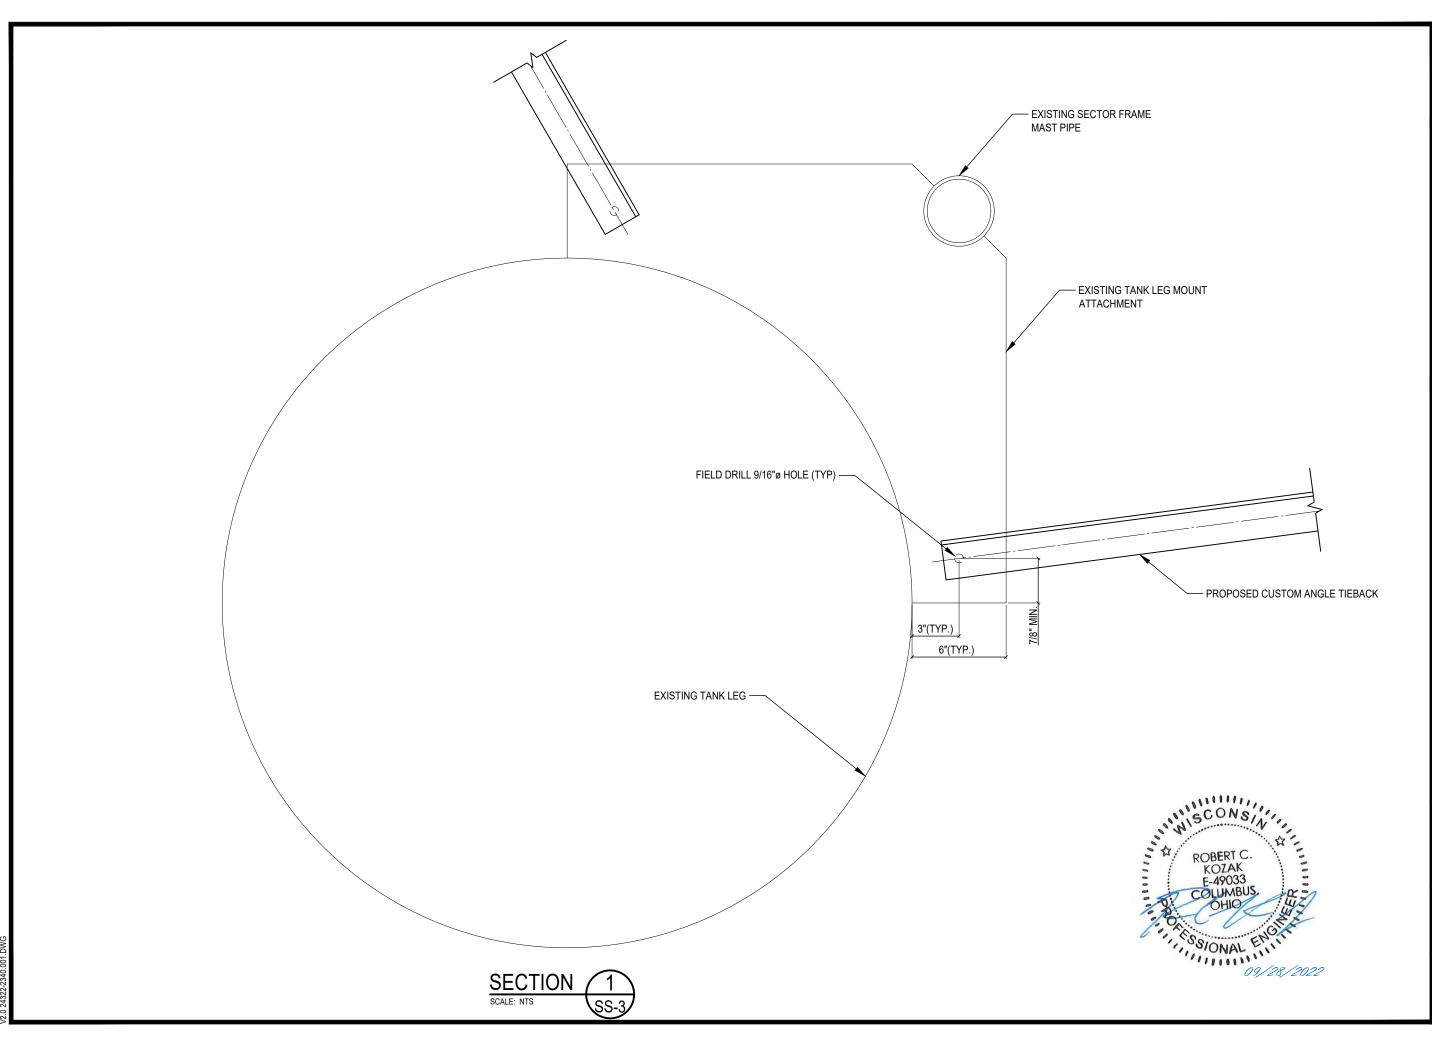

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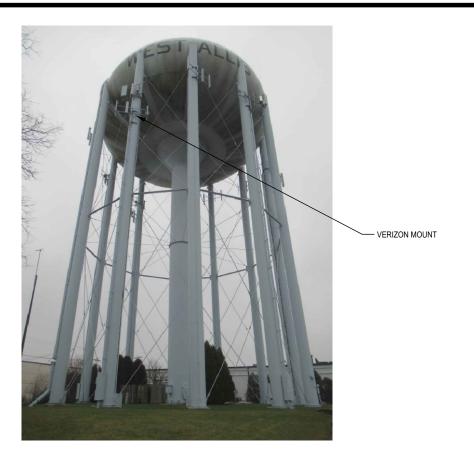
FAUL J. FORD
& COMPANY
E Broad St, Ste 600· Columbus, OH 43215
e 614.221.6679 www.pauljford.com

VERIZON WIRELESS

113278-VZW / WEST ROGERS WT 698801
MILWAUKEE, WISCONSIN
MOUNT MODIFICATION DRAWINGS


PROJECT No: 24322-2340.001.8189 RAWN BY: DESIGNED BY: BRS KAT CHECKED BY: DATE: 09/28/2022


MODIFICATION DETAILS







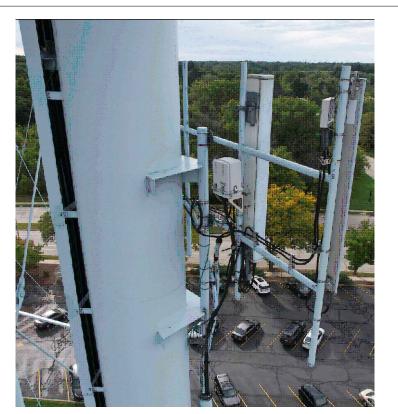

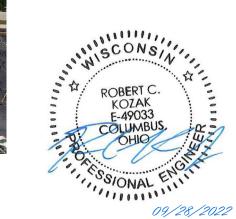

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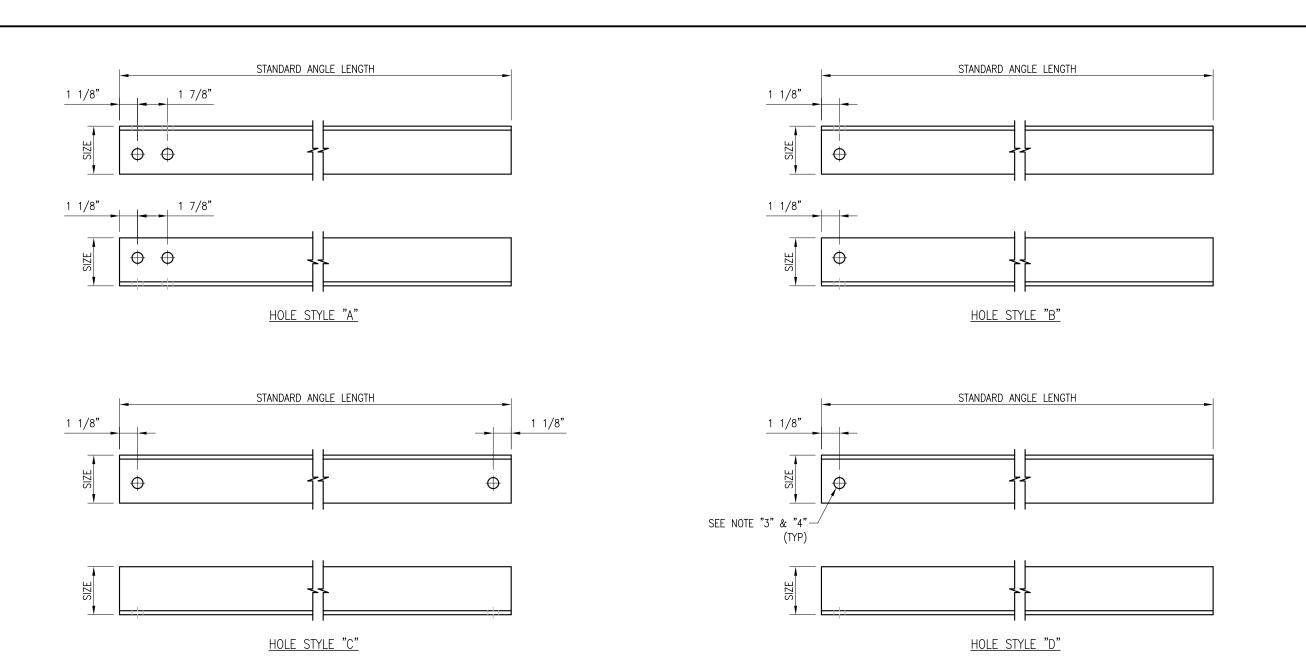
VERIZON WIRELESS

FAUL J. FORD
& COMPANY
E Broad St, Ste 600· Columbus, OH 43215
e 614.221.6679 www.paujford.com

113278-VZW / WEST ROGERS WT 698801 MILWAUKEE, WISCONSIN MOUNT MODIFICATION DRAWINGS

PROJECT No: 24322-2340.001.8189 RAWN BY: DESIGNED BY: BRS KAT CHECKED BY: DATE: 09/28/2022

> MOUNT **PHOTOS**



VZWSMART Standard Angle							
VZWSMART Number	Size	Length	Hole Style	Hole Gage	Also Used In:		
A-PLK2-01	L 3" X 3" X 1/4"	96"	A	1-3/4"	VZWSMART-PLK2		
A-PLK5-01	L 3"X 3" X 3/16"	96"	В	1-3/4"	VZWSMART-PLK5		
A-SFK3-01	L 2-1/2" X 2-1/2" X 1/4"	96"	С	1-3/8"	VZWSMART-SFK3,-SFK3-SL, -PLK6, & -PLK8		
A-L25X25X4X120	L 2-1/2" X 2-1/2" X 1/4"	120"	D	1-5/16"			
A-L25X25X4X240	L 2-1/2" X 2-1/2" X 1/4"	240"	D	1-5/16"			
A-L30X30X4X120	L 3" X 3" X 1/4"	120"	D	1-1/2"			
A-L30X30X4X240	L 3" X 3" X 1/4"	240"	D	1-1/2"			
A-L40X40X4X120	L 4" X 4" X 1/4"	120"	D	2"			
A-L40X40X4X240	L 4" X 4" X 1/4"	240"	D	2"			
A-L50X30X6X120	L 5" X 3" X 3/8"	120"	D	2-1/2"			
·							

2-1/2"

L 5" X 5" X 3/8"

A-L50X50X6X120

120"

VzWSMART Tool® Vendor



FOR **REFERENCE ONLY**


DRAWN BY: BT	CHECKE	D BY	: HMA/KW
REV. DESCRIPTION FIRST ISSUE		BY BT	DATE 08/04/2
△			
SHEET TITLE:			


VZWSMART STANDARD ANGLE

SHEET NUMBER: REV #: VZWSMART-ANGLE

NOTE:
APPROVED SMART KIT VENDORS ARE ALLOWED TO SUBSTITUTE AT THEIR DISCRETION ANGLES LISTED ON THIS PAGE FOR CUSTOM LENGTH COMPONENTS OF MATCHING SIZE. SUBSTITUTIONS SHALL MEET THE ORIGINAL STRUCTURAL INTENT.

- 1. ALL ANGLE GRADE A36 OR BETTER.
 2. HOT-DIPPED GALVANIZED PER ASTM A123.
- 3. ALL HOLES ARE 11/16" DIA. U.N.O
- 4. HOLES MAY OR MAY NOT BE PRESENT, DEPEND UPON MANUFACTURE DISCRETION.
 5. ALL FIELD CUT AND DRILLED SURFACES SHALL BE REPAIRED WITH A MINIMUM OF TWO COATS OF ZINGA OR ZINC COTE PER ASTM A780 AND MANUFACTURER'S RECOMMENDATIONS.

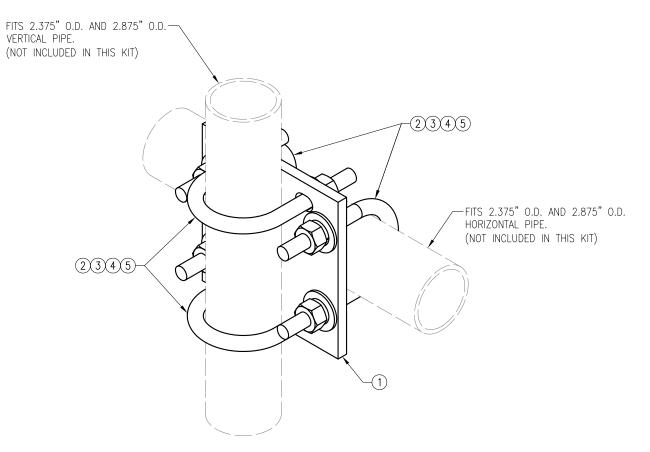

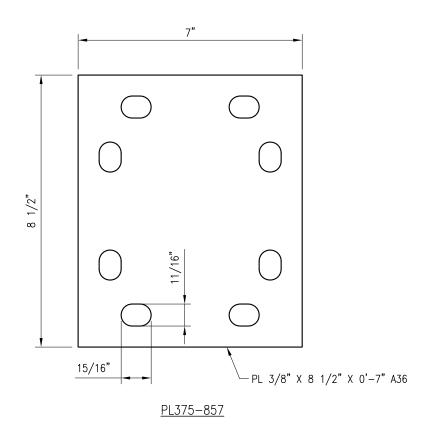

	VZWSMART-MSK1 (CROSSOVER PLATE)							
ITEM NO.	QTY.	PART NO.	DESCRIPTION	SHEET #	WT			
1	1	PL375-857	PL 3/8" X 8 1/2" X 0'-7" A36	MSK1-F1	6			
2	4	MS02-625-300-500	RU-BOLT 5/8" X 3" I.W. X 5" I.L. A36 (OR EQUIV.)	RBC-1	5			
3	8	FW-625	5/8" HDG USS FLAT WASHER		1			
4	8	LW-625	5/8" HDG LOCK WASHER		0			
5	8	NUT-625	5/8" HDG HEX NUT		1			
	GALVANIZED WT 14							

VzW **SMART Tool**[©] Vendor

verizon


FOR REFERENCE ONLY

CHECKED BY: HMA DRAWN BY: H.R H.R 05/08/20

VZWSMART-MSK1 CROSSOVER PLATE

SHEET NUMBER: REV #: VZWSMART-MSK1

NOTES: 1. HOT-DIPPED GALVANIZED PER ASTM A123.

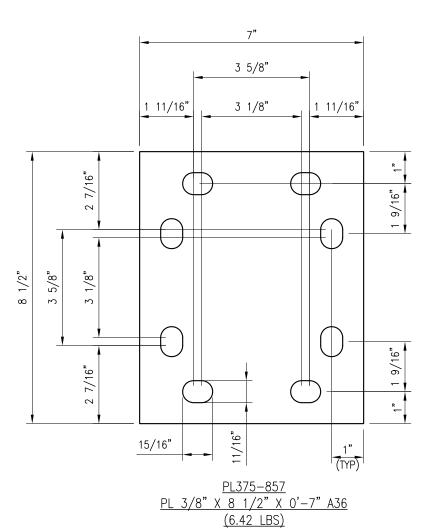

VzWSMART Tool® Vendor

verizon v

FOR REFERENCE ONLY

CHECKED BY: HMA DRAWN BY: H.R H.R 05/08/20

FABRICATION DETAILS

SHEET NUMBER: MSK1-F1

REV #:

NOTES:

1. HOT-DIPPED GALVANIZED PER ASTM A123.


DESCRIPTION	(EQUIVALENT PART NO.)	"A"	"B"	"C"	"D"	"E"	"WGT"
3/8" RU-BOLT	MS02-375-8125-1625	3/8"	13/16"	15/8"	7/8"	1 3/16"	0.26
3/8" RU-BOLT	MS02-375-100-225	3/8"	1"	2 1/4"	1 1/4"	1 3/8"	0.30
3/8" RU-BOLT	MS02-375-125-225	3/8"	1 1/4"	2 1/4"	1 1/4"	15/8"	0.30
3/8" RU-BOLT	MS02-375-1125-18125	3/8"	1 1/8"	1 13/16"	1 1/4"	1 1/2"	0.27
3/8" RU-BOLT	MS02-375-150-250	3/8"	1 1/2"	2 1/2"	1 1/4"	17/8"	0.32
3/8" RU-BOLT	MS02-375-150-275	3/8"	1 1/2"	2 3/4"	15/8"	17/8"	0.34
3/8" RU-BOLT	MS02-375-150-300	3/8"	1 1/2"	3"	13/4"	17/8"	0.35
3/8" RU-BOLT	MS02-375-175-275	3/8"	13/4"	2 3/4"	1 1/8"	2 1/8"	0.34
3/8" RU-BOLT	MS02-375-200-2625	3/8"	2"	2 5/8"	1 1/4"	2 3/8"	0.34
3/8" RU-BOLT	MS02-375-200-125	3/8"	2"	3"	1-1/4"	2-3/8"	0.40
3/8" RU-BOLT	MS02-375-2125-300	3/8"	2 1/8"	3"	1 1/4"	2 1/2"	0.36
3/8" RU-BOLT	MS02-375-250-30625	3/8"	2 1/2"	3 1/16"	1 1/4"	2 7/8"	0.38
3/8" RU-BOLT	MS02-375-250-3125	3/8"	2 1/2"	3 1/8"	1 1/4"	2 7/8"	0.37
3/8" RU-BOLT	MS02-375-250-3625	3/8"	2 1/2"	3-5/8"	13/4"	2 7/8"	0.45
3/8" RU-BOLT	MS02-375-300-3625	3/8"	3"	3 5/8"	1 1/4"	3 3/8"	0.42
3/8" RU-BOLT	MS02-375-300-425	3/8"	3"	4 1/4"	2"	3 3/8"	0.50
3/8" RU-BOLT	MS02-375-300-6625	3/8"	3	6 5/8"	3	3 3/8"	0.53
3/8" RU-BOLT	MS02-375-350-4125	3/8"	3 1/2"	41/8"	11/4"	3 7/8"	0.46
3/8" RU-BOLT	MS02-375-350-4123	3/8"	3 1/2"	4 3/4"	2"	3 7/8"	0.40
3/8" RU-BOLT	MS02-375-400-575	3/8"	4"	5 3/4"	2 1/2"	4 3/8"	0.50
3/8 RU-DULI	IVISU2-373-400-373	3/0	4	33/4	21/2	4 3/ 0	0.60
4 /2" DU DOLT	MC03 F00 7F 3F0	1/211	2/4!!	2.4./2!!	2.4/28	4 4 / 4 !!	0.00
1/2" RU-BOLT	MS02-500-75-350	1/2"	3/4"	3 1/2"	2 1/2"	1 1/4"	0.60
1/2" RU-BOLT	MS02-500-1563-350	1/2"	1 9/16"	3 1/2"	2"	2 1/16"	0.62
1/2" RU-BOLT	MS02-500-200-300	1/2"	2"	3"	11/4"	2 1/2"	0.55
1/2" RU-BOLT	MS02-500-200-375	1/2"	2"	3 3/4"	13/4"	2 1/2"	0.67
1/2" RU-BOLT	MS02-500-20625-500	1/2"	2 1/16"	5	3"	2 9/16"	0.80
1/2" RU-BOLT	MS02-500-225-450	1/2"	2 1/4"	4 1/2"	2 1/2"	2 3/4"	0.76
1/2" RU-BOLT	MS02-500-2438-3625	1/2"	2 7/16"	3 5/8"	13/4"	2 15/16"	0.67
1/2" RU-BOLT	MS02-500-2438-5375	1/2"	2 7/16"	5 3/8"	3"	2 15/16"	0.86
1/2" RU-BOLT	MS02-500-250-400	1/2"	2 1/2"	4"	2 1/2"	3"	0.70
1/2" RU-BOLT	MS02-500-250-450	1/2"	2 1/2"	4 1/2"	2 1/2"	3"	0.76
1/2" RU-BOLT	MS02-500-29375-575	1/2"	2 15/16"	5 3/4"	3"	3 7/16"	0.92
1/2" RU-BOLT	MS02-500-300-4125	1/2"	3"	4 1/8"	2"	3 1/2"	0.74
1/2" RU-BOLT	MS02-500-300-450	1/2"	3"	4 1/2"	15/8"	3 1/2"	0.73
1/2" RU-BOLT	MS02-500-300-500	1/2"	3"	5"	2 1/2"	3 1/2"	0.84
1/2" RU-BOLT	MS02-500-350-500	1/2"	3 1/2"	5"	1 1/2"	4"	0.78
1/2" RU-BOLT	MS02-500-350-850	1/2"	3 1/2"	8 1/2"	3"	4"	1.09
1/2" RU-BOLT	MS02-500-3625-550	1/2"	3 5/8"	5 1/2"	3"	4 1/8"	1.10
1/2" RU-BOLT	MS02-500-3625-600	1/2"	3 5/8"	6"	2 1/2"	4 1/8"	0.97
1/2" RU-BOLT	MS02-500-3563-450	1/2"	3 9/16"	4 1/2"	2"	4 1/16"	0.80
1/2" RU-BOLT	MS02-500-3563-650	1/2"	3 9/16"	6 1/2"	3"	4 1/16"	1.02
1/2" RU-BOLT	MS02-500-400-550-B	1/2"	4"	5 1/2"	1 1/2"	4 1/2"	0.84
1/2" RU-BOLT	MS02-500-400-550	1/2"	4"	5 1/2"	2"	4 1/2"	0.92
1/2" RU-BOLT	MS02-500-4063-700	1/2"	4 1/16"	7"	3"	4 9/16"	1.09
1/2" RU-BOLT	MS02-500-4003-700	1/2"	4 1/10	6"	2 1/2"	4 5/8"	0.98
1/2" RU-BOLT	MS02-500-450-600	1/2"	4 1/2"	6"	11/2"	5"	0.89
1/2" RU-BOLT	MS02-500-450-600 MS02-500-4625-700	1/2"	4 1/2	7"	2 1/2"	5 1/8"	1.11
•		+	1				
1/2" RU-BOLT	MS02-500-4563-750	1/2"	4 9/16"	7 1/2"	3"	5 1/16"	1.16
1/2" RU-BOLT	MS02-500-5625-725	1/2"	5 5/8"	7 1/4"	2"	6 1/8"	1.04
1/2" RU-BOLT	MS02-500-4563-575	1/2"	4 9/16"	5 3/4"	2"	5 1/16"	0.97
1/2" RU-BOLT	MS02-500-5563-700	1/2"	5 9/16"	7"	2"	6 1/16"	1.14
1/2" RU-BOLT	MS02-500-575-750	1/2"	5 3/4"	7 1/2"	2 1/2"	6 1/4"	1.22
1/2" RU-BOLT	MS02-500-6625-800	1/2"	6 5/8"	8"	3"	7 1/8"	1.28
1/2" RU-BOLT	MS02-500-675-850	1/2"	6 3/4"	8 1/2"	2 1/2"	7 1/4"	1.17
1/2" RU-BOLT	MS02-500-675-8375	1/2"	6 3/4"	8 3/8"	2"	7 1/4"	1.24
1/2" RU-BOLT	MS02-500-8750-1025	1/2"	8 3/4"	10 1/4"	3"	9 1/4"	1.60
1/2" RU-BOLT	MS02-500-875-10375	1/2"	8 3/4"	10 3/8"	2"	9 1/4"	1.34
1/2" RU-BOLT	MS02-500-10875-1300	1/2"	10 7/8"	1'-1"	3"	11 3/8"	1.98

STANDARD RU-BOLT CHART

NOTES:

IF EQUIVALENT U-BOLTS ARE USED, THE FOLLOWING SPECIFICATIONS ARE REQUIRED:

- 1. THE MATERIAL SHALL BE HOT ROLLED STEEL WITH A MINIMUM YIELD STRENGTH OF 36 KSI.
- 2. ALL U-BOLTS SHALL BE HOT DIP GALVANIZED PER ASTM A153-78.
- 3. TOLERANCE: FOR "C" AND "D" +/- 1/16", "B" AND "E" + 1/16", "A" +/- 1/32".

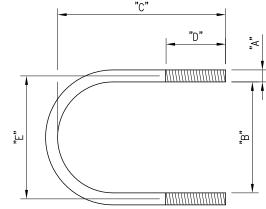

	"D"	,"A
	— <u>Millillillillilli</u>	
""		
<u>'</u>		

	STANDA	RD RU-BOLT	CHART				
DESCRIPTION	(EQUIVALENT PART NO.)	"A"	"B"	"C"	"D"	"E"	"WGT"
5/8" RU-BOLT	MS02-625-200-375	5/8"	2"	3 3/4"	2"	2 5/8"	1.15
5/8" RU-BOLT	MS02-625-2063-500	5/8"	2 1/16"	5"	3"	2 11/16"	1.32
5/8" RU-BOLT	MS02-625-2438-5375	5/8"	2 7/16"	5 3/8"	3"	3 1/16"	1.40
5/8" RU-BOLT	MS02-625-250-400	5/8"	2 1/2"	4"	2 1/2"	3 1/8"	1.17
5/8" RU-BOLT	MS02-625-2625-450	5/8"	2 5/8"	4 1/2"	2"	3 1/4"	1.20
5/8" RU-BOLT	MS02-625-2563-550	5/8"	2 9/16"	5 1/2"	3"	3 3/16"	1.43
5/8" RU-BOLT	MS02-625-2938-5875	5/8"	2 15/16"	5 7/8"	3"	3 9/16"	1.52
5/8" RU-BOLT	MS02-625-300-400	5/8"	3"	4"	2"	3 5/8"	1.20
5/8" RU-BOLT	MS02-625-300-500	5/8"	3"	5"	3"	3 5/8"	1.37
5/8" RU-BOLT	MS02-625-3063-600	5/8"	3 1/16"	6"	3"	3 11/16"	1.54
5/8" RU-BOLT	MS02-625-3625-600	5/8"	3 5/8"	6"	3"	4 1/4"	1.45
5/8" RU-BOLT	MS02-625-3563-650	5/8"	3 9/16"	6 1/2"	3"	4 3/16"	1.65
5/8" RU-BOLT	MS02-625-4063-700	5/8"	4 1/16"	<i>7</i> "	3"	4 11/16"	1.77
5/8" RU-BOLT	MS02-625-4125-600	5/8"	4 1/8"	6"	3"	4 3/4"	1.60
5/8" RU-BOLT	MS02-625-4625-700	5/8"	45/8"	7"	3"	5 1/4"	1.60
5/8" RU-BOLT	MS02-625-4563-750	5/8"	4 9/16"	7 1/2"	3"	5 3/16"	1.87
5/8" RU-BOLT	MS02-625-4813-775	5/8"	4 13/16"	7 3/4"	3"	5 7/16"	1.93
5/8" RU-BOLT	MS02-625-500-700	5/8"	5"	7"	3"	5 5/8"	1.96
5/8" RU-BOLT	MS02-625-5063-800	5/8"	5 1/16"	8"	3"	5 11/16"	1.99
5/8" RU-BOLT	MS02-625-5625-85625	5/8"	5 5/8"	8 9/16"	3"	6 1/4"	2.11
5/8" RU-BOLT	MS02-625-575-800	5/8"	5 3/4"	8"	3"	6 3/8"	2.02
5/8" RU-BOLT	MS02-625-6688-9625	5/8"	6 11/16"	9 5/8"	3"	7 5/16"	2.35
5/8" RU-BOLT	MS02-625-6750-900	5/8"	63/4"	9"	3"	7 3/8"	2.24
5/8" RU-BOLT	MS02-625-8688-11625	5/8"	8 11/16"	11 5/8"	3"	9 3/16"	2.80
5/8" RU-BOLT	MS02-625-875-1100	5/8"	8 3/4"	11"	3"	9 3/8"	2.70
5/8" RU-BOLT	MS02-625-10688-1375	5/8"	10 13/16	13 3/4"	3"	11 7/16"	3.27
5/8" RU-BOLT	MS02-625-12875-1575	5/8"	12 7/8"	15 3/4"	3"	13 1/2"	3.72
5/8" RU-BOLT	MS02-625-14125-1700	5/8"	14 1/8"	17"	3"	14 3/4"	4.01

VzW SMART Tool® Vendor




FOR REFERENCE ONLY

DRAWN BY: H.R	CHECKED BY: HMA
REV. DESCRIPTION	BY DATE
<u> </u>	H.R 05/08/2
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$\overline{\wedge}$	
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SHEET TITLE:	

RU-BOLT CHART

SHEET NUMBER: RBC-1 REV #:

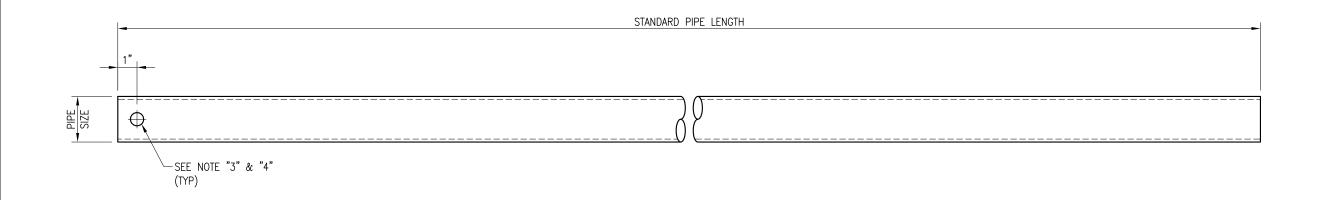

VZWSMART Standard Pipe		
VZWSMART Number	Size	Length
P40-238X048	PIPE 2 SCH40 (2.375" OD x 0.154" THK)	48"
P40-238X072	PIPE 2 SCH40 (2.375" OD x 0.154" THK)	72"
P40-238X096	PIPE 2 SCH40 (2.375" OD x 0.154" THK)	96"
P40-238X120	PIPE 2 SCH40 (2.375" OD x 0.154" THK)	120"
P40-238X126	PIPE 2 SCH40 (2.375" OD x 0.154" THK)	126"
P40-238X150	PIPE 2 SCH40 (2.375" OD x 0.154" THK)	150"
P40-238X174	PIPE 2 SCH40 (2.375" OD x 0.154" THK)	174"
P40-278X048	PIPE 2.5 SCH40 (2.875" OD x 0.203" THK)	48"
P40-278X072	PIPE 2.5 SCH40 (2.875" OD x 0.203" THK)	72"
P40-278X096	PIPE 2.5 SCH40 (2.875" OD x 0.203" THK)	96"
P40-278X120	PIPE 2.5 SCH40 (2.875" OD x 0.203" THK)	120"
P40-278X126	PIPE 2.5 SCH40 (2.875" OD x 0.203" THK)	126"
P40-278X150	PIPE 2.5 SCH40 (2.875" OD x 0.203" THK)	150"
P40-278X174	PIPE 2.5 SCH40 (2.875" OD x 0.203" THK)	174"
P40-312X048	PIPE 3 SCH40 (3.5" OD x 0.216" THK)	48"
P40-312X072	PIPE 3 SCH40 (3.5" OD x 0.216" THK)	72"
P40-312X126	PIPE 3 SCH40 (3.5" OD x 0.216" THK)	126"
P40-312X150	PIPE 3 SCH40 (3.5" OD x 0.216" THK)	150"
P40-312X174	PIPE 3 SCH40 (3.5" OD x 0.216" THK)	174"

NOTE:
APPROVED SMART KIT VENDORS ARE ALLOWED TO SUBSTITUTE AT THEIR DISCRETION PIPES LISTED ON THIS PAGE FOR CUSTOM LENGTH COMPONENTS OF MATCHING SIZE. SUBSTITUTIONS SHALL MEET THE ORIGINAL STRUCTURAL INTENT.

- 1. ALL PIPE GRADE A53-B OR BETTER.
- 2. HOT-DIPPED GALVANIZED PER ASTM A123.
- 3. ALL HOLES ARE 11/16" DIA. U.N.O
- 4. HOLES MAY OR MAY NOT BE PRESENT, DEPEND UPON MANUFACTURE DISCRETION.
- 5. ALL FIELD CUT AND DRILLED SURFACES SHALL BE REPAIRED WITH A MINIMUM OF TWO COATS OF ZINGA OR ZINC COTE PER ASTM A780 AND MANUFACTURER'S RECOMMENDATIONS.

VzW SMART Tool® Vendor

verizon^v

FOR REFERENCE **ONLY**

CHECKED BY: HMA/KW BT 08/04/21

> VZWSMART STANDARD PIPE

SHEET NUMBER: VZWSMART-PIPE

REV #:




West Roger WT

Milwaukee, Wisconsin

STRUCTURAL ANALYSIS REPORT FOR VERIZON (#113278)

March 12, 2021 KOA PROJECT NO.: 202001.46

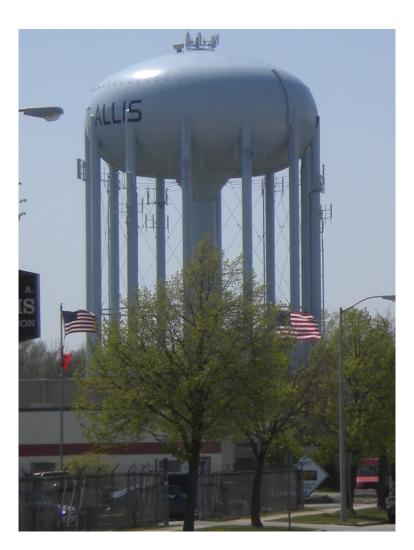

PREPARED BY:

KRECH OJARD & ASSOCIATES, INC. 101 PUTNAM ST. EAU CLAIRE, WI 54703 715-552-7374

PROFESSIONAL SEAL:





Site Name: West Roger WT Site Number: 113278

VERIZON ANTENNA SUMMARY:

Verizon is proposing to install new antennas and equipment at West Roger water tower site. The proposed antennas and equipment are listed below and noted in the Verizon RFDS dated 9/14/2020. The proposed antennas and equipment will be mounted to existing mounts located on the legs of the tank. Analysis of the existing mounts are by others. The following report is a design check on the tank stability & overturning to support the proposed Verizon equipment. The tank analysis was performed in accordance with the AWWA D100-11. A basic wind speed of 90 MPH, Exposure C, with an importance factor of 1.15 was used in the analysis.

Proposed Final Verizon Antenna and Equipment Summary

- (6) Commscope NHH-65C-R2B (RAD = 101')
- (3) L-Sub6 Antenna w/ VZE01 RRU (RAD = 103')
- (3) Andrew HBX-9016DS-VTM (RAD = 101')
- (3) Commscope CDX1923Q-DS-43 (RAD = 101')
- (6) RRU 8843 (RAD = 101')
- (3) RRU 4449 (RAD = 101')
- (3) Raycap RC3DC-3315-PF-48 (RAD = 101')
- (3) Ericsson 4408 w/ KRE 105 281/1 (RAD = 99')
- (6) Coaxial cables
- (3) Hybrid Cables

Existing Other Carrier Equipment to remain:

The following list of existing other carriers on the tank were provided in the PJF corral mount analysis and Telamon CLS SA report. There are assumed to be no additional antennas or equipment on the tank besides those listed below.

Equipment on Water Tower:

- Beacon (RAD = 187'-0")
- AT&T Commscope SBNHH-1D65C (RAD = 177'-0")
- AT&T Commscope NHH4-65B-R6H4 (RAD = 177'-0")
- AT&T Commscope NHH4-65B-R6 (RAD = 177'-0")
- (3) AT&T Ericsson RRRUS-32 (RAD = 177'-0")
- (3) AT&T Ericsson RRRUS 32 B66 (RAD = 172'-6")
- (3) AT&T Ericsson RRRUS 4449 (RAD = 172'-6")
- (3) AT&T Ericsson RRRUS 4415 (RAD = 172'-6")
- (3) AT&T Ericsson RRRUS 4478 (RAD = 172'-6")
- (3) AT&T Raycap DC6-48-60-18-8C (RAD = 172'-6")
- AT&T Raycap DC6-48-60-0-8C (RAD = 172'-6")
- Unknown 60"x6.5" Panel (RAD = 130'-0")
- (9) Unknown 72"x6" Panel (RAD = 125'-0")
- Sprint Commscope SBCHH-1D90B (RAD = 118'-0")
- Sprint KMW ET-X-TS-70-15-62-18-IR-RD (RAD = 118'-0")
- Sprint Samsung M-MIMO AAU (RAD = 118'-0")
- Sprint Samsung RRH-P4 (RAD = 118'-0")
- Sprint Samsung RRH-C2A w/ Extra Filter (RAD = 118'-0")
- (3) T-Mobile Andrew TMBXX-6517-A2M (RAD = 112'-0")
- (3) T-Mobile Nokia AAFIA (RAD = 112'-0")



Equipment on Water Tower Continued:

- (3) T-Mobile TMA (RAD = 112'-0")
- (3) T-Mobile Nokia COVP (RAD = 112'-0")
- (3) Unknown 60"x6" Panel (RAD = 110'-0")
- (3) Unknown 48"x6" Panel (RAD = 110'-0")

WATER TANK ANALYSIS RESULTS SUMMARY:

The water tower has been analyzed for the original and proposed new antenna loading. The new antenna layout and mount installation will increase the tanks overturning by 0.88% from the previous antenna installation, and increase the tanks overturning by 11.87% from the original tank design, with all existing carriers included.

Tower Rods:

The tower has two tiers with the top and bottom tiers having 1-3/8" and 1-7/8" diameter A36 rods respectively. The highest stressed rods are designed to approximately 79% of their allowable tensile design stress.

Tower Anchorage:

Each tower leg is anchored with two 1-1/2" diameter anchor bolts. The anchor bolts are assumed to be F1554, Gr. 36 ksi and are stressed to approximately 79% of their allowable design stress.

The water tower is capable of safely resisting the resultant forces from increased overturning and meets the requirements of AWWA D100-11.

REFERENCED DOCUMENTS:

- Verizon RFDS dated 9/14/2020
- Verizon Mount analysis by Paul J. Ford dated January 19, 2021
- Verizon Mount Modification Drawings by Paul J. Ford dated January 19, 2021
- Previous SA report by Telamon CLS dated September 30, 2020
- Previous Verizon SA by Robert Wozniak dated May 19, 2010

ASSUMPTIONS:

- Because the information was not readily available in the information provided, Krech Ojard & Associates made the following assumptions in their analysis:
 - o Tower rods are A36, Gr. 36 ksi steel
 - o Anchor rods are F1554, Gr. 36 ksi steel
- Original self-weight of tank is 599 kips
- Any reinforcement or modifications are assumed to be fully installed and functional.
- The International Existing Building Code (IEBC) states; "Any existing lateral load-carrying structural element whose demand-capacity ratio with the addition considered is no more than 10 percent greater than it's demand-capacity ratio with the addition ignored shall be permitted to remain unaltered." Because seismic loads are proportional to the weight of the structure and the percent increase from the original weight of the proposed weight is less than 10 percent, the applied seismic force and resulting increase in the seismic demand capacity should also be less than 10 percent. Therefore, by inspection, this water tower does not need to be re-evaluated for seismic loads under the current AWWA standard.
- All welds are assumed to have been performed to current welding standards and are assumed to develop
 their full capacity and to be in good condition. All bolts and bolt-like anchors are assumed to be fully
 tightened, fastened or bonded to the manufacturers' specifications and are assumed to have full capacity.
- Soil conditions and foundations are not considered unless specified in the analysis and have no deterioration or defects.
- The information provided to Krech Ojard & Associates for analysis is assumed accurate and up to date. This report is considered void if the listed information or assumptions stated herein is inaccurate.



The tower is assumed to be properly maintained and monitored and this analysis cannot be a considered
a condition assessment of the tower. No accommodations are taken for damaged, rusted, deteriorated,
or otherwise compromised member conditions.

If it is determined that any of these assumptions are not accurate, this analysis is void and an additional analysis should be performed.

EXHIBIT D-1

APPROVED AS-BUILT DRAWINGS AND INVENTORY

[Verizon to provide]

EXHIBIT E

FORM OF ANTENNA SITE SERVICE NOTICE

[City to provide]

EXHIBIT F

CERTIFICATES OF INSURANCE AND POLICY ENDORSEMENTS

[Verizon to provide]

EXHIBIT G

FORM OF MEMORANDUM OF AGREEMENT

MEMORANDUM OF WATER TOWER LICENSE AGREEMENT

<u>Drafted by and return to</u> :	
James C. Remington	
Husch Blackwell LLP	
511 N. Broadway	
Milwaukee, WI 53202	
PIN: 481-9993-028	

MEMORANDUM OF WATER TOWER LICENSE AGREEMENT

THIS MEMORANDUM OF WATER TOWER LICENSE AGREEMENT (the "Memorandum"), is made effective as of the ______ day of _______, 2022, by and between City of West Allis, Wisconsin, a municipal corporation operating a public water utility ("West Allis"), with its principal offices at 7525 W Greenfield Avenue, West Allis, Wisconsin 53214, and Cellco Partnership, a Delaware partnership, d/b/a Verizon Wireless with its principal offices at c/o Verizon Wireless, One Verizon Way, Mail Stop 4AW100, Basking Ridge, New Jersey 07920-1097 ("Verizon").

WITNESSETH:

WHEREAS, this Memorandum is being executed to provide notice of the Agreement and terms thereof in the Office of the Register of Deeds for Milwaukee County, Wisconsin, to place third parties on notice of the Agreement, and West Allis's and Verizon's rights and obligations thereunder, some of which are hereinafter summarized.

NOW, THEREFORE, in consideration of the mutual covenants and promises contained in the Agreement, West Allis and Verizon hereby acknowledge:

1. **PREMISES.** The "**Premises**" is the portion of real property and improvements thereon or to be constructed thereon under the Agreement and located at 11515 West Rogers Street in the City of West Allis, Milwaukee County, Wisconsin, which real property is legally described on <u>Exhibit A</u> attached hereto. The Premises is described and depicted in the Agreement and shall be used for the installation, operation and maintenance of communications equipment and includes a parcel containing

Verizon Site: WEST ROGERS WT - 113278

square feet (the "Land Space"), space on West Allis's water tank (the "Tower Space"), with the non-exclusive right for ingress and egress, seven (7) days a week twenty four (24) hours a day, on foot or motor vehicle, including trucks over or along a right of way extending from the nearest public right of way to the Land Space (the Right of Way Access Easement), and for the installation and maintenance of utility wires, poles, cables, conduits, and pipes over, under, or along the Utility and Cable Easements. Said Land Space and Tower Space are collectively called the "Premises". The Premises is shown on the plat of survey set forth in Exhibit B attached hereto.

- **2. TERM.** The initial term of the Agreement is for a period of five (5) years commencing on the Effective Date and terminating five (5) years thereafter, unless otherwise terminated as provided in the Agreement. Verizon has the option to renew and extend the Agreement for four (4) additional periods of five (5) years each, at such License Fee and upon such other terms as set forth in the Agreement.
- **3. AGREEMENT CONTROLLING.** This Memorandum is only a summary of some of the terms and conditions in the Agreement and is not intended to amend, alter, modify, abrogate, substitute or otherwise affect the terms or conditions in the Agreement, all of which are incorporated herein in full by this reference. It is understood and agreed that, notwithstanding this Memorandum, the terms and conditions contained in the Agreement shall in all events control the relationship between West Allis and Verizon regarding the subject matter therein contained.
- **4. PURPOSE; NO MODIFICATION**. The Memorandum is solely for recording purposes and shall not be construed to alter, modify or supplement the Agreement of which this is a Memorandum.
- **5. NOT A CONVEYANCE**. The Agreement is for less than 99 years and not a conveyance subject to return and fee.

IN WITNESS WHEREOF, West Allis and Verizon have executed this Memorandum is effective as of the date first written above.

[SIGNATURES & EXHIBITS TO APPEAR ON FOLLOWING PAGES]

WEST ALLIS:

City of West Allis, Wisconsin

		By:	
			Name:
			Title:
STATE OF WISCONSIN)		
COUNTY OF) ss.)		
Personally came before me this	day of		, 2022, the above named of City of West Allis, Wisconsin, as such member of such entity, by its authority.
			y Public, State of Wisconsin ommission expires: VERIZON: Cellco Partnership d/b/a Verizon Wireless
		By:	
			Name:
			Title:
STATE OF ILLINOIS)		
COUNTY OF COOK) ss.)		
	, the		, 2022, the above named of Cellco Partnership the foregoing instrument as such member of such
			y Public, State of Illinois ommission expires:

EXHIBIT "A"

Description of the Real Property

EXHIBIT "B"

Survey