

STAFF REPORT WEST ALLIS PLAN COMMISSION Wednesday, January 24, 2024 6:00 PM

Watch: https://www.youtube.com/user/westalliscitychannel

- 2A. Site, Landscaping, and Architectural Design Review for City of West Allis Department of Public Works Facility, a proposed Light Industrial use, at 52** W. Burnham St. & 5032 W. Rogers St. (Tax Key Nos. 474-0002-001 & 474-0003-000).
- 2B. Ordinance to rezone property located at 5032 W. Rogers St. from I-2 to I-1 Industrial (tax key no. 474-0003-000).
- 2C. Certified Survey Map to combine properties located at 52** W. Burnham St. & 5032 W. Rogers St. (Tax Key Nos. 474-0002-001 & 474-0003-000), submitted by the City Engineering Department.

Items 2A, 2B, and 2C may be considered together.

Overview and Zoning

The City of West Allis will be constructing a new public works facility to house their current and future DPW, Engineering, and IT operations and administration function. The site selected/acquired last year is the former Teledyne property located on the eastern gateway to the City of West Allis on the southeast corner of W. Burnham St. and S. 53 St. (8.96-acres), and the former Waste Transfer station at 5032 W. Burnham St. (1.07-acres). Total site area when combined being 10.03-acres. The Teledyne parcel

was
previously
developed
with a
300,000
square feet
industrial
building that
has since
been






demolished. Environmental clean-up and additional site preparation work will be performed in advance of construction.

Site, Landscaping, and Architectural Plans

The proposed new facility will consist of office, shop spaces, vehicle parking on two levels, repair and fabrication bays, wash bays, and mezzanine storage. The project will also consist of a detached cold storage building, an exterior material bin storage lean-to structure, a fuel island (SW corner of property), and a salt and brine storage building (SE corner of property). The new construction will utilize, but is not limited to precast concrete panels, brick finish precast panels, steel structure, membrane roofing, curtain wall and storefront window systems, and precast concrete vehicle parking structure. The project will also include site work containing new asphalt parking lot and drives, new curb and gutter on the site, site fencing, site lighting, landscaping, and security access and monitoring. The staff recommendation reflects recommended clarifications being submitted.

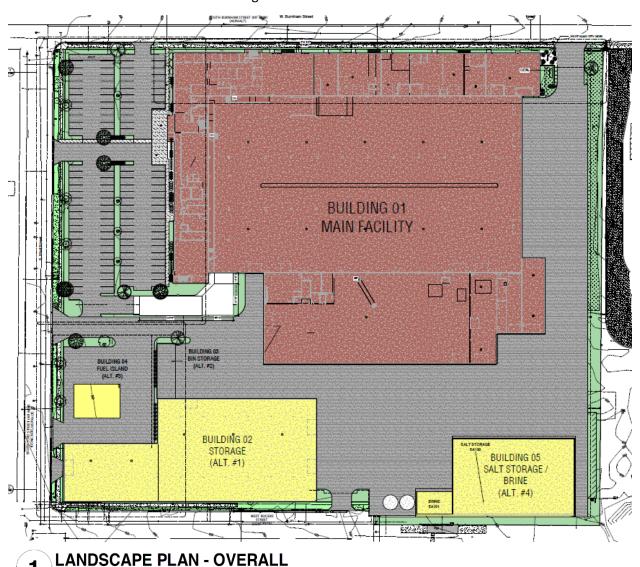

SITE AREAS

TOTAL SITE AREA - 437.484 SQ/FT
TOTAL GREEN SPACE - 28.546
MAIN BUILDING #1 FOOT PRINT - 180,415 SQ/FT
MEZZANINE - 23,194 SQ/FT
MEZZANINE - 23,194 SQ/FT
MIN BUILDING SECOND FLOOR - 120,800 SQ/FT
BUILDING #2 FOOT PRINT - 1,775 SQ/FT
BUILDING #3 FOOT PRINT - 1,775 SQ/FT
BUILDING #4 FOOT PRINT - 27,45 SQ/FT
BUILDING #5 FOOT PRINT - 29,560 SQ/FT
BUILDING #5 FOOT PRINT - 19,300 SQ/FT
TOTAL PAVEMENT - 125,583 SQ/FT

1" = 30'-0"

LANDCOADE COLIEDIU E

Type	Key	Botanical Name	Common Name	Planting Size	Comments	QTY
GRASSES						
GRASSES	SSG	Panicum Virgatum 'Shenandoah'	Shenandoah Switch Grass	#1 Cont.		104
GRASSES	TPD	Sporobolus heterolepis 'Tara'	Tara Prairie Dropseed	#1 Cont.		66
SHRUB						
SHRUB	SO	Hemerocallis "Stella de Oro"	Stella de Oro Daylily	#5 Cont.		18
SHRUB	WB	Buxus sinica var. insularis 'Wintergreen'	Wintergreen Boxwood Shrub	#5 Cont.		15
SHRUB	KDR	Cornus sericea 'Kelsey'	Kelsey's Dwarf Red Twig Dogwood	#3 Cont.		18
SHRUB	CP	Juniperus chinensis 'Kallays Compact'	Kallay Compact Pfitzer Juniper	#3 Cont.		7
TREE						
TREE	CM	Acer x freemanii "Celebration"	Celebration Maple	(Height) 5'-0" - 6'-0"		5
TREE	IH	Gleditsia triacanthos f. inermis 'Impcole'	Imperial Honeylocust	(Height) 5'-0" - 6'-0"		6
TREE	BHS	Picea Glauca Var. Densata	Black Hills Spruce	(Height) 5'-0" - 6'-0"		10
TREE	JL	Syringa reticulata	Japanese Tree Lilac	(Height) 4'-0" - 5'-0"		4
TREE	RB	Betula Nigra	River Birch	(Height) 4'-0" - 5'-0"		5

Staff Comments – recommended items bulleted and noted in staff recommendation (last page). Detailed plan submittal has been included in your packet.

Site & Landscaping

Access to the property is provided on two places along W. Burnham St. The general parking area on the NW side of the site will feature a driveway and a second larger driveway restricted to DPW vehicles on the NE side of the site. A new decorative fence w/ automatic gate will be setback from the W. Burnham St. frontage on the restricted drive ingress/egress to allow truck staging. A new gateway sign will also be located in this area. Three (3) driveways are proposed along S. 53 St and one driveway planned on W. Rogers St. New fencing will be added to separate public vs. restricted areas. More decorative/ornamental variety of fence is planned on street facing sides, while an 8-ft tall chain-link style of fence is planned is less visible portions of the site.

• Recommend fence types and locations being delineated on plans.

The proposed landscaping areas are shown in green and landscaping plantings and species schedule to correspond with plans is recommended.

- Additional landscaping on the SE and E side of the site in otherwise void areas has been recommended.
- Additional infill landscaping at the recommendation of the City Forester.

<u>Architectural and Exterior Lighting</u> Staff has worked with the Architect and City team to deliver what we believe to be an attractive building in alignment with zoning and the Design Review Guidelines. Staff are recommending more detail on exterior lighting around the buildings and on site.

 Recommend a photometric plan being submitted. Full cut-off fixtures and light directed downward to avoid splay beyond property limits.

Building Size and Location

For zoning purposes, the front yard is considered S. 53 St. While W. Burnham St. and W. Rogers St. are considered side yards areas and the rear yard being the east side/east city limit. The building conforms to the building size and location requirements in <u>sec. 19.41</u> (when consolidated via CSM).

<u>Parking</u>

Parking for 159 spaces will be provided on site and consist of 119 outdoor spaces (includes 4 ADA) and 40 indoor parking spaces. There are currently about 168 employees in the DPW, 17 in Engineering and 10 in the IT Department. Bicycle parking will also be provided on site.

Storm water Management

A storm water management plan is being prepared and will be submitted for review. The new underground retention system will be placed under the paved parking areas (NW side of site). The storm water plans will also likely include bio-filtration system within green areas of the parking lot. Stormwater plans are reviewed by AECOM for compliance with MMSD (Milwaukee Metro Sewerage District) and WDNR water quality regulations.

Recommend stormwater management ordinance compliance.




CONCEPT RENDERING - NORTHEAST BURNHAM ENTRANCE

Ordinance to Rezone (2B) – The former Waste Transfer station property at 5032 W. Rogers St. is zoned I-2 Industrial and the 52** W. Burnham St. property (former Teledyne) is zoned I-1, Industrial. Staff advises Plan Commission to recommend Common Council approve a rezoning the 5032 W. Rogers St. property to be consistent with the larger 8.96-acre property. Rezoning would also support zoning consistency between sites, and the Comprehensive plan. Rezoning is recommended in advance or along with the CSM. A rezoning application to the Common Council would then be scheduled for public hearing and consideration.

<u>Certified Survey Map (2C)</u> – Consolidation of properties is planned, and the Engineering Department is preparing a Certified Survey Map that will be submitted for staff and Milwaukee County technical review.

The consolidation of lots will provide conformance with the zoning code and comprehensive plan. Completion of any technical corrections to the CSM, then the Common Council will consider the CSM.

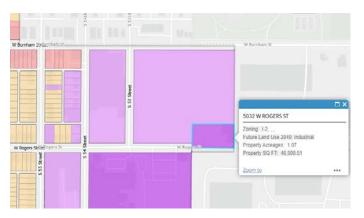



Recommendation (2A): Approve the Site, Landscaping, and Architectural Design Review for City of West Allis Department of Public Works Facility, a proposed Light Industrial use, at 52** W. Burnham St. & 5032 W. Rogers St. (Tax Key Nos. 474-0002-001 & 474-0003-000), subject to the following conditions:

- Revised Site, Landscaping, and Architectural plans being submitted to the Planning and Zoning Office to show the following: (a) delineate fencing (material types, height and location) on plans: (b) Additional landscaping on the SE and E side of the site. Additional infill landscaping within proposed green spaces per City Forester recommendation; (c) a photometric plan being submitted. Full cut-off fixtures and light directed downward to avoid splay beyond property limits: (d) canopy elevation being provided.
- Documentation and approval showing compliance with the City of West Allis Storm water
 Management Ordinance, to be submitted to the Building Inspections and Neighborhood Services
 Department by a registered Civil Engineer. A storm water permit must be obtained from the City.

Recommendation (2B): Council approval of an Ordinance to rezone property located at 5032 W. Burnham St. from I-2 to I-1 Industrial (Tax Key No. 474-0003-000).

Recommendation (2C): Council approval of a certified survey map to combine 52** W. Burnham St. & 5032 W. Rogers St. (Tax Key Nos. 474-0002-001 & 474-0003-000), subject to submittal and technical corrections.



10505 Corporate Drive, Suite 100 Pleasant Prairie, Wisconsin 53158 telephone: 262.857.8101 website: www.kuenyarch.com

Architectural Design Review – Letter of Intent

PROJECT: West Allis Public Works

Public Works Facility 53rd & W Burnham Street, West Allis WI, 53219

1. Purpose of Request

a. The City of West Allis will be constructing a new facility to house their current and future operations and administration function. The facility will consist of new administration office, shop spaces, vehicle parking on two levels, repair and fabrication bays, wash bays, and mezzanine storage. The project will also consist of a cold storage building, exterior material bin storage lean-to structure, fuel island, and salt and brine storage building. The new construction will utilize, but is not limited to precast concrete panels, brick finish precast panels, steel structure, membrane roofing, curtain wall and storefront window systems, and precast concrete vehicle parking structure. The project will also include site work containing new asphalt parking lot and drives, new curb and gutter on the site, site fencing, site lighting, landscaping, and security access and monitoring.

2. Construction Schedule

a. Start Construction

b. Target Substantial Completion / Target Occupancy

April 01, 2024 May 01, 2025

3. Project Team

- a. Architect (Kueny Architects) "KA"
 - i. Jon P. Wallenkamp Architect, AIA / ALA
 - 1. Email: jonw@kuenyarch.com
 - 2. Phone: 262.857.8101
 - ii. John Schmidbauer Structural Engineer, P.E.
 - iii. Lee S. Anderson Job Captain
- b. Civil / Engineer (Terra Tec)
 - i. Linda Johnson
- c. Mechanical (ROOT Engineering)
 - i. Adam Harris, P.E., LEED A.P.

4. Business Description

The Department of Public Works is a multi-functional department charged with the responsibility of providing a variety of services to the public as well as maintaining the City's multi-million dollar infrastructure.

Services provided by the Department of Public Works include:

- a. Maintenance and repair of the City's buildings and street signs by the Building and Sign Division
- b. Maintenance of the City's street lighting and traffic control signals by the

- Electrical Division
- c. Maintenance of the City's street trees and public grounds by the Forestry Division
- d. Garbage and recyclables collection and disposal by the Sanitation Section
- e. Maintenance of the City's streets, alleys, sidewalks and sewer systems by the Street and Sewer Section
- f. Provision of safe and sufficient drinking water and water for fire protection by the Water Division

5. Hours of Operation

Friday 7:15 AM-3 PM
Saturday 8 AM-3:30 PM
Sunday Closed
Monday 7:15 AM-3 PM
Tuesday 7:15 AM-3 PM
Wednesday 7:15 AM-5 PM
Thursday 7:15 AM-3 PM

6. Site Area

- a. Total site area 437,484 sq/ft
- b. Total green space 28,546
- c. Total pavement 125,583 sq/ft
- d. Main building #1 foot print 180,415 sq/ft
- e. Main building second floor 120,800 sq/ft
- f. Building #2 foot print 38,560 sq/ft
- g. Building #3 foot print 1,775 sq/ft
- h. Building #4 foot print 2,745 sq/ft
- i. Building #5 foot print 38,560 sq/ft
- j. Building #6 foot print 19,300 sq/ft

GENERAL NOTES

- 1. All concrete to test 4000 psi in 28 days.
- Verify all dimensions, access, utilities and working conditions in the field. Conform to all applicable codes, ordinances and safety standards.
- Obtain and pay for all required permits and fees. 5. Notify Architect immediately if work cannot proceed as shown on Drawings or as described in the Specifications.
- 6. No concrete to be poured without Architect's prior review. All Contractor's to co-operate with all trades, Owner's and Architect's representatives. 8. Leave site clean, neat and free of debris at all times.
- 9. Each Prime and Sub-contractor is responsible for having read each page of the Specifications, Drawings, Addenda and Change Orders. 10. Guard against interfering with Owner's operations. 11. These Drawings contain no provisions or procedures for on-site safety. Each Contractor and

their employees are responsible to follow all laws and ordinances and provide their own

- engineering to provide a safe work place. 12. The locations of existing underground utilities, shown on these Drawings, are shown in an approximate way only and have not been independently verified by the Owner or its representatives. The Contractor shall determine the exact location of all existing utilities before commencing work, and agrees to be fully responsible for any and all damages which might be occassioned by the Contractor's failure to exactly locate and preserve any and all underground
- 13. Services perform for this project have been conducted in a manner consistent with the level of care and skill ordinarily exercised by members of the profession currently practicing in this area under similar budget and time constraints. No warranty, expressed or implied, is made.

PROJECT INFO

City of West Allis Public Works Facility

December 29, 2023

SITE INFORMATION: TOTAL SITE AREA - 437,484 SQ/FT TOTAL GREEN SPACE - 28,546

MAIN BUILDING #1 FOOT PRINT - 180,415 SQ/FT MAIN BUILDING SECOND FLOOR - 120,800 SQ/FT

BUILDING #2 FOOT PRINT - 38,560 SQ/FT

TOTAL PAVEMENT - 125,583 SQ/FT

BUILDING #3 FOOT PRINT - 1,775 SQ/FT BUILDING #4 FOOT PRINT - 2,745 SQ/FT

BUILDING #5 FOOT PRINT - 38,560 SQ/FT

BUILDING #6 FOOT PRINT - 19,300 SQ/FT

CONSULTANTS

ARCHITECT Kueny Architects 10505 Corporate Drive, Suite 100 (262) 857-8101 Pleasant Prairie, Wisconsin 53158 Architect of Record - Jon P. Wallenkamp

4215 Grove Avenue

TerraTec Engineering W67N222 Evergreen Blvd., Suite 205 (262) 377-9905 Cedarburg, WI 53012 Project Manager - Linda Johnson

Root Engineering Services, P.C. 4215 Grove Avenue (847) 249-8398 Gurnee, Illinois 60031

Project Manager - Adam Harris MECHANICAL Root Engineering Services, P.C.


Gurnee, Illinois 60031 Project Manager - Adam Harris

ELECTRICAL Root Engineering Services, P.C. 4215 Grove Avenue (847) 249-8398 Gurnee, Illinois 60031 Project Manager - Adam Harris



CERTIFICATION

I hereby certify that this engineering document was prepared by me or under my direct personal supervision and that I am a duly licensed Professional Engineer under the laws of the State of Wisconsin.

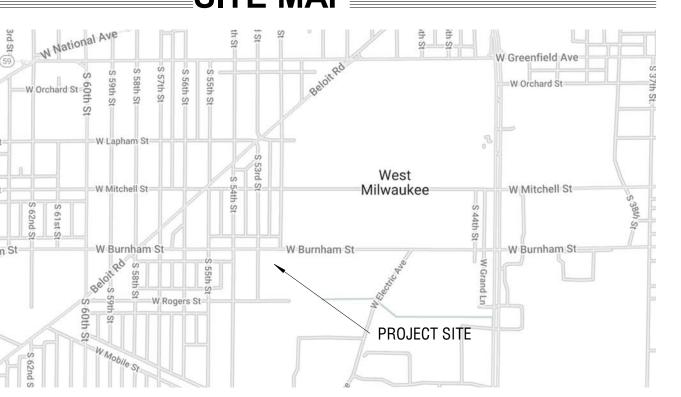

Exterior Elevations - Building 05 PC214

TITLE

1A101

1A102

1A103

1A104

PC213

ARCHITECTURAL

ARCHITECTURAL SITE

01

1A200 1A208 1A209 2A201 3A201 5A201 PC210 PC211 PC212

> R100 Exterior Rendering - North Burnham Entrance R101 Exterior Rendering - Northeast Burnham Entrance

Title Sheet

Architectural Site Plan

Landscape Enlarged Plans

Site Details and Standards

Floor Plan - Mezzanine

Floor Plan - Overall Floor / VP-1

Exterior Elevations - Area A/B/C

Exterior Elevations - Area C/E/G

Exterior Elevations - Area G/F Exterior Elevations - Building 02/03

Building 02 - Floor Plan - Overall Plan

Floor Plan - Overall Second Floor Office / VP-2

Building 03 - Floor Plan - Overall - Bin Storage

Floor Plan - Overall Plan - Salt Storage / Brine

Landscape Plan

SHEET INDEX



Printed or typed name: Jon P. Wallenkamp

License number My license expiration date is:

Pages or sheets covered by this seal:

Engineer under the laws of the State of Wisconsin.

MECHANICAL ENGINEER I hereby certify that this engineering document was prepared by me or under

Printed or typed name: Adam Harris

Pages or sheets covered by this seal: __

STRUCTURAL ENGINEER

I hereby certify that this engineering document was prepared by me or under my direct personal supervision and that I am a duly licensed Professional Engineer under the laws of the State of Wisconsin.

Printed or typed name: John F. Schmidbauer

License number My license expiration date is:

Pages or sheets covered by this seal: _

CIVIL ENGINEER

I hereby certify that this engineering document was prepared by me or under my direct personal supervision and that I am a duly licensed Profession Engineer under the laws of the State of Wisconsin.

Printed or typed name: Linda Johnson

License number My license expiration date is:


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CONCEPT RENDERING - 53RD AND BURNHAM ENTRANCE

Public Works Facility City of West Allis

53rd & W Burnham Street West Allis WI, 53219


SITE, LANDSCAPING, AND ARCHITECTURAL DESIGN REVIEW DECEMBER 29, 2023

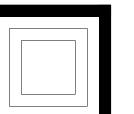

KUENY ARCHITECTS, LLC

phone: 262.857.8101 web: www.kuenyarch.com



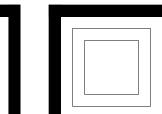

SITE PLAN LEGEND

GRASS AREAS MULCH AREAS

ASPHALT PAVING LANDSCAPE STONE

OONORETE AREAS

SITE AREAS

TOTAL SITE AREA - 437,484 SQ/FT
TOTAL GREEN SPACE - 28,546
MAIN BUILDING #1 FOOT PRINT - 180,415 SQ/FT
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TOTAL PAVEMENT - 125,583 SQ/FT

PROJECT:
Public Works Facility

PROJECT

53rd & W Burnham Street West Allis WI, 53219

OWNER:

PROJECT ISSUE DATE:

City of West Allis

December 29, 2023



10505 Corporate Drive, Pleasant Prairie, WI 53158

phone: 262.857.8101 web: www.kuenyarch.com

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<u>CHITECT</u>

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Root Engineering Services, P.C.

Phone: (847) 249-8398

Address: 4215 Grove Avenue
Gurnee, Illinois 60031

Engineer of Record - Adam Harris

CIVIL


TerraTec Engineering
Phone: (262) 377-9905
Address: W67N222 Evergreen Blvd., Suite 205
Cedarburg, WI 53012

Engineer of Record - Linda Johnson

REVISIONS

REV. / DESCRIPTION

KEY PLAN

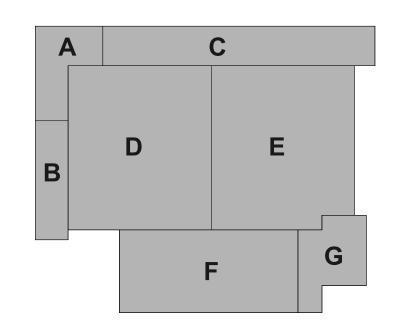



SHEET

SHEET

SHEET TITLE:

Architectural Site Plan

1A101

GRASS SEED

- ALL DISTURBED AREAS SHALL BE RESEEDED. 1- GENERAL: ALL SEED SHALL BE A. FREE FROM NOXIOUS WEED SEEDS AND RECLEANED

B. GRAGE A RECENT CROP SEED C. TREATED WITH APPROPRIATE FUNGICIDE AT TIME OF MIXING. D. DELIVERED TO THE SITE IN SEALED CONTAINERS WITH DEALER'S GUARANTEED ANALYSIS AND SEASON CERTIFICATION OF WEIGHT, PURITY, AND

2- PROPORTIONS BY WEIGHT A. BARON BLUEGRASS 20% B. MAJESTIC BLUEGRASS 20% C. TOUCHDOWN BLUEGRASS 20% D. PENNLAWN FESCUE20% E. FIESTA RYE GRASS 20% (OR APPROVED EQUAL)

LANDSCAPE GENERAL NOTES:


1. RE-GRAD AND RE-SEED ALL DISTUREBED AREAS

2. MULCHED AREAS: 6 FT DIAM. AREA W/ MULCH (4" DEEP) OVER LANDSCAPE PAPER AND PLASTIC LANDSCAPE EDGE AROUND ALL TREES AND BUSHES AS NOTED ON PLANS.

1 LANDSCAPE PLAN - OVERALL
1" = 30'-0"

Botanical Name Common Name Planting Size Comments QTY GRASSES Shenandoah Switch Grass Panicum Virgatum 'Shenandoah' GRASSES Sporobolus heterolepis 'Tara' Tara Prairie Dropseed #1 Cont. #5 Cont. SHRUB Stella de Oro Daylily Hemerocallis "Stella de Oro" SHRUB #5 Cont. Buxus sinica var. insularis 'Wintergreen' Wintergreen Boxwood Shrub Kelsey's Dwarf Red Twig Dogwood #3 Cont. Cornus sericea 'Kelsey' SHRUB #3 Cont. Kallay Compact Pfitzer Juniper Juniperus chinensis 'Kallays Compact' TREE Acer x freemanii "Celebration" Celebration Maple (Height) 5'-0" - 6'-0" TREE Gleditsia triacanthos f. inermis 'Impcole' Imperial Honeylocust (Height) 5'-0" - 6'-0" (Height) 5'-0" - 6'-0" TREE Black Hills Spruce Picea Glauca Var. Densata TREE Syringa reticulata Japanese Tree Lilac (Height) 4'-0" - 5'-0" TREE Betula Nigra River Birch (Height) 4'-0" - 5'-0"

LANDSCAPE SCHEDULE

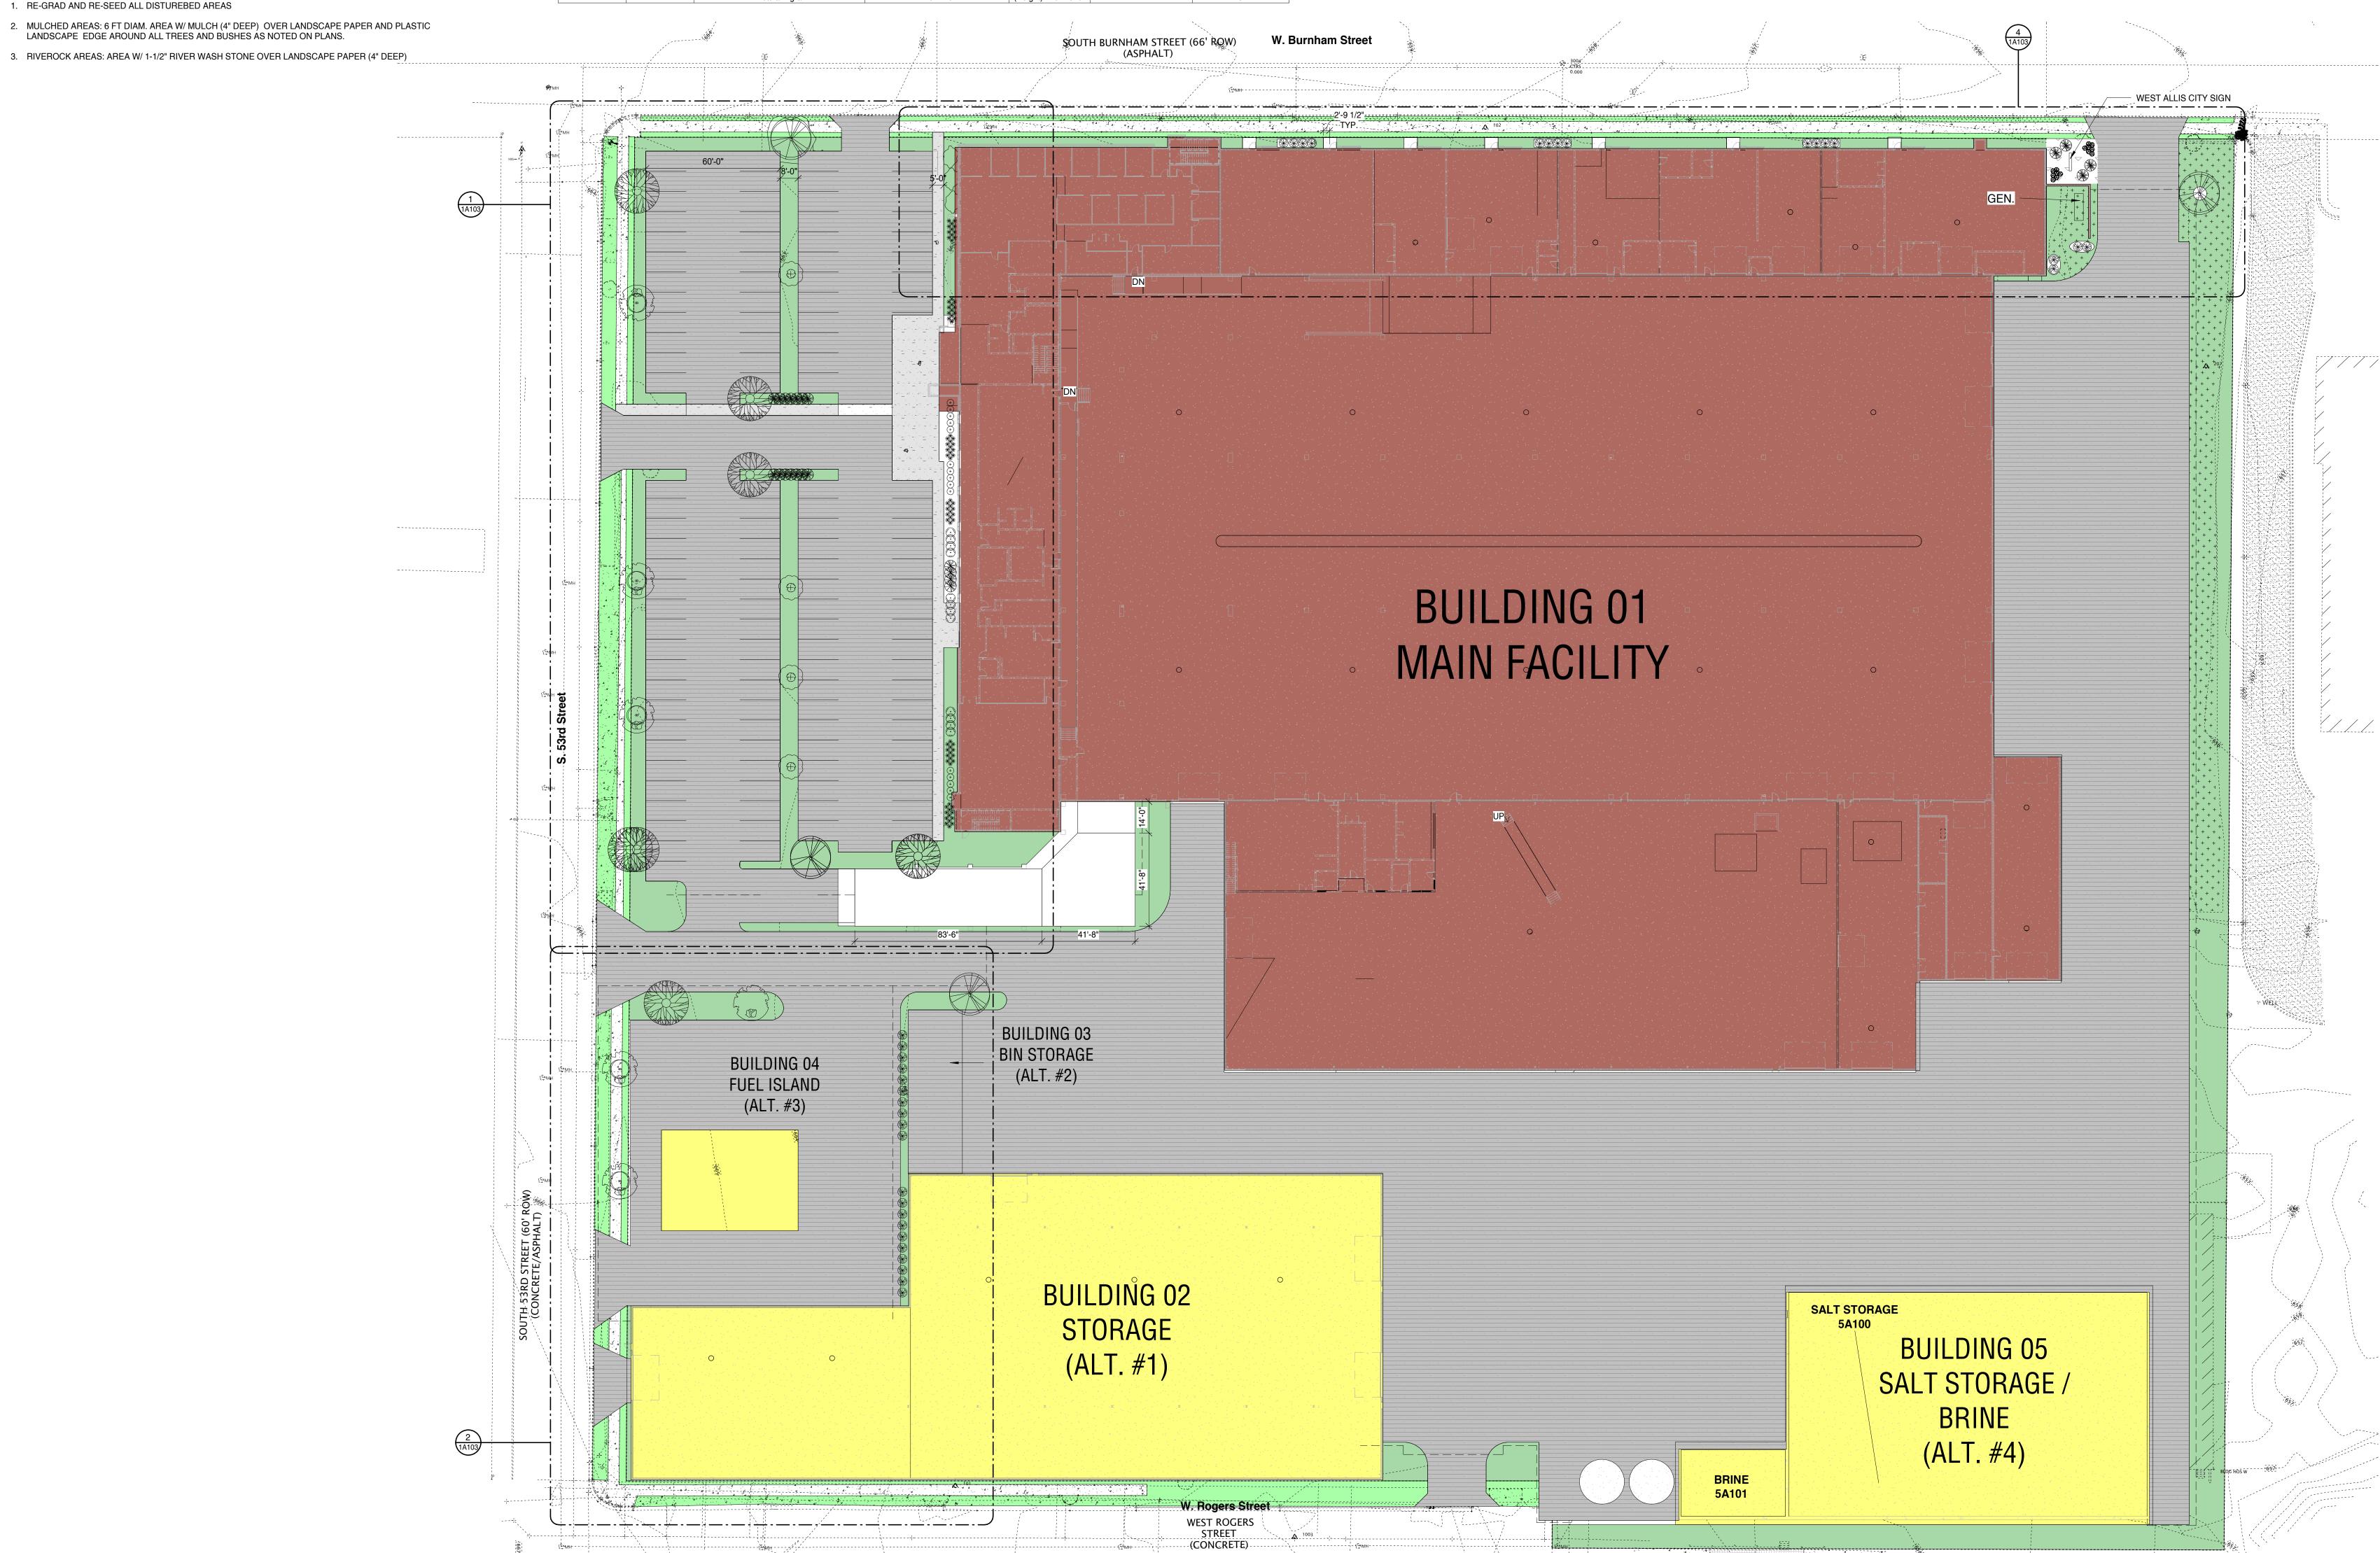

1859

PROJECT

PROJECT:

Public Works Facility

53rd & W Burnham Street West Allis WI, 53219

OWNER:

City of West Allis

PROJECT ISSUE DATE:

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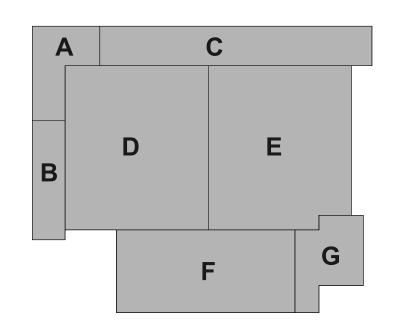
Engineer of Record - Adam Harris

TerraTec Engineering
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Cedarburg, WI 53012

Engineer of Record - Linda Johnson

REVISIONS

KEY PLAN






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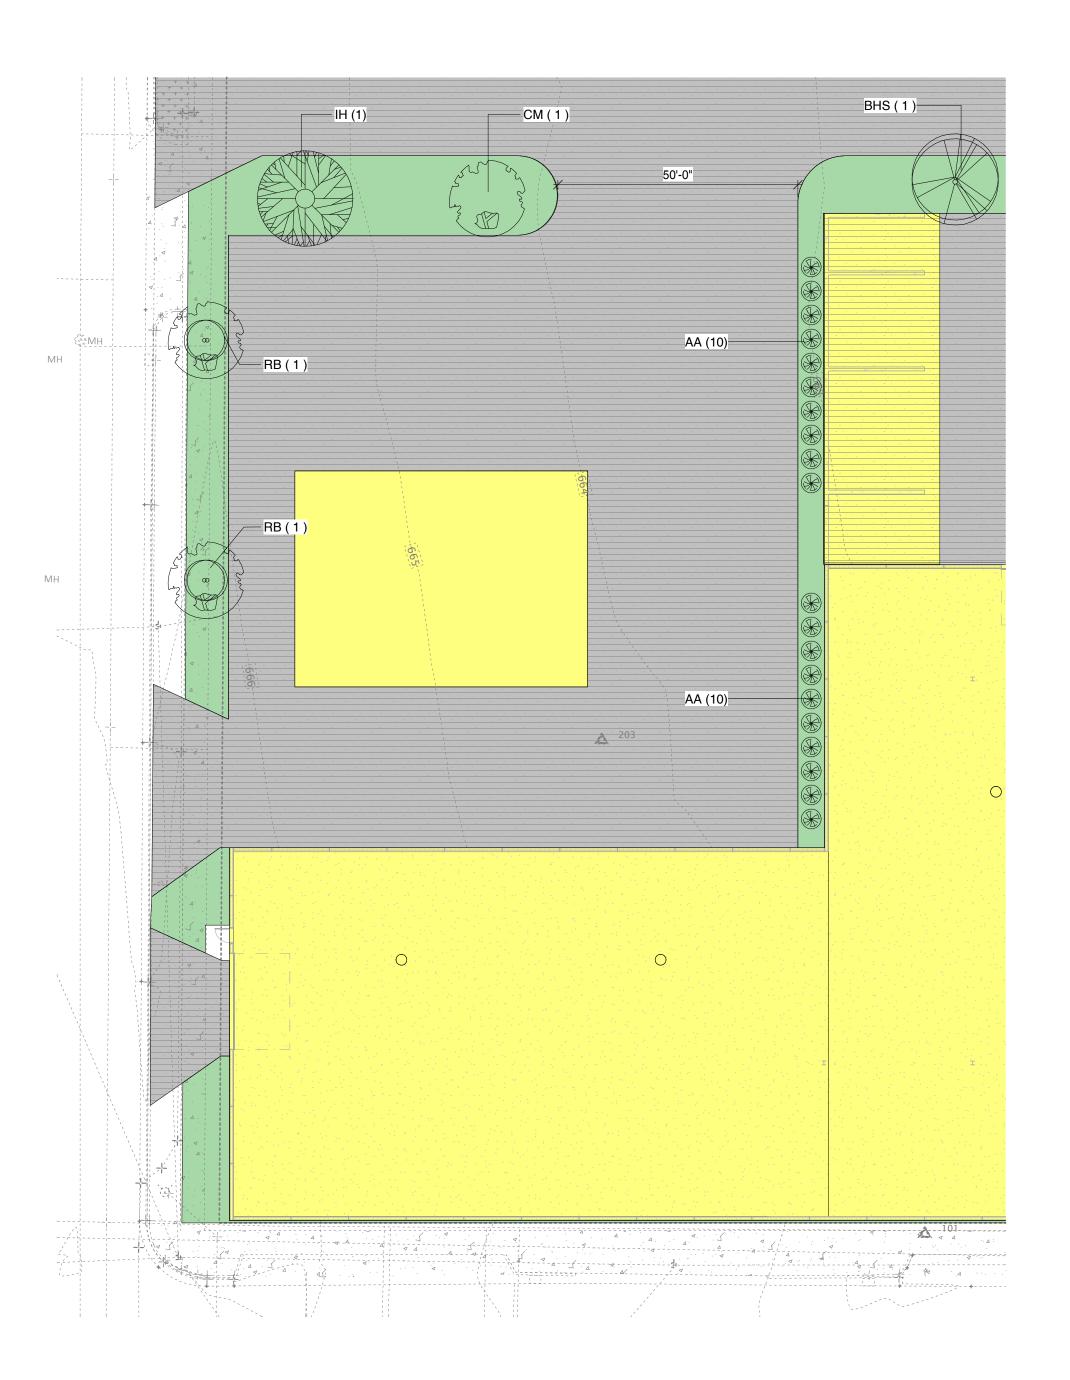
SHEET TITLE:

Landscape Plan


1A102



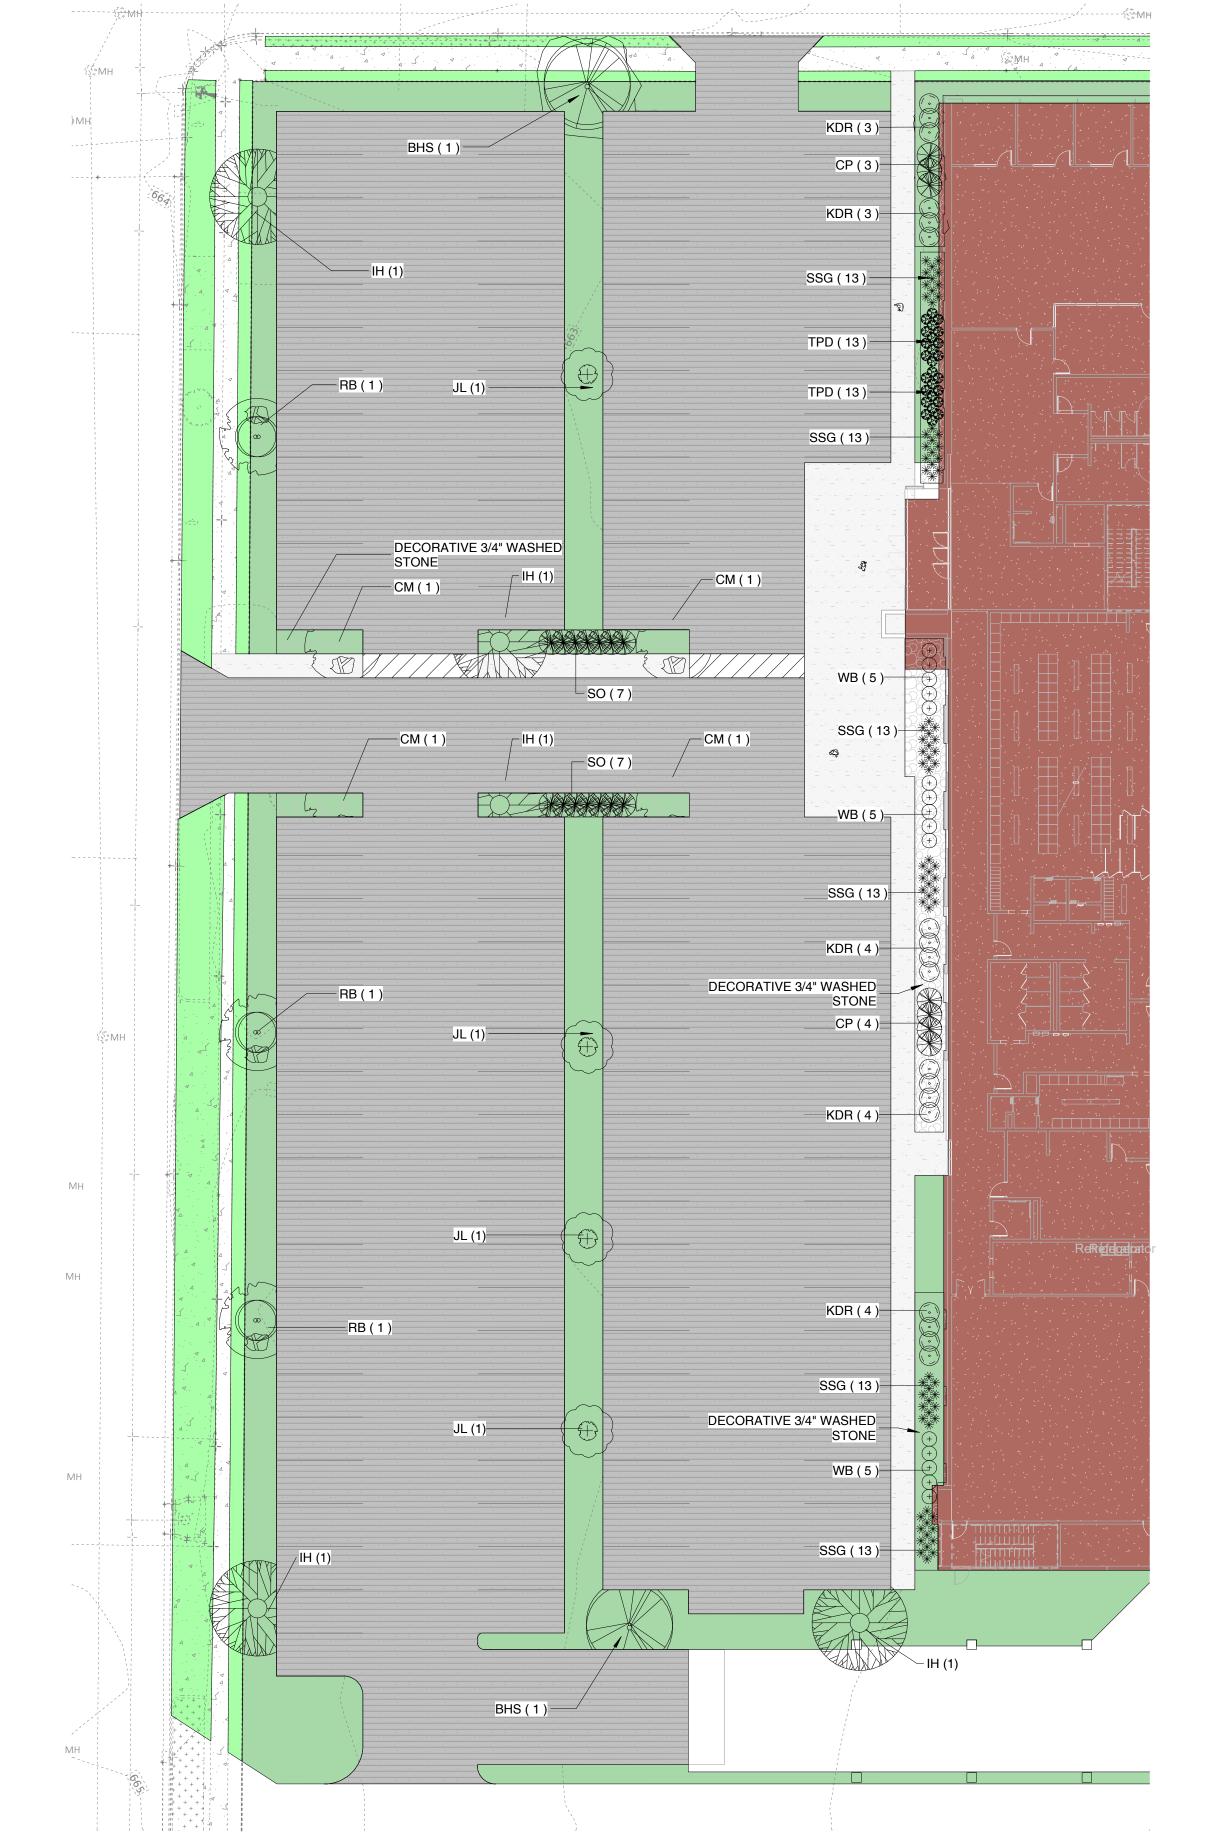



2 LANDSCAPE PLAN - SE CORNER

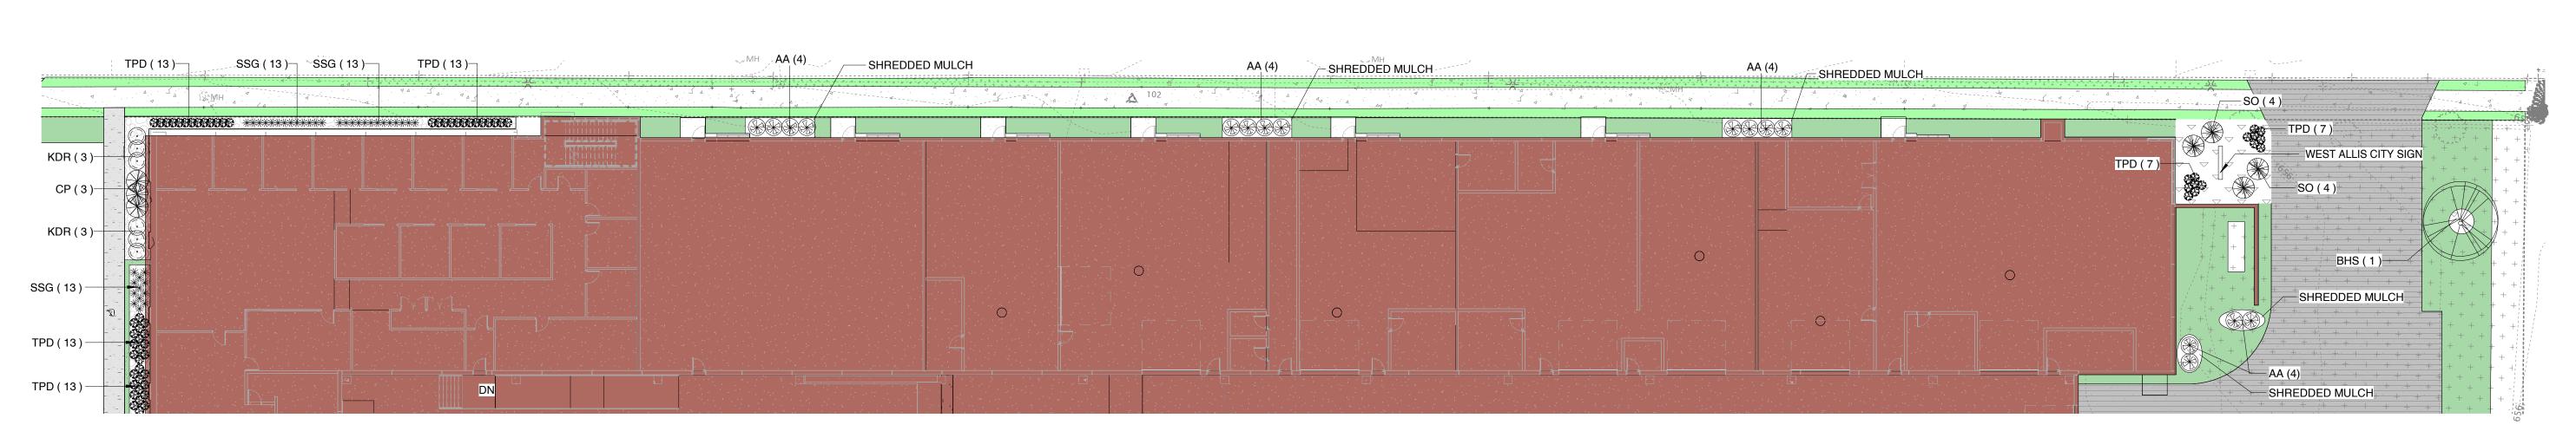

4 LANDSCAPE PLAN - NORTH FACADE

1 LANDSCAPE PLAN - WEST PARKING LOT

PROJECT

PROJECT:
Public Works Facility

53rd & W Burnham Street West Allis WI, 53219

OWNER:
City of West Allis

PROJECT ISSUE DATE:

December 29, 2023



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CIVIL


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Engineer of Record - Linda Johnson

REVISIONS

REV. / DESCRIPTION

KEY PLAN



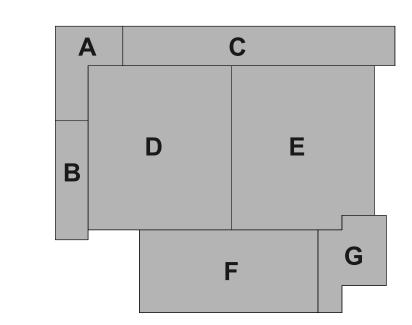

SHEET

SHEET TITLE:

Landscape Enlarged Plans

1A103

- (03 30 00) #4 REBAR & TIES

(03 30 00) 12"Ø CONCRETE BASE FOR FLAG POLE LIGHT FIXTURE.

TOP & 6" AFF. (BY ELECTRICAL

SEE ELECTRICAL PLANS FOR

REQUIRED POWER FEED


CONTRACTOR)

REQUIREMENTS

4, -44

6 Flag Pole - Light Detail

*(2) light typical per flag pole. See plan for light locations

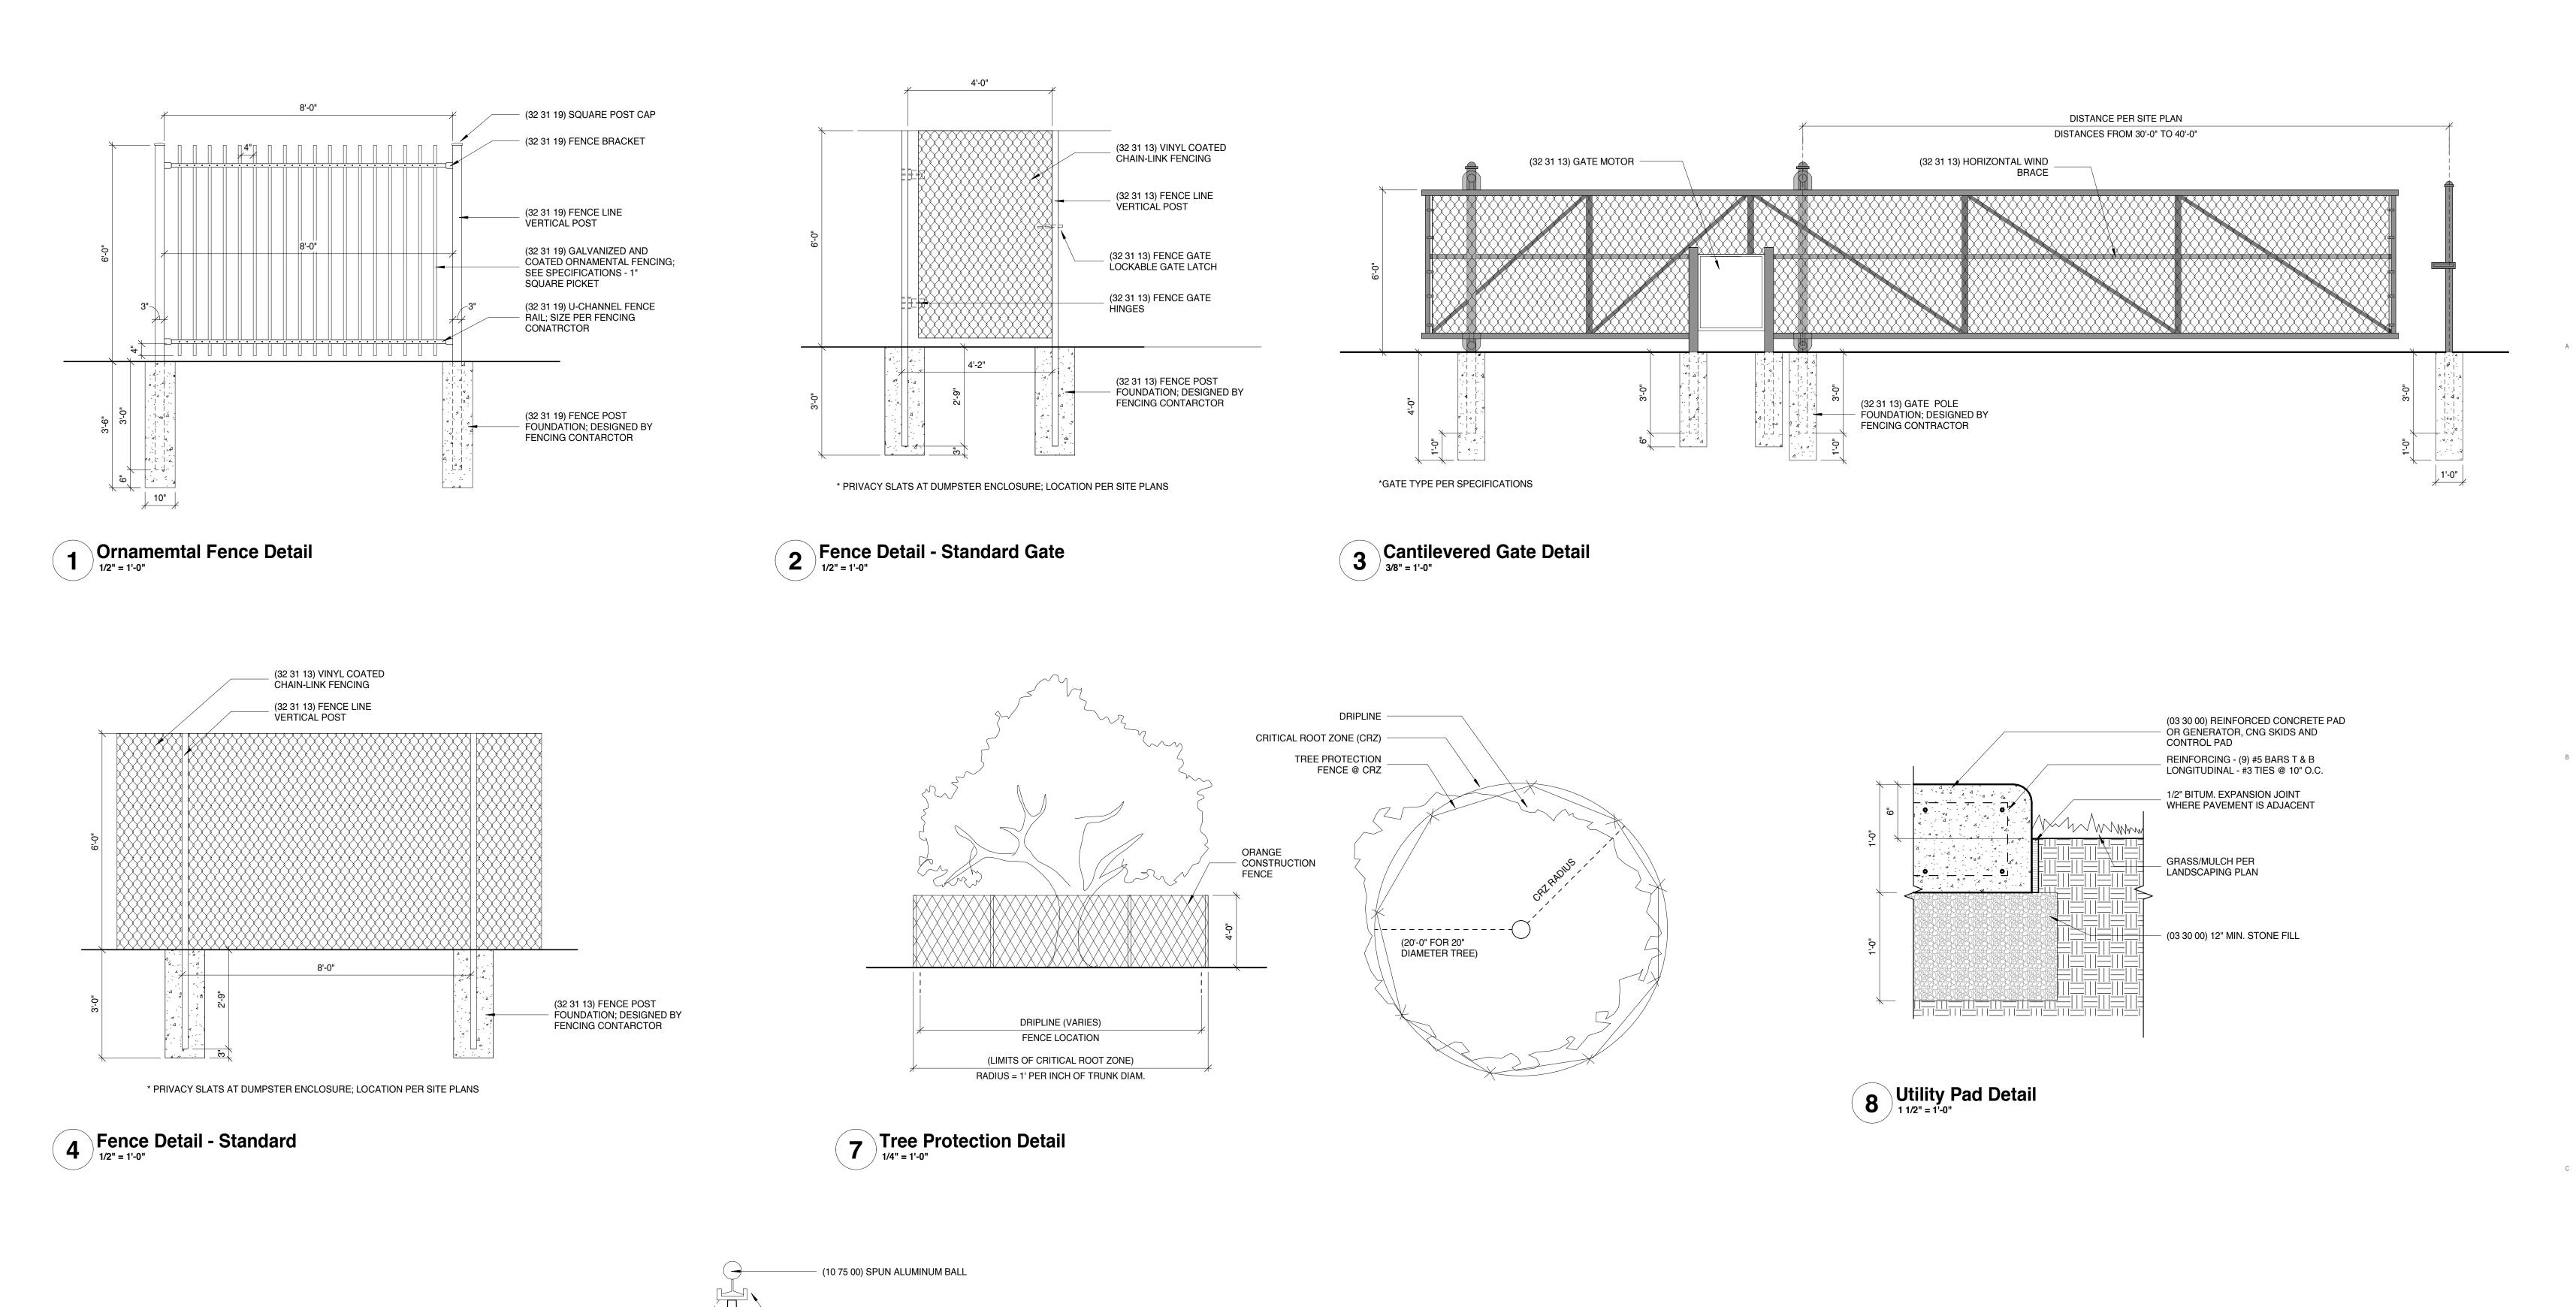

1'-2 1/2"

9 Bike Rack Detail - Typ.

(10 80 00) TYPICAL UNIT SPACING

(10 80 00) 2" DIAMETER STEEL BIKE

RACK; 36" TOTAL UNIT HEIGHT

(10 80 00) 316-GRADE STAINLESS

(03 30 00) CONCRETE SLAB EMBEDED

MOUNTING - FINAL EMBED BY MAN.

— GRADE PER CIVIL PLANS

RECOMMENDATIONS

@ 30" O.C.

(10 75 00) CAST ALUMINUM REVOLVING

(10 75 00) SWIVEL SNAPS WITH COVERS

(10 75 00) TAPERED ALUMINUM FLAG

(10 75 00) CAST ALUMINUM CLEATS W/

CLEAT COVER LOCKABLE BOX

(10 75 00) FLAG POLE MOUNTED LIGHTING SYSTEM; SEE

SPECIFICATIONS - SEE ELECTRICAL FOR POWER REQUIREMENTS

(10 75 00) ALUMINUM FLASH COLLAR

(10 75 00) STEEL GALVANIZED

(10 75 00) FILL PER FLAG POLE MANUFACTURER DESIGN

FLAG POLE CONATRCTOR


(10 75 00) STEEL BASE PLATE

Flag Pole Detail

(10 75 00) LIGHTNING GROUND SPIKE

(10 75 00) CONCRETE FOUNDATION BY

FOUNDATION SLEEVE

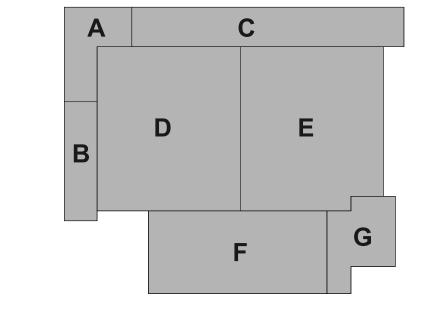

KEY PLAN

PROJECT

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REV. / DESCRIPTION

City of West Allis

PROJECT ISSUE DATE:

December 29, 2023

Public Works Facility

53rd & W Burnham Street West Allis WI, 53219



SHEET

SHEET TITLE:

Site Details and Standards

1A104

PROJECT:

Public Works Facility

53rd & W Burnham Street West Allis WI, 53219

PROJECT ISSUE DATE: December 29, 2023

OWNER:
City of West Allis



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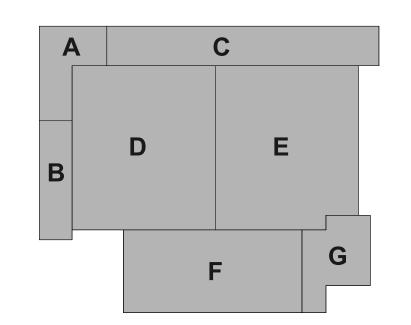
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KEY PLAN






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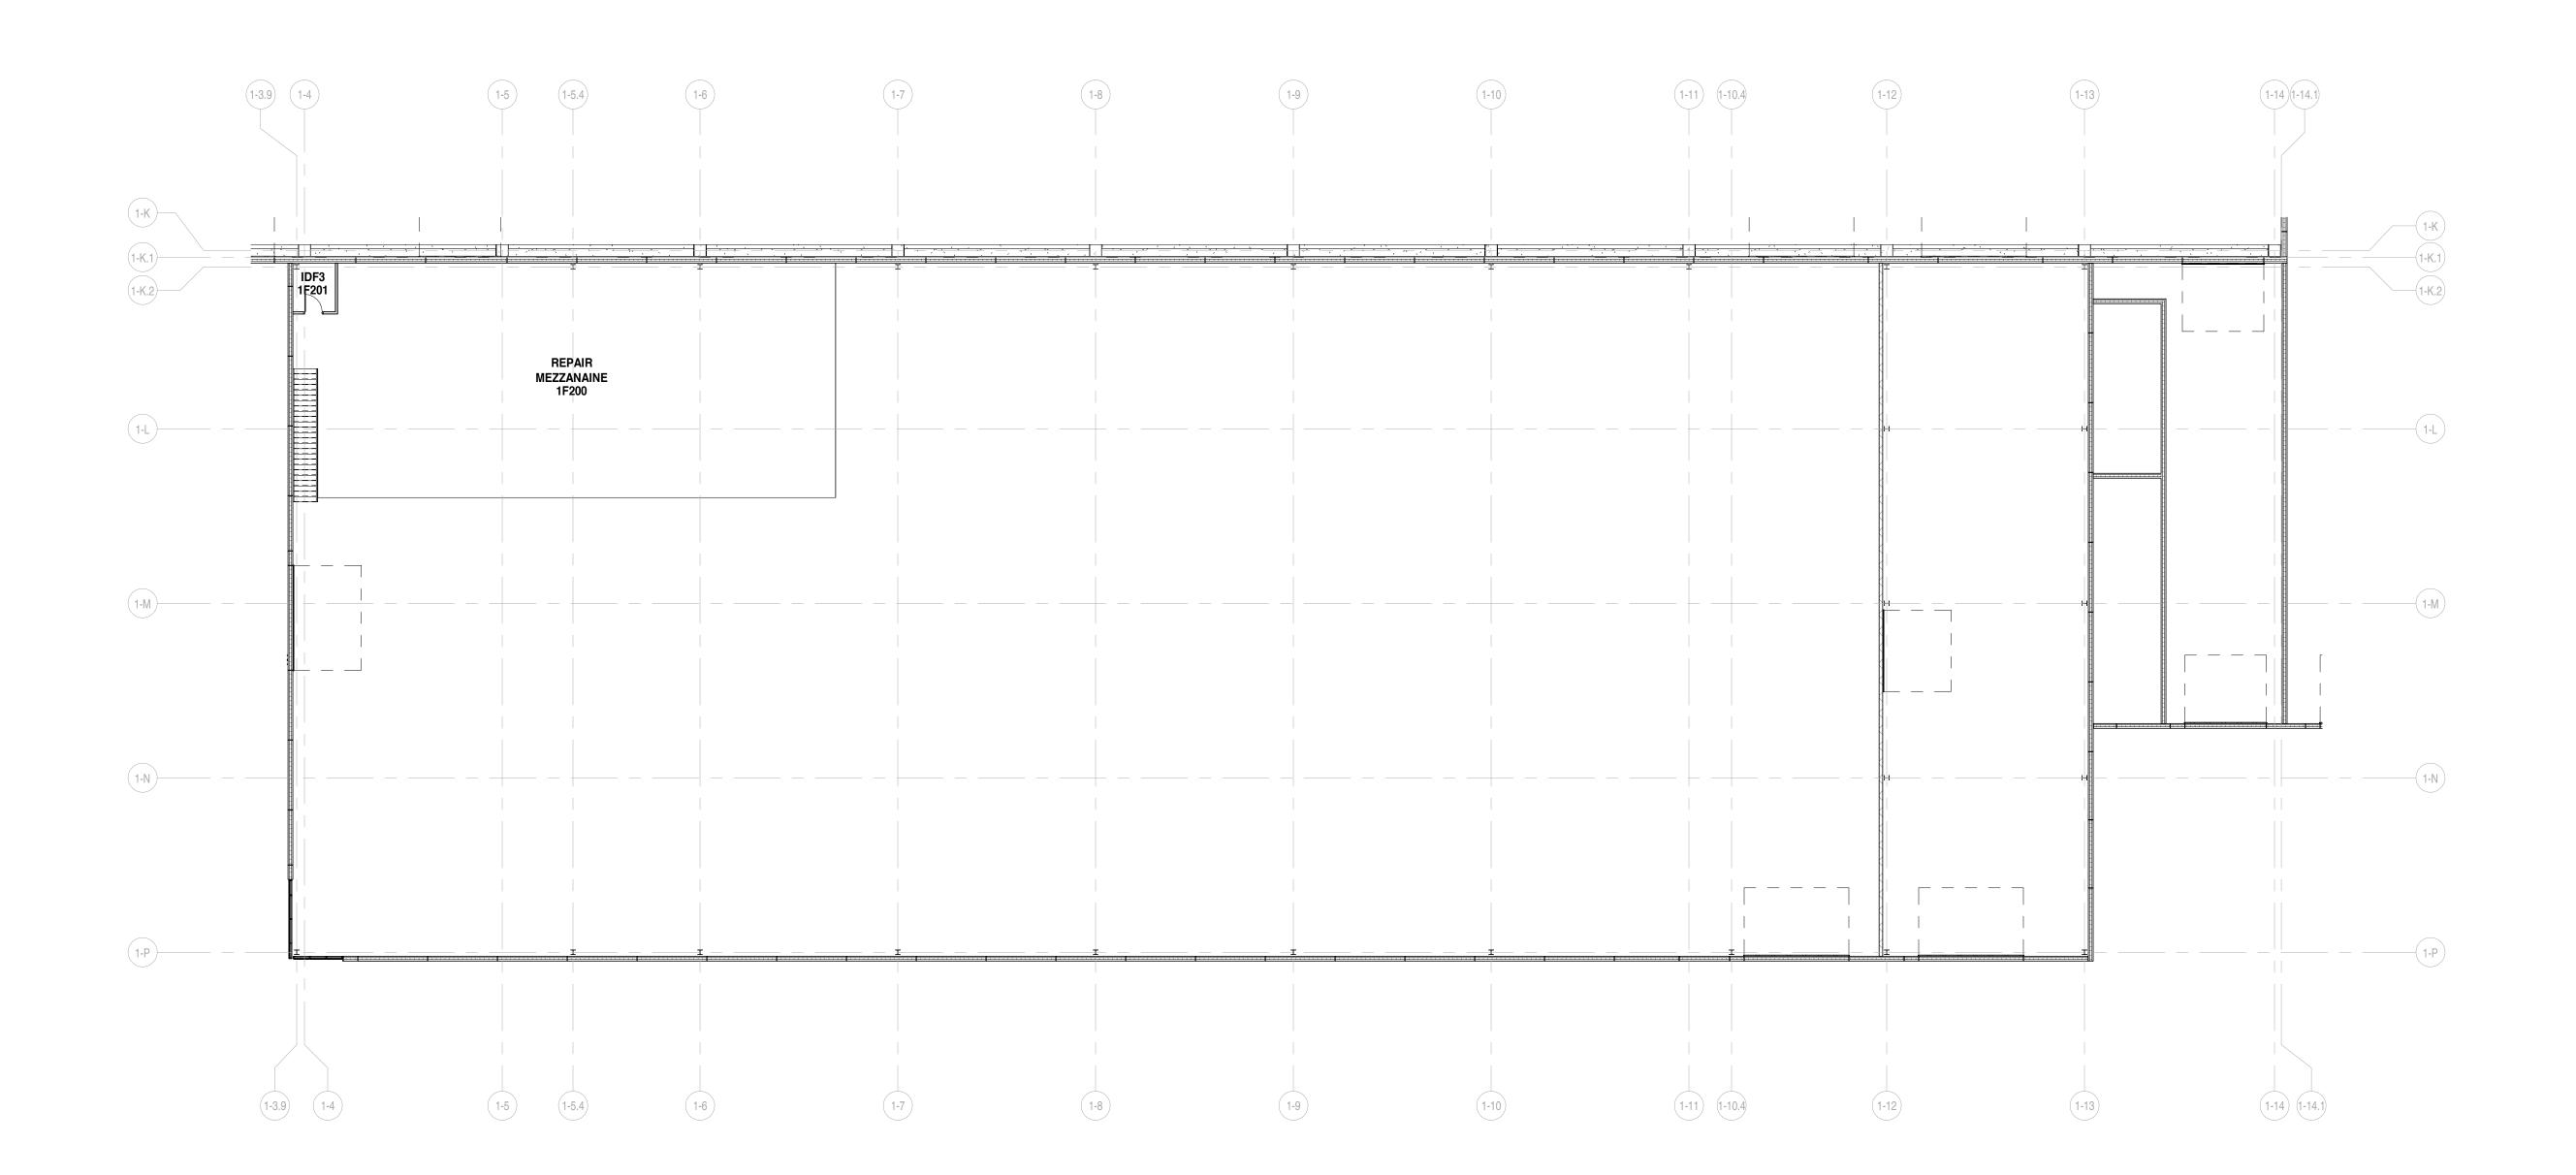
SHEET TITI

Floor Plan - Overall First Floor / VP-1

1 01_FIRST FLOOR - OVERALL PLAN

1A200



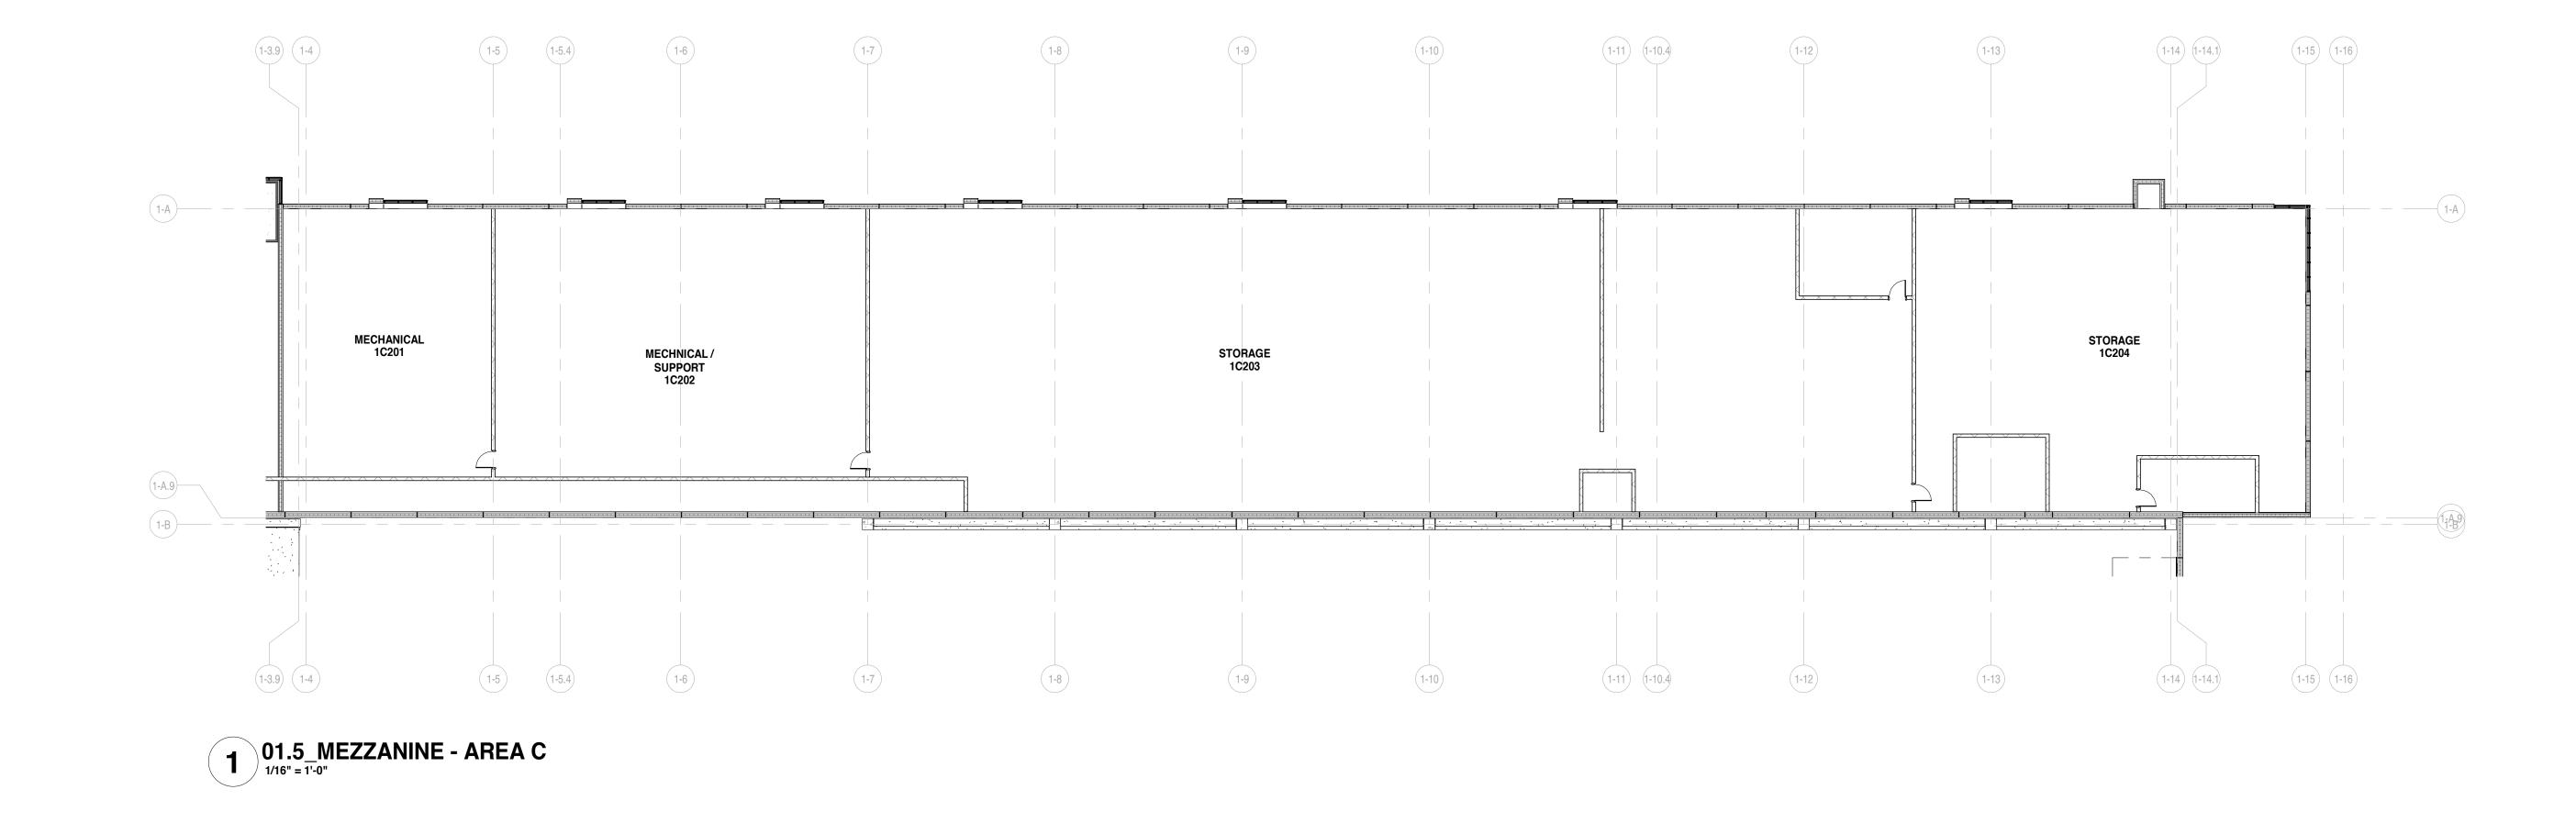

2 01.5 MEZZANINE - AREA F and G

PROJECT

PROJECT:

Public Works Facility

53rd & W Burnham Street West Allis WI, 53219

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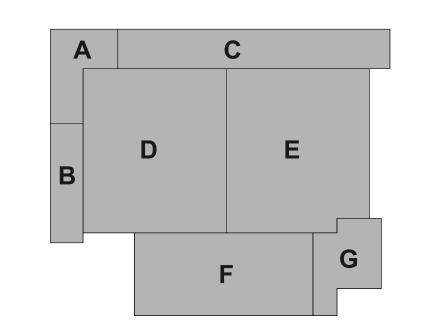
Engineer of Record - Adam Harris



Engineer of Record - Linda Johnson

REVISIONS

KEY PLAN






SHEET

SHEET TITLE:

Floor Plan - Mezzanine

1A208

1 01_SECOND FLOOR OFFICE / VP-2 PLAN 3/64" = 1'-0"

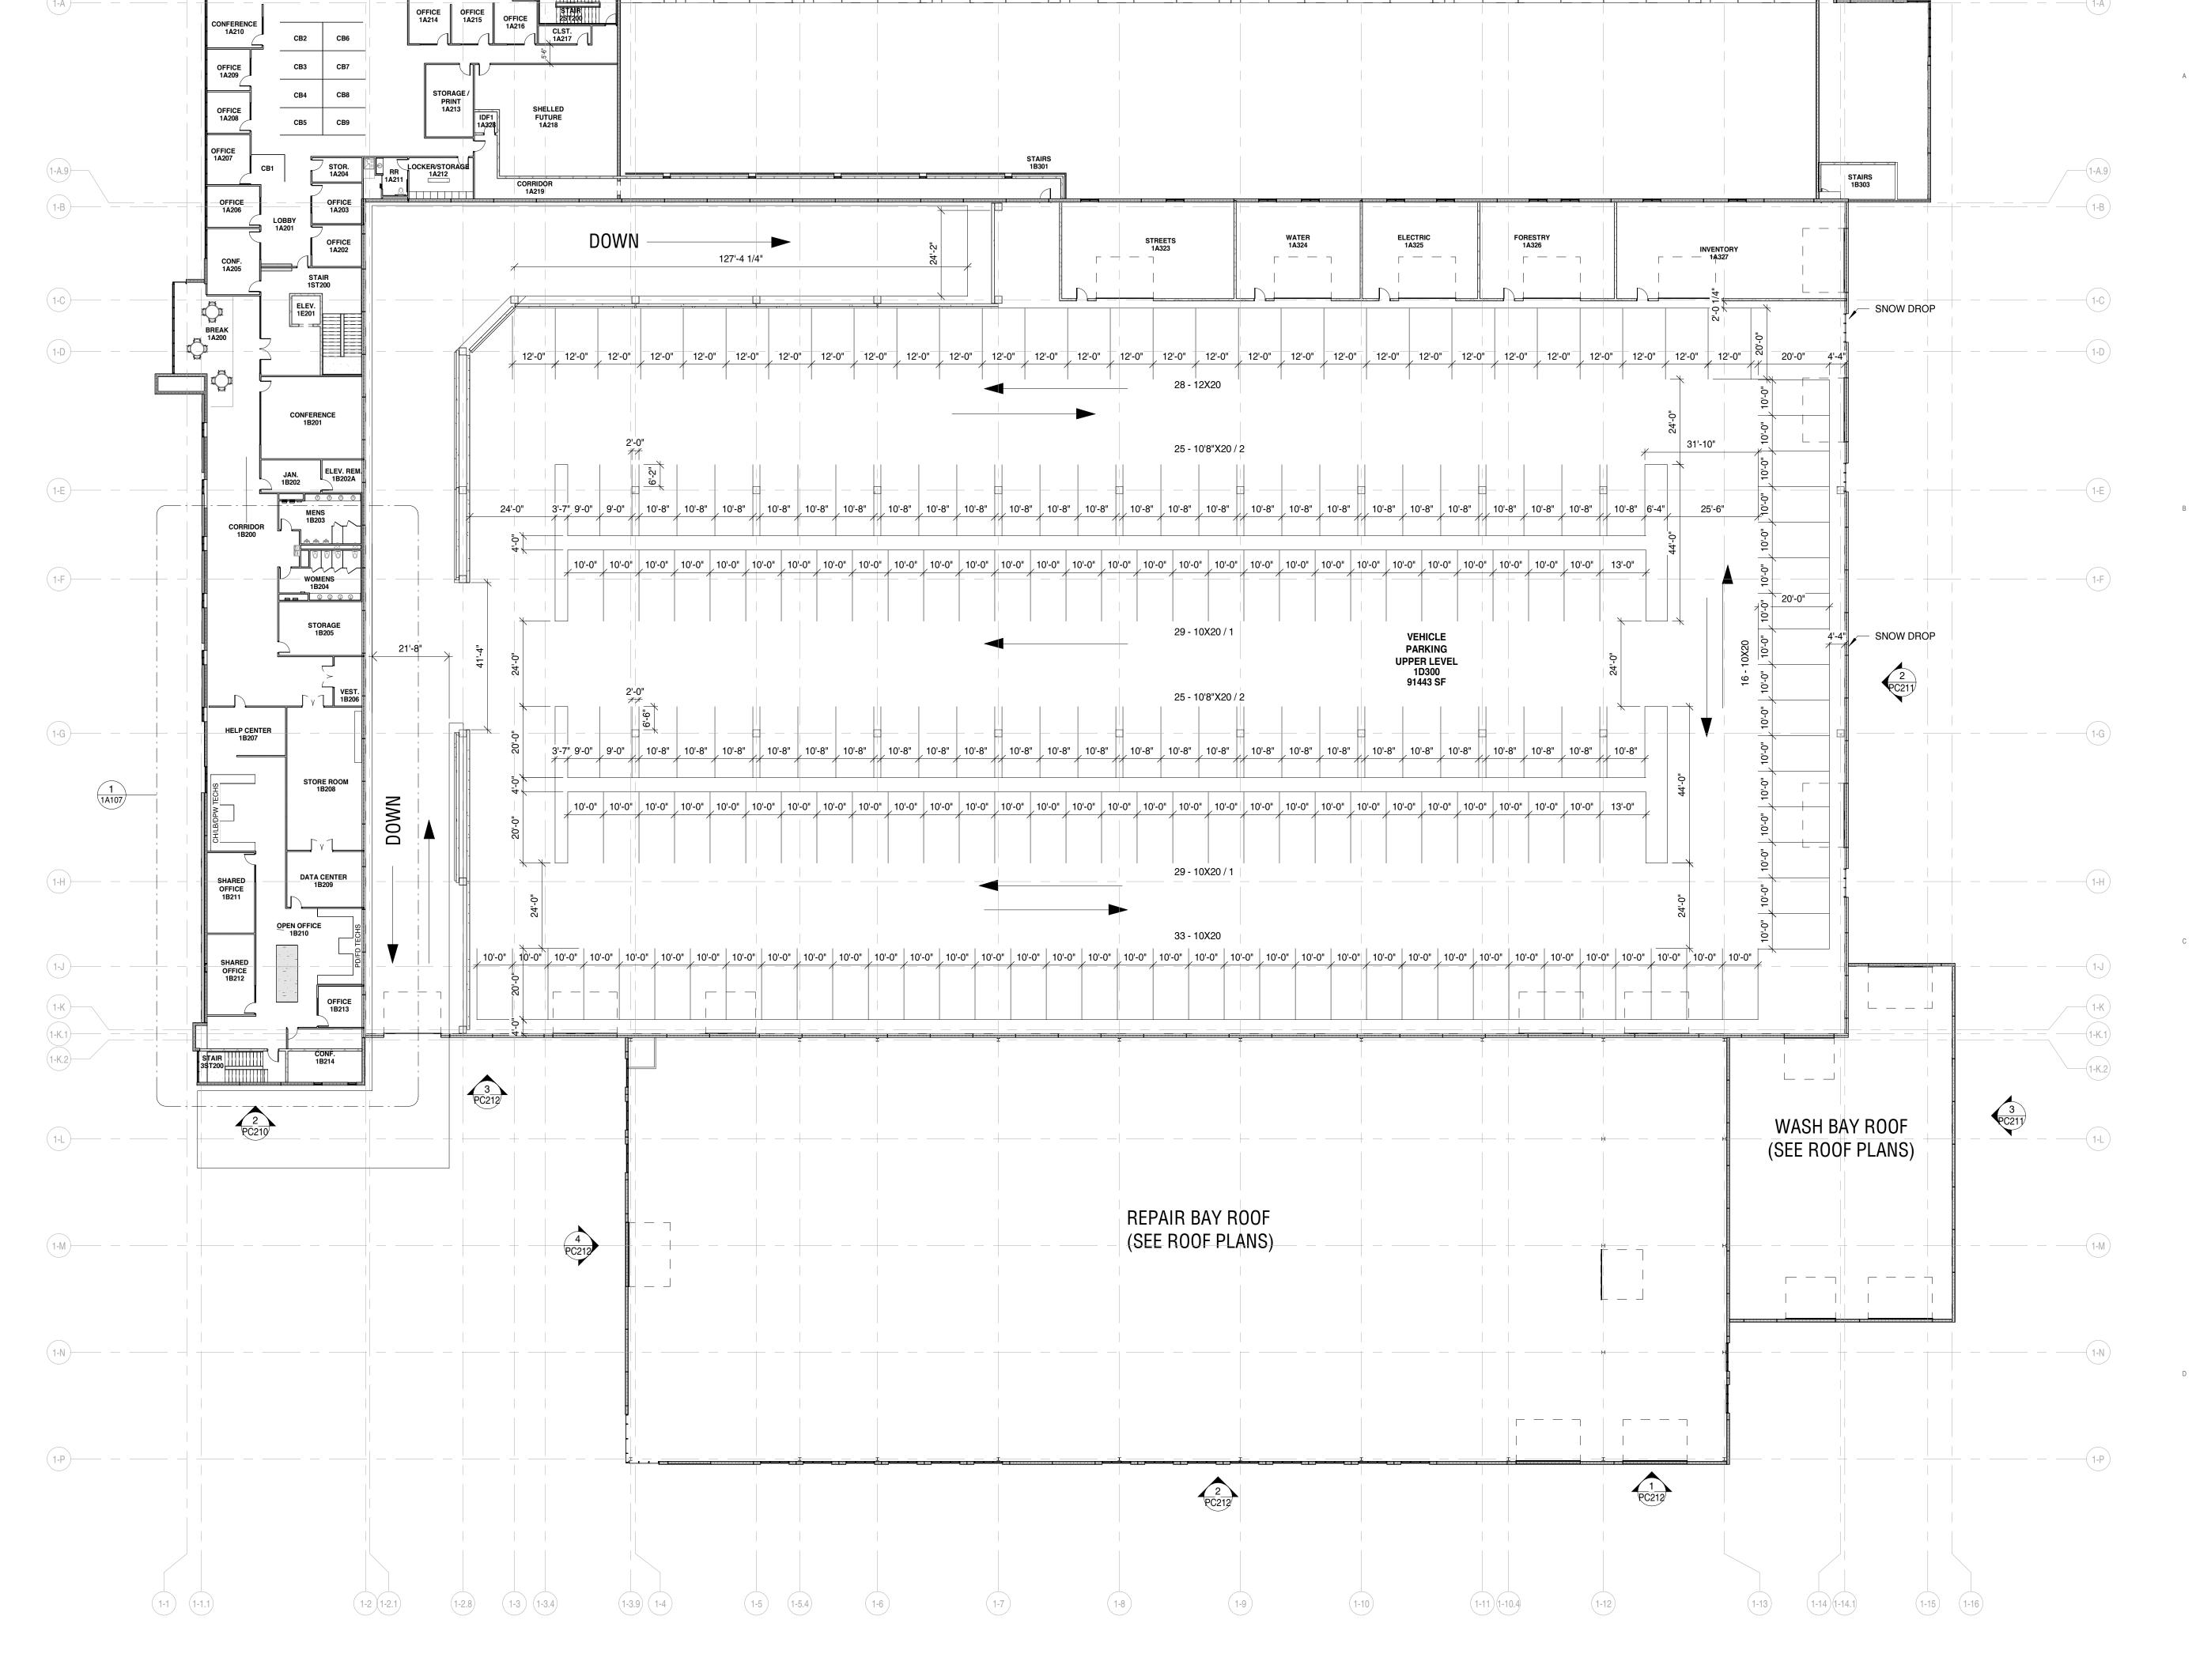

(1-11)(1-10.4)

(1-14) (1-14.1)

(1-15)(1-16)

PROJECT

PROJECT:

Public Works Facility

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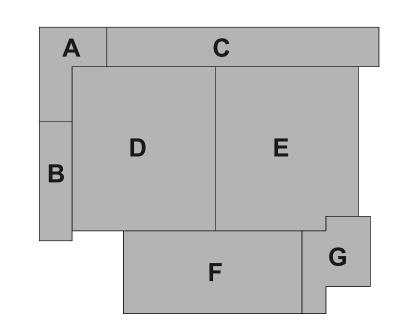
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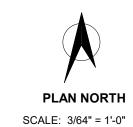
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KEY PLAN






SHEET

SHEET TITLE:

Floor Plan - Overall Second Floor Office / VP-2

1A209

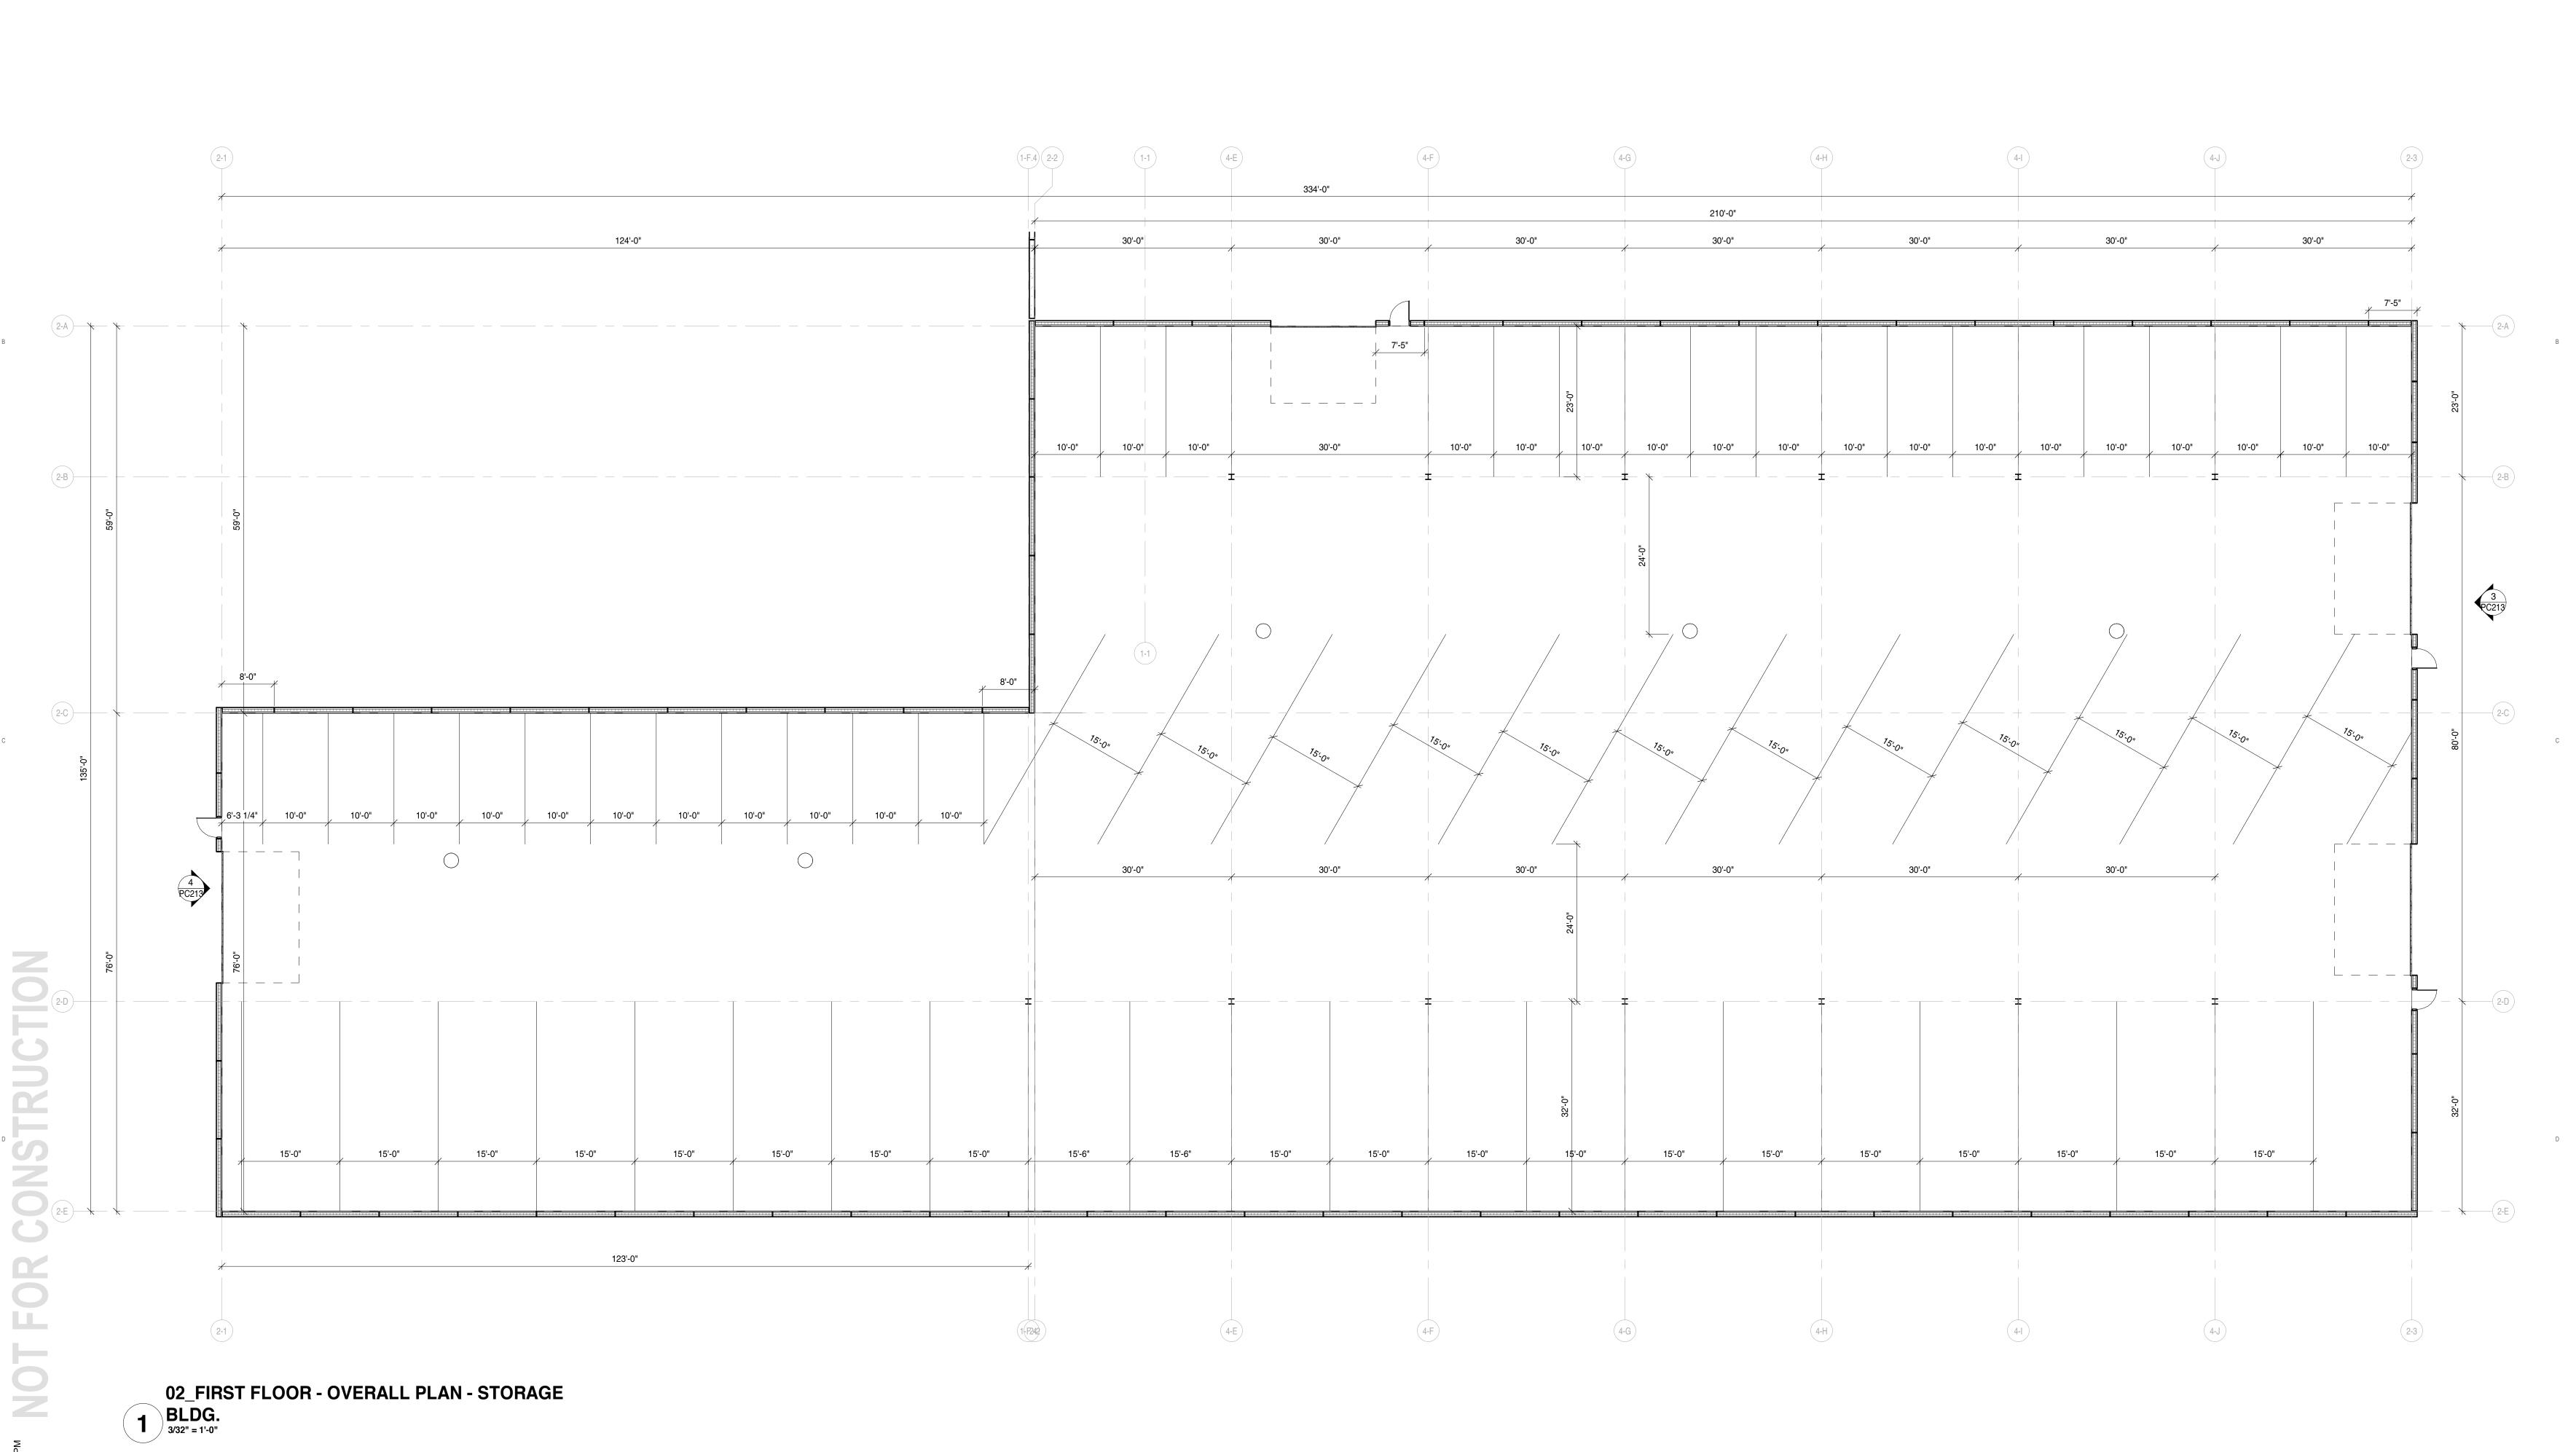

PROJECT:

Public Works Facility

53rd & W Burnham Street West Allis WI, 53219

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REVISIONS

REV. / DESCRIPTION

KEY PLAN




SHEET

SHEET TITLE:

Floor Plan - Overall Plan

2A201

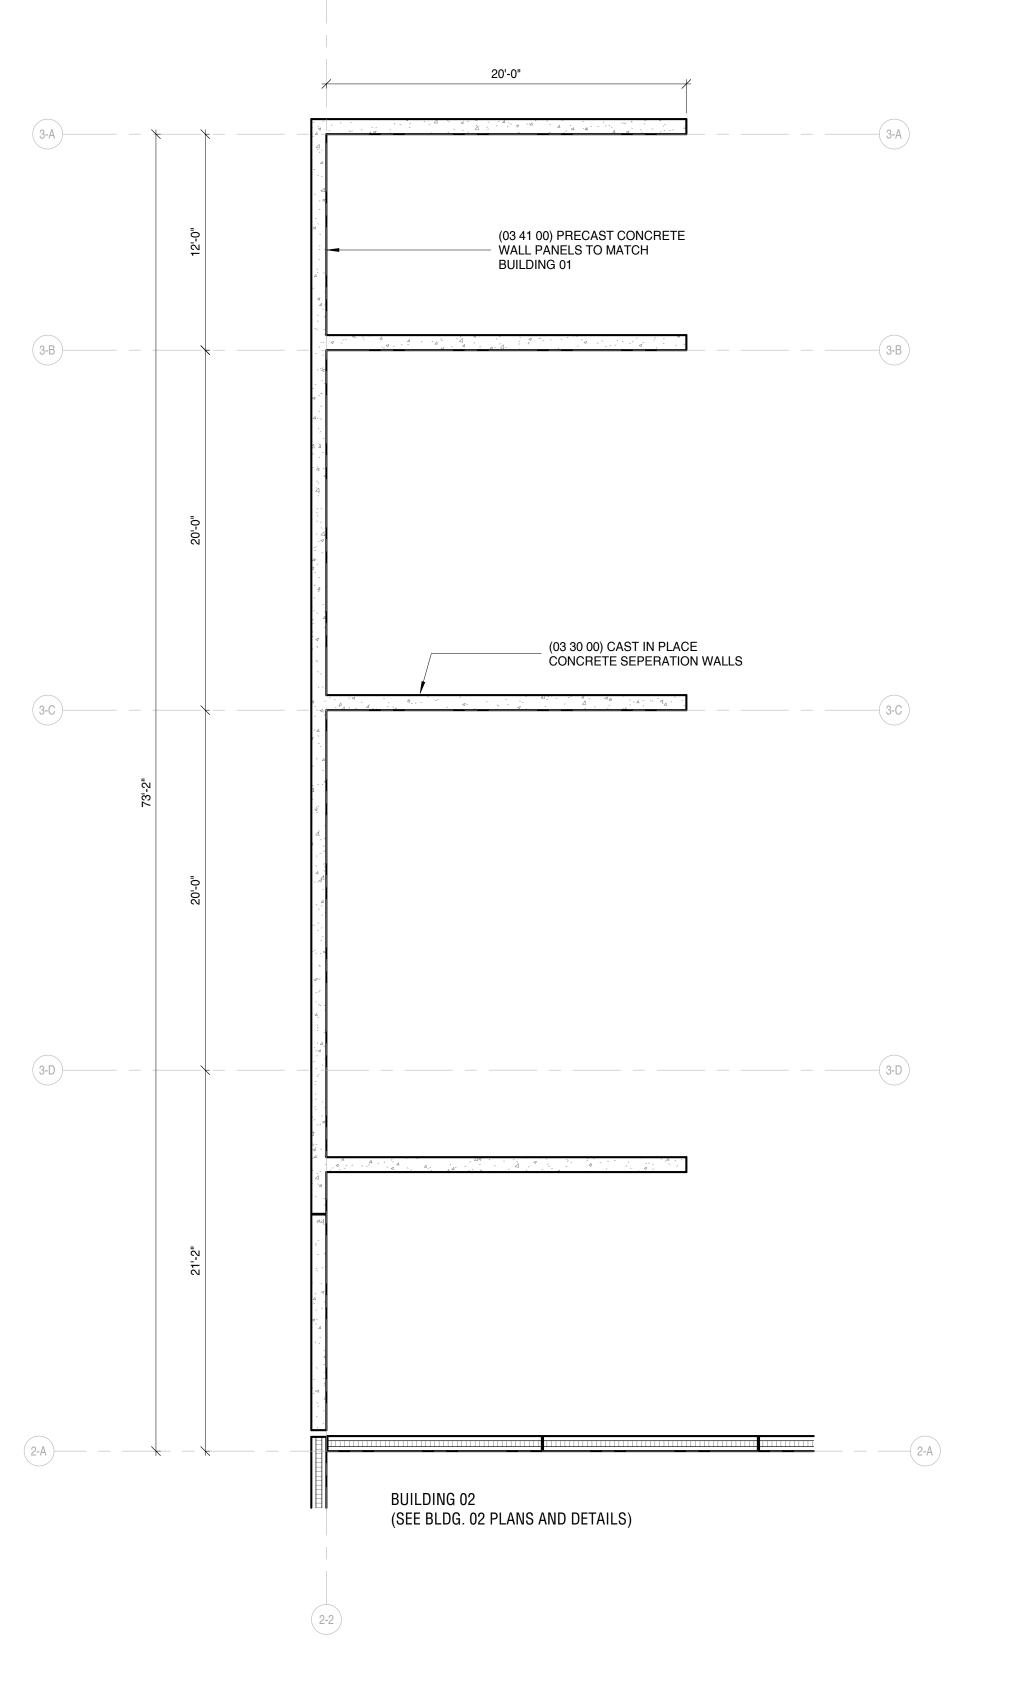

1 03_FIRST FLOOR - OVERALL PLAN - BIN STORAGE

PROJECT

PROJECT:

Public Works Facility

53rd & W Burnham Street West Allis WI, 53219

OWNER:
City of West Allis

PROJECT ISSUE DATE:
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REVISIONS

REV. / DESCRIPTION

KEY PLAN



SHEET

SHEET TITLE:

Floor Plan - Overall Plan - Bin Storage

3A201

Proiect Statu

1 BUILDING 05 - SALT AND BRINE - FLOOR PLAN
3/32" = 1'-0"

PROJECT

PROJECT:

Public Works Facility

53rd & W Burnham Street West Allis WI, 53219

OWNER:

City of West Allis

PROJECT ISSUE DATE: December 29, 2023



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REVISIONS

REV. / DESCRIPT

TION

KEY PLAN




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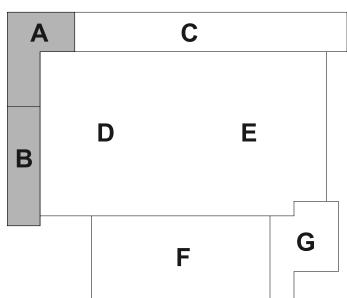
SHEET TITLE:

Floor Plan - Overall Plan - Salt Storage / Brine

5A201

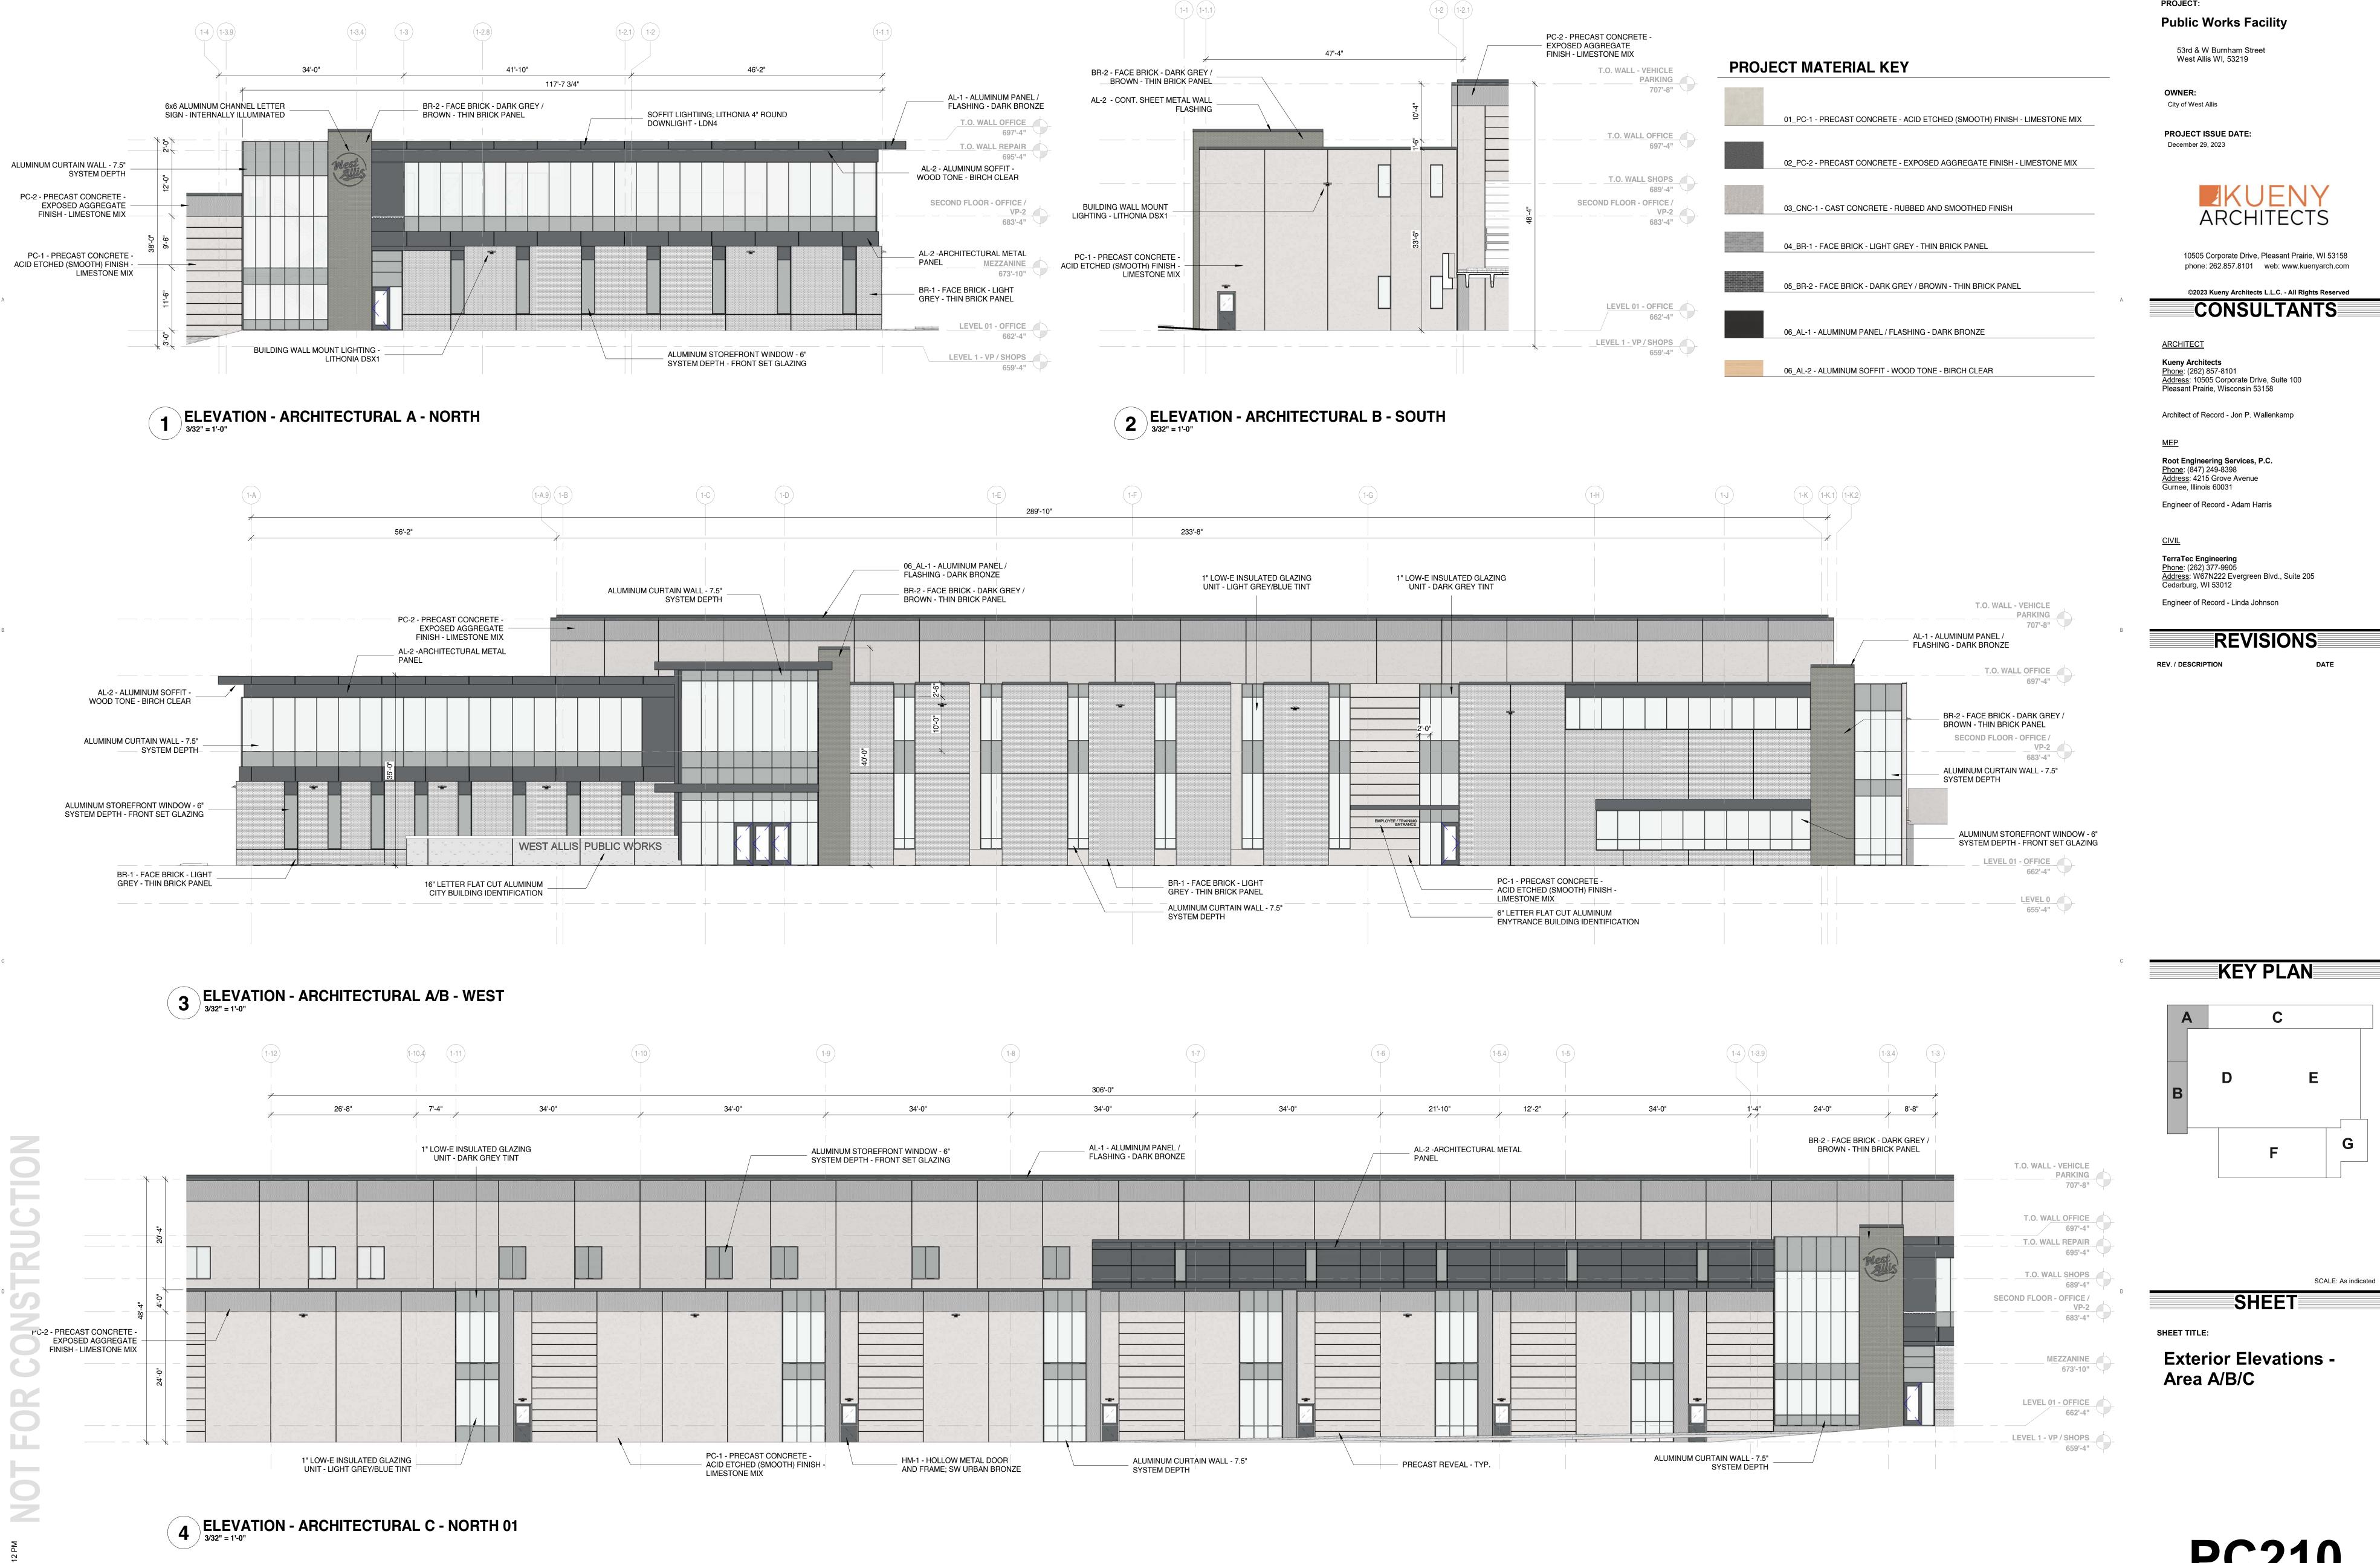

PROJECT:



PC210

(1-K.2) (1-K.1) (1-K)



PARKING 707'-8" PC-2 - PRECAST CONCRETE -ALUMINUM STOREFRONT WINDOW - 6" AL-2 -ARCHITECTURAL METAL EXPOSED AGGREGATE 1" LOW-E INSULATED GLAZING SYSTEM DEPTH - FRONT SET GLAZING FLASHING FINISH - LIMESTONE MIX UNIT - DARK GREY TINT T.O. WALL REPAIR 695'-4" T.O. WALL SHOPS 689'-4" SECOND FLOOR - OFFICE / VP-2 683'-4" 1" LOW-E INSULATED GLAZING UNIT - LIGHT GREY/BLUE TINT MEZZANINE 673'-10" ALUMINUM CURTAIN WALL - 7.5" SYSTEM DEPTH PC-1 - PRECAST CONCRETE -ACID ETCHED (SMOOTH) FINISH -LIMESTONE MIX

3 ELEVATION - ARCHITETCURAL E/G - EAST

1

HM-1 - HOLLOW METAL DOOR AND FRAME; SW URBAN BRONZE

Exterior Elevations -

SHEET TITLE:

LEVEL 1 - VP / SHOPS

659'-4"

Area C/E/G

SCALE: As indicated

PROJECT

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KEY PLAN

Engineer of Record - Linda Johnson

REV. / DESCRIPTION

City of West Allis

PROJECT ISSUE DATE:

December 29, 2023

Public Works Facility

53rd & W Burnham Street West Allis WI, 53219

3 ELEVATION - ARCHITECTURAL D - SOUTH

(1-14) (1-14.1)

30'-2"

4 ELEVATION - ARCHITECTURAL F - WEST

AL-1 - ALUMINUM PANEL / FLASHING - DARK BRONZE

T.O. WALL - VEHICLE

PARKING 707'-8"

64'-0"

33'-10"

PROJECT

PROJECT:

Public Works Facility

53rd & W Burnham Street West Allis WI, 53219

OWNER:

PROJECT ISSUE DATE:

December 29, 2023

City of West Allis

PROJECT MATERIAL KEY

01_PC-1 - PRECAST CONCRETE - ACID ETCHED (SMOOTH) FINISH - LIMESTONE MIX



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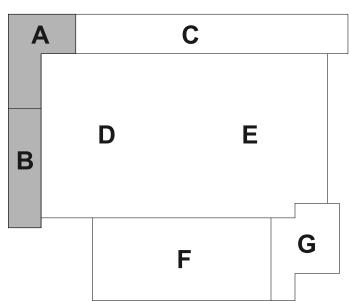
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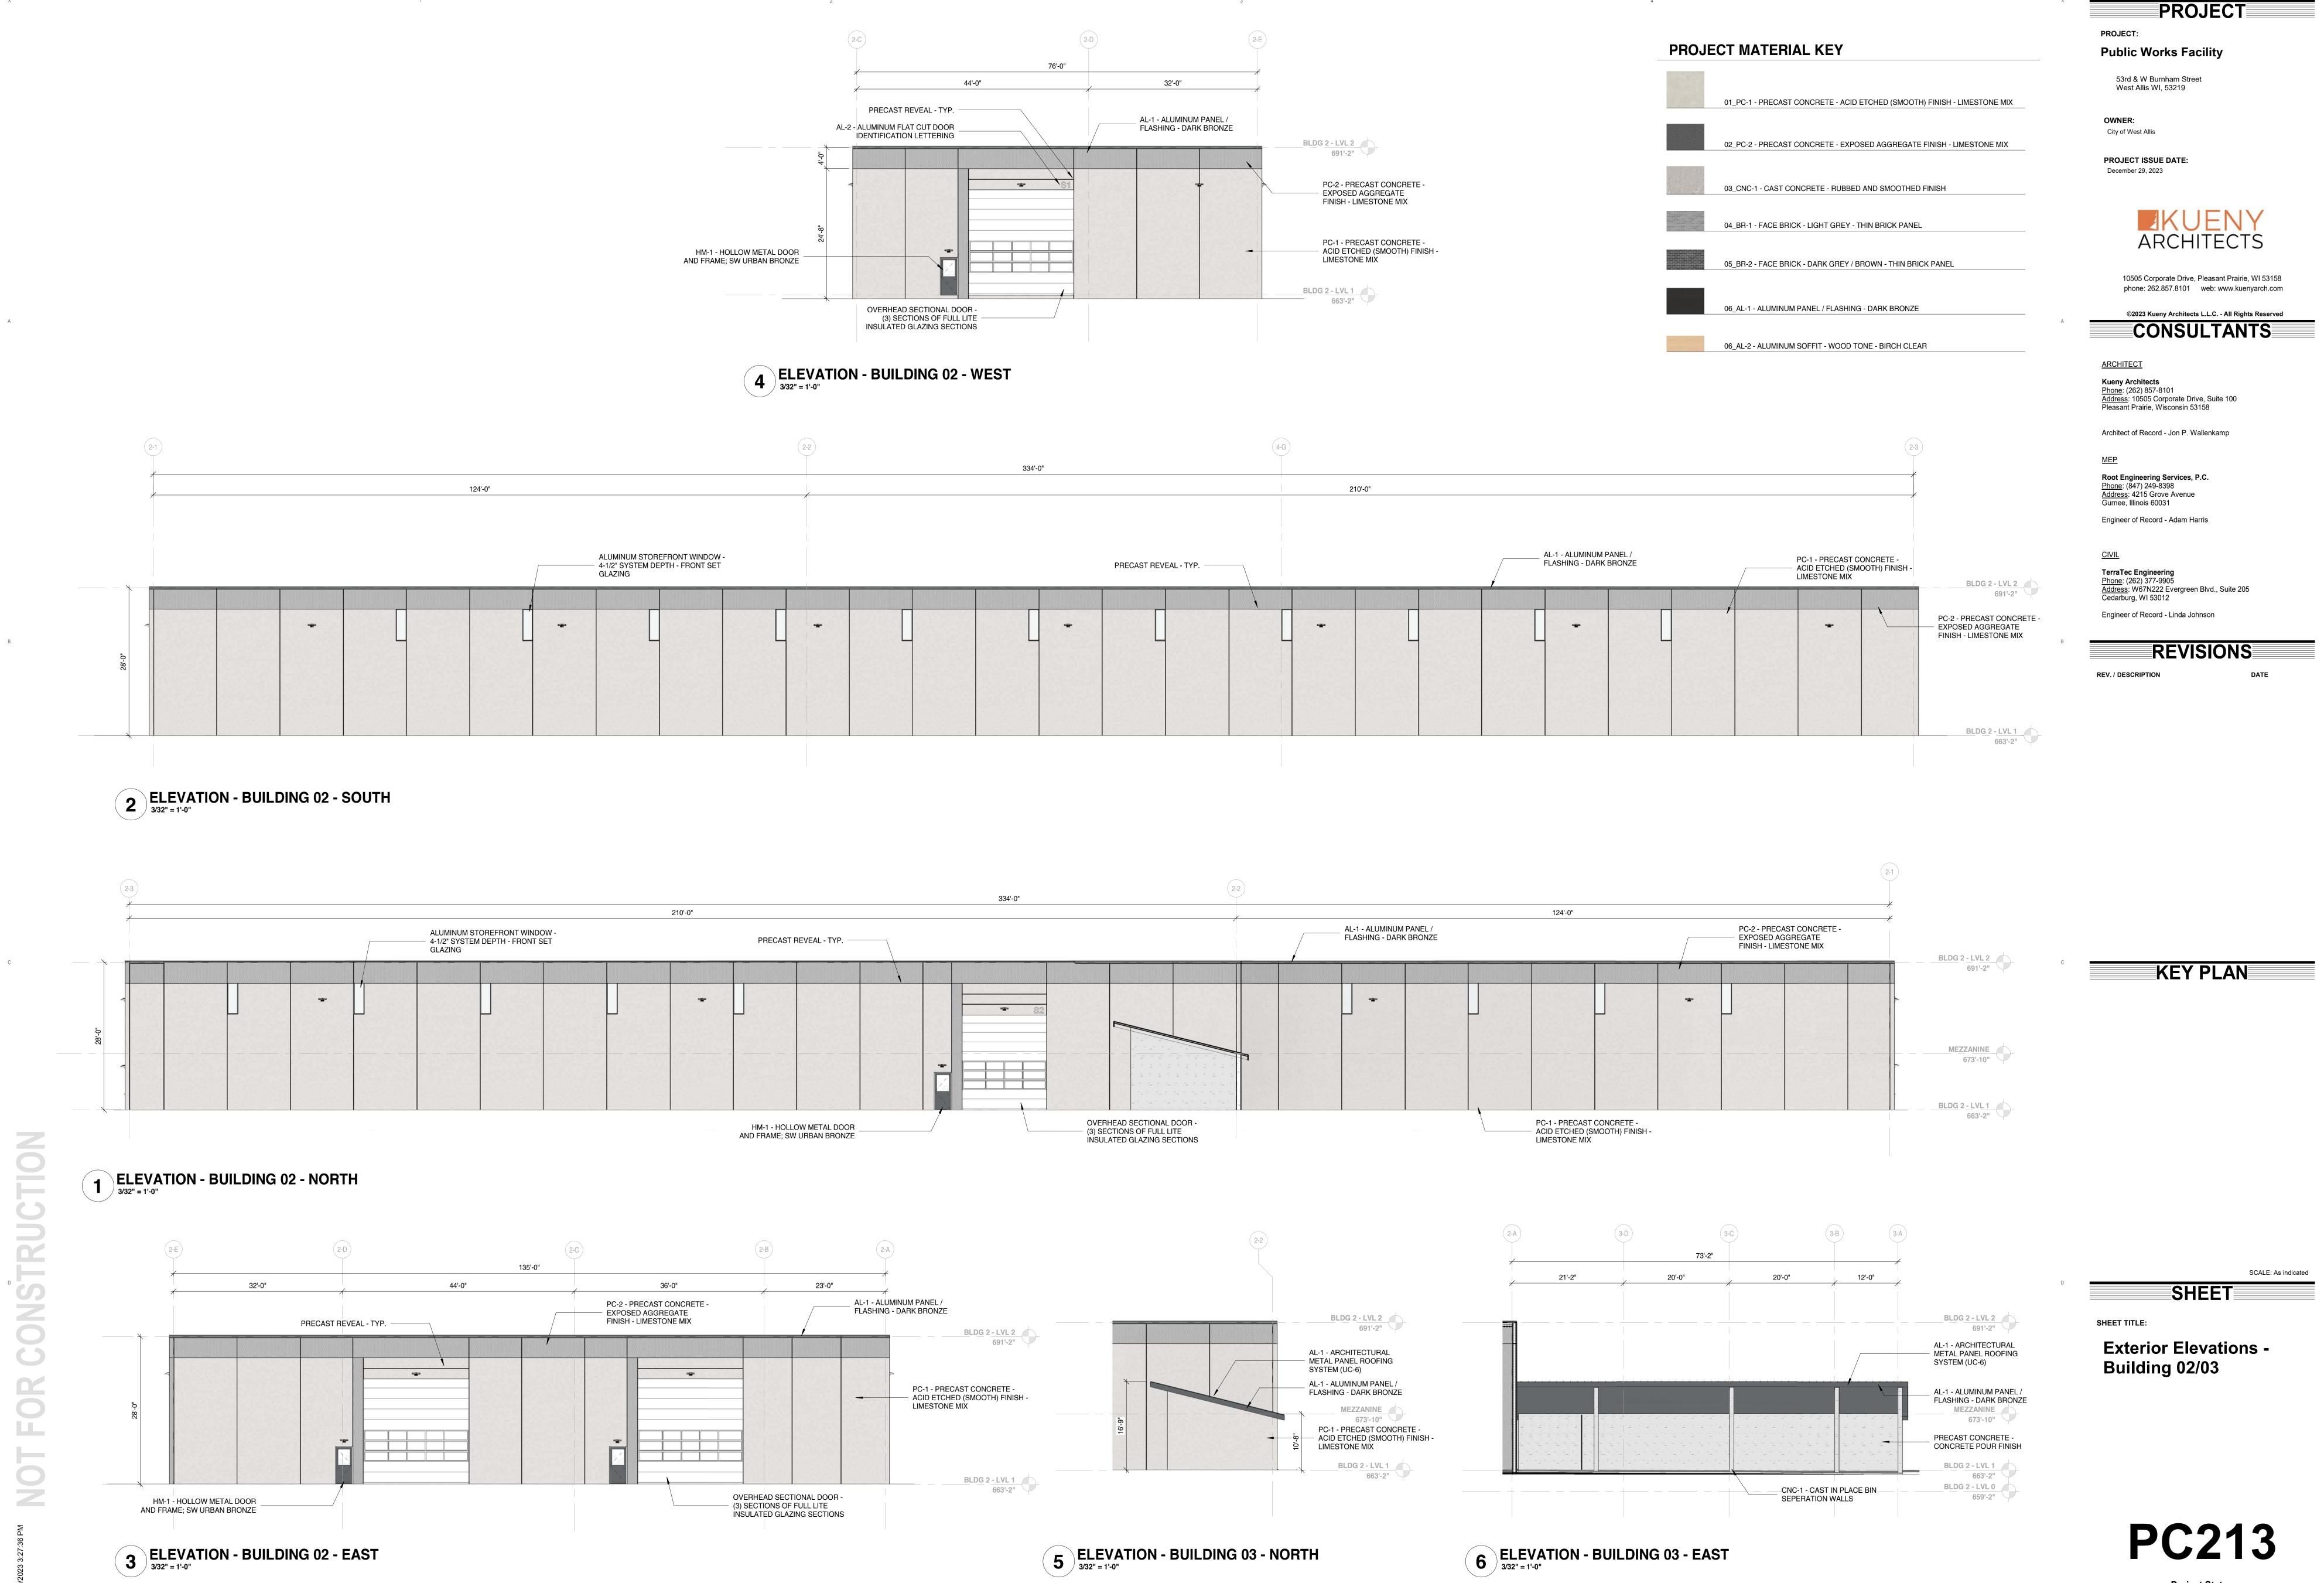
KEY PLAN



SCALE: As indicated

Exterior Elevations -

PC212



3 ELEVATION - BUILDING 02 - EAST

PC213

AL-1 - ALUMINUM PANEL / FLASHING - DARK BRONZE

AL-1 - ARCHITECTURAL METAL WALL PANEL SIDING SYSTEM - 12"

CNC-1 - CONCRETE CAST IN

PLACE SALT BUILDING WALLS

CNC-1 - TYPICAL CONCRETE

HM-1 - HOLLOW METAL DOOR AND FRAME; SW URBAN BRONZE

PANEL HEIGHT

WALL REVEAL

4 ELEVATION - BUILDING 05 - WEST

OVERHEAD SHUTTER DOOR

BRINE - LEVEL 2

675-07

AL-1-ALIMANIM PRE-FINSHED

GUTTER AND COMORPTE CAST IN

FIACE SINE BELLOWING WALLS

3 ELEVATION - BUILDING 05 - EAST

PC214

Exterior Elevations -

SHEET TITLE:

Building 05



CONCEPT RENDERING - NORTHEAST BURNHAM ENTRANCE

PROJECT:

Public Works Facility

53rd & W Burnham Street West Allis WI, 53219

OWNER:

City of West Allis

PROJECT ISSUE DATE:
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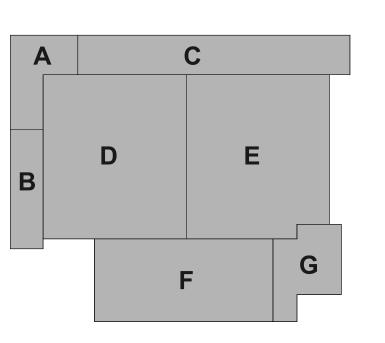
Engineer of Record - Linda Johnson

REVISIONS

REV. / DESCRIPT

SCRIPTION

KEY PLAN



SHEET

SHEET TITLE

Exterior Renderings

R100



CONCEPT RENDERING - 53RD AND BURNHAM ENTRANCE

PROJECT:

Public Works Facility

53rd & W Burnham Street West Allis WI, 53219

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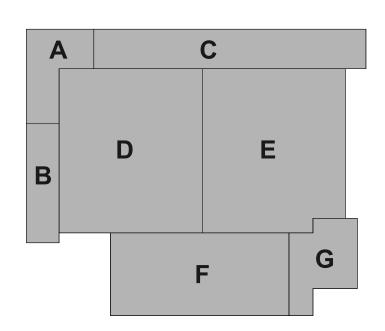
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REVISIONS

REV. / DESCRIPTION

KEY PLAN



SCALE:

SHEET

SHEET TITL

Exterior Renderings

R101

ect Status