

City of West Allis Meeting Agenda Plan Commission

7525 W. Greenfield Ave. West Allis, WI 53214

Wednesday, March 27, 2024

6:00 PM

City Hall, Common Council Chambers 7525 W. Greenfield Ave.

REGULAR MEETING

A. CALL TO ORDER

B. ROLL CALL

C. APPROVAL OF MINUTES

1. 24-0162 February 28, 2024 (draft minutes)

<u>Attachments:</u> February 28, 2024 (draft minutes)

D. NEW AND PREVIOUS MATTERS

2A. 24-0164 Conditional Use Permit for the WAWM Recreation Department, for a

proposed indoor recreation facility, located at 1300 S.109 St.

2B. 24-0165 Site, Landscaping, and Architectural Design Review for the WAWM

Recreation Department, for a proposed indoor recreation facility, located at

1300 S.109 St. (Tax Key No. 445-0715-002)

Attachments: (CUP-SLA) 1300 S 109 St - WAWM Rec

3A. 24-0166 Conditional Use Permit for Tsunami Express Carwash, a proposed Car

Wash with accessory drive-through service, at 10928 W. Oklahoma Ave.

3B. 24-0167 Site, Landscaping, and Architectural Design Review for Tsunami Express

Carwash, a proposed Car Wash with accessory drive-through service, at

10928 W. Oklahoma Ave. (Tax Key No. 520-0151-001)

<u>Attachments:</u> (CUP-SLA) Tsunami Car Wash - 10928 W Oklahoma Ave

4A. 24-0169 Conditional Use Permit for The Salon Suites, a proposed Beauty,

Wellness, and Massage Therapy use located at 11575 W. Theo Trecker

Way.

4B. 24-0170 Site, Landscaping, and Architectural amendment for The Salon Suites, a

proposed Beauty, Wellness, and Massage Therapy use located at 11575

W. Theo Trecker Way. (Tax Key No. 445-0756-001)

Attachments: (CUP-SLA) Salon Suites - 11575 W Theo Trecker Way

5. 24-0171 Sale of an approximate 670-sf portion of land on property located at 62**

W. National Ave. (Tax key Parcel: 454-0073-001)

Attachments: Antigua land sale

6. 24-0172 Ordinance to amend zoning code to prohibit the retail sale of dogs, cats,

and rabbits.

Attachments: (ORD) Dog Cat Rabbits

7. 24-0173 Certified Survey Map to consolidate two lots into one at 55** W. Lincoln

Ave. (Tax Parcel 474-0490-000), and 5520 W Lincoln Ave. (Tax Parcel

474-0491-000)

Attachments: (CSM) 5501 W Lincoln Ave

8. 24-0174 Signage plan appeal for Reunion Restaurant located at 6610 W.

Greenfield Ave. (Tax Key No. 439-0001-032)

Attachments: (SIGN) Reunion - 6610 W Greenfield Ave.

9. 24-0175 Site, Landscaping, and Architectural Design Review for proposed

improvements within City Pedestrian Plaza Right-of-Way Downtown West

Allis in the 1300 block of S. 72 St.

Attachments: (SLA) Ped Plaza - 1300 block of S 72 St.

10. 24-0176 Vacation and discontinuance of an improved alley between W. Lincoln

Ave. and W. Grant St. and within the 2200 block of S. 108 St. and S. 109

St.

Attachments: (VAC) Grant alley - 2200 block of S 108 St & S 109 St

11. 24-0177 Project Tracking updates.

E. ADJOURNMENT



All meetings of the Plan Commission are public meetings. In order for the general public to make comments at the committee meetings, the individual(s) must be scheduled (as an appearance) with the chair of the committee or the appropriate staff contact; otherwise, the meeting of the committee is a working session for the committee itself, and discussion by those in attendance is limited to committee members, the mayor, other alderpersons, staff and others that may be a party to the matter being discussed.

NOTICE OF POSSIBLE QUORUM

It is possible that members of, and possibly a quorum of, members of other governmental bodies of the municipality may be in attendance at the above-stated meeting to gather information. No action will be taken by any governmental body at the above-stated meeting other than the governmental body specifically referred to above in this notice.

NON-DISCRIMINATION STATEMENT

The City of West Allis does not discriminate against individuals on the basis of race, color, religion, age, marital or veterans' status, sex, national origin, disability or any other legally protected status in the admission or access to, or treatment or employment in, its services, programs or activities.

AMERICANS WITH DISABILITIES ACT NOTICE

Upon reasonable notice the City will furnish appropriate auxiliary aids and services when necessary to afford individuals with disabilities an equal opportunity to participate in and to enjoy the benefits of a service, program or activity provided by the City.

LIMITED ENGLISH PROFICIENCY STATEMENT

It is the policy of the City of West Allis to provide language access services to populations of persons with Limited English Proficiency (LEP) who are eligible to be served or likely to be directly affected by our programs. Such services will be focused on providing meaningful access to our programs, services and/or benefits.



City of West Allis Meeting Minutes Plan Commission

7525 W. Greenfield Ave. West Allis, WI 53214

Wednesday, February 28, 2024

6:00 PM

City Hall, Room 128 7525 W. Greenfield Ave.

REGULAR MEETING (draft minutes)

A. CALL TO ORDER

B. ROLL CALL

Present 6 - Wayne Clark, Brian Frank, Dan Devine, Brandon Reinke, Kathleen Dagenhardt,

David Raschka

Excused 3 - Eric Torkelson, Jessica Katzenmeyer, Lisa Coons

Others Attending

Ald. Roadt, Ald. Turner, John Fuchs; Attorney, Mike Wolf,

Staff

Steve Schaer, AICP, Manager of Planning and Zoning

Jack Kovnesky, Planner

C. APPROVAL OF MINUTES

1. <u>24-0106</u> January 24, 2024 (draft minutes)

Attachments: January 24, 2024 (draft minutes)

Raschka moved to approve this matter, Clark seconded, motion carried.

D. NEW AND PREVIOUS MATTERS

2. 24-0107 Site, Landscaping, and Architectural Design Review for an accessory

parking facility, at 9422-30 W. National Ave. submitted by Atty. John Fuchs

of on behalf of Milwaukee Entertainment, LLC (Tax Key No.

479-0674-003).

Attachments: (SLA) 9422 W National Ave PC

Steve Schaer presented.

Frank moved to approve this matter, Dagenhardt seconded, motion carried.

3. 24-0108 Sign appeal for Lucky 7 Daily Food Pantry, an existing Neighborhood

Retail use, located at 9127 W. Lincoln Ave. (Tax Key No. 487-0091-000).

Attachments: (SIGN) 9127 W Lincoln Ave - Lucky 7 Daily Food Pantry

Jack Kovnesky presented.

Clark moved to approve this matter, Frank seconded, motion carried.

4. 24-0109 Certified Survey Map to combine properties located at 8443 W. Cleveland

Ave. & 84** W. Cleveland Ave. (Tax Key Nos. 517-0346-000 &

517-0345-000), by Sam Speaker and Lee Gonzales/KLO Holdings, LLC,

property owners.

Attachments: (CSM) West Allis Food Truck Park

Steve Schaer presented.

Clark moved to approve this matter, subject to technical corrections and

Common Council approval, Frank seconded, motion carried.

5. 24-0110 Ordinance to Adopt the City of West Allis 2045 Comprehensive Plan.

Attachments: (ORD) 2045 Comp Plan

Steve Schaer presented.

Clark moved to approve this matter, Frank seconded, motion carried.

E. ADJOURNMENT

There being no other business, a motion was made by Dagenhardt, seconded by Clark to adjourn at 6:45 p.m.



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STAFF REPORT WEST ALLIS PLAN COMMISSION Wednesday, March 27, 2024 Common Council Chambers 6:00 PM

Watch: https://www.youtube.com/user/westalliscitychannel

- 2A. Conditional Use permit for the WAWM Recreation Department, for a proposed indoor recreation facility, located at 1300 S. 109 St.
- 2B. Site, Landscaping, and Architectural Design Review for the WAWM Recreation Department, for a proposed indoor recreation facility, located at 1300 S. 109 St. (Tax Key No. 445-0715-002).

Overview and Zoning

In September of 2023, Plan Commission recommended Common Council approval of a rezoning (RA-3 to C-3) for the subject property (former Lane intermediate school) owned by the WAWM School District. The Economic Development Committee, of the Common Council, was supportive of the rezoning option to amend the zoning map and advised the school district to take next steps toward developing plans



and encouraged them to consider a taxable future redevelopment option for the future 1.18 north acre portion of the site. Common Council approved the rezoning In October.

Highway 100 Corridor study


The 2018 Highway 100 Corridor Plan established some basic goals of increasing the mix and diversity of uses along Hwy 100, increasing mobility, creating walkable destinations, help establish a brand identity for the corridor, promote desired development patterns. The Common Council rezoned the property in October of 2023 based on compatibility with the Comprehensive plan and Hwy 100 Corridor study. The former low density residential zoning of the property didn't promote the full potential for the subject property (located on State Highway 100).

Conditional use proposal

As part of the proposed scope of work WAWM will demolish the older (south) portion of the existing Lane school buildings to make way for a two phase new building addition (pools & turf training), while renovating the newer (north) portion that includes the gymnasium. A portion of the existing property about (1.18 acres) would likely remain undeveloped and could be split via CSM for future development. Please refer to the attached summary received from the Rec Department. Our City Engineering Department indicated that there is an older storm sewer running under the north end of the existing school building. Future development on top of the storm sewer isn't recommended, and Engineering would like to discuss feasibility of extending W. Madison St. to connect to Hwy 100.

The 4.2-acre property is zoned C-3 Commercial, and the Future Land Use Classification is Civic. Refer to project description, demo plans and phase 1 expansion exhibits as submitted by WAWM Rec Dept (applicant).

The C-3 district allows "indoor recreation" as a conditional use. Indoor recreation is broadly <u>defined</u> in the zoning code as the use of a lot for conducting live sports, activities, or games of skill for the entertainment of participants entirely within a building.

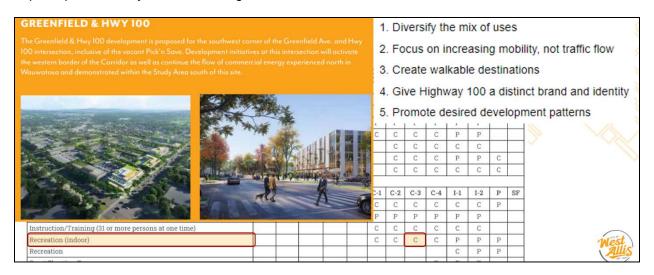



What is a conditional use? Conditional use is a type of use that is allowed upon meeting all conditions specified in the code and those imposed by the common council. Conditional uses are required to go before the City Plan Commission for consideration of proposed operations and a site, landscaping, and architectural design review. Plan Commission's decision is referred to the Common Council for public hearing. The timing of the conditional use process is 45-60 days. For instance, this application was submitted in early March, staff conducted a technical review over a period of three weeks, shared feedback/recommendation with the applicant, and published a staff report w/ recommendation to the Plan Commission on March 27. A public hearing before the City Council to be conducted in April. A class 2 notice is required by State Statures in advance of the public hearing. For more info refer to the Planning and Zoning web.

Site, Landscaping, and Architectural Plans

Proposed building improvements include mass demolition of the south and central portions of the existing building along with brick exterior finish renovations to the remaining two-story north portion of existing building to remain totaling 17,029 square feet. This project is the first phase of the identified master plan for the site, future phases include single-story additions for additional recreation department activities. Exterior materials for the current project will align with existing clay masonry on the building to remain where new exterior surface is required. The current main entrances (gymnasium and visitor doors) will continue to be utilized by program participants and visitors. A new exterior door will be provided as part of renovation for code required exiting at the south-east existing stair. Replacement of existing rooftop mechanical units will be included in the current project. Mechanical screening is not planned to be provided as there is no current screening and existing unit sizes will be maintained. Interior renovation spaces include enlarged and enhanced multi-purpose rooms for a variety of programming – parent/child classes, fitness classes, community meetings, staff training & development, art classes, etc. West Allis-West Milwaukee School District board room space, conference rooms, and support spaces will also be created via renovation on the second floor. Finished renovations are also proposed within the existing building to remain including multipurpose rooms, corridors, toilet rooms, and support spaces.

About 1.80-acres of land area will be disturbed as part of the demo and redevelopment process reducing the amount of impervious area (until such time that the next phase of building addition construction begins). Existing pavement areas within the demolition area will be removed, graded, and grass added to stabilize the site. A city electrical transformer on the south end of the property will be protected during the demo process. Landscaping areas along the existing building foundation/front yard area will be maintained to the extent possible as part of demo. Future addition(s) will prompt a subsequent site, landscaping, and architectural review before Plan Commission.

Construction is scheduled to begin in May 2024 and to be completed in January 2025. The existing building will continue to be occupied and select summer 2024 programming will continue on-site with potential disruptions depending on the specific construction activities on any particular day. Estimated construction/project cost as of February 2024 is \$4,620,000.

Staff Comments

Engineering – Discuss future 1 acre of developable land area on north end of site and consider possible extension of W. Madison St. Right-of-Way (RoW) to Hwy 100. Existing Stormwater within easement area to be protected/maintained. May require improvements in advance of future development. Should not be built upon.

Code Enforcement – Demolition and soil erosion permits required.

Health – Vermin abatement requirement and documentation of contracted abatement.

Planning – Landscaping plan, schedule of expected next phase. What is the school districts plan for the remainder of the property post phase 2? Do expected Rec operations include any large tournaments? Describe typical day/occupancy and staffing.



Recommendation: Common Council approval of the Conditional Use Permit and Site, Landscaping, and Architectural Design Review for the WAWM Recreation Department, for a proposed indoor recreation facility, located at 1300 S. 109 St. (Tax Key No. 445-0715-002) subject to the following conditions:

- 1. A revised Site and Architectural Plan being submitted to the Department of Development to show the following: (a) Landscaping plan being submitted to show post-demolition landscaping details and removing asphalt paving within terrace areas along S. 109 St. to be replaced with grass confirm on plans; (b) refuse location and 4-sided screening being shown on site plan; (c) two stairwell window openings being shown on the south elevation of the remaining building; (d) construction schedule for phase two, utility easement (aligned with W. Madison St.) being maintained and coordination with City Engineer relative to discussion on future phase of construction and extension of W. Madison St. Contact Steve Schaer, Manager of Planning and Zoning at 414-302-8466.
- 2. A <u>Street excavation permit</u> being applied for in OpenGov prior to work beginning. Any concrete work in the street right of way needs to be completed by a licensed and pre-qualified contractor within the City of West Allis. Contact Greg Bartelme at (414) 302-8367.
- 3. Vermin abatement documentation being submitted prior to demolition.
- 4. Documentation and approval showing compliance with the City of West Allis Storm water Management Ordinance, to be submitted to the Building Inspections and Neighborhood Services Department by a registered Civil Engineer. A storm water permit must be obtained from the City.

DESIGN REVIEW - PROJECT DESCRIPTION

March 8, 2024

WAWM School District – Lane Project Phase 01 1300 South 109th Street West Allis, Wisconsin GDG Project #23.019





Description of Building Improvements:

Proposed building improvements include mass demolition of the south and central portions of the existing building along with finish/interior renovations to the remaining two-story north portion of existing building to remain totaling 17,029 square feet. This project is the first phase of the identified master plan for the site, future phases include single-story additions for additional recreation department activities. Exterior materials for the current project will align with existing clay masonry on the building to remain where new exterior surface is required. The current main entrances (gymnasium and visitor doors) will continue to be utilized by program participants and visitors. A new exterior door will be provided as part of renovation for code required exiting at the south-east existing stair. Replacement of existing rooftop mechanical units will be included in the current project. Mechanical screening is not planned to be provided as there is no current screening and existing unit sizes will be maintained. Interior renovation spaces include enlarged and enhanced multi-purpose rooms for a variety of programming - parent/child classes, fitness classes, community meetings, staff training & development, art classes, etc. West Allis-West Milwaukee School District board room space, conference rooms, and support spaces will also be created via renovation on the second floor. Finish renovations are also proposed within the existing building to remain including multipurpose rooms, corridors, toilet rooms, and support spaces.

Timeline When Work Will be Completed:

Construction activities will be coordinated by Construction Manager/General Contractor, CG Schmidt. Construction is scheduled to begin in May 2024 and to be completed in January 2025. The existing building will continue to be occupied and select summer 2024 programming will continue on-site with potential disruptions depending on the specific construction activities on any particular day. Estimated construction/project cost as of February 2024 is \$4,620,000.

Description of Operations/Services:

The Recreation and Community Services Center offers programs and services that support and enhance physical, mental, emotional, and social health for community members. The department offers programs and services for all ages and abilities. The Lane facility is the newest location for the Rec Dept and will offer comparable and additional programming to that of the current Recreation Center. The Lane Recreation center will be open to all of West Allis and West Milwaukee but will serve as a more convenient location to those on the west side of West Allis. The flexibility of the spaces provided allow for the department to offer a variety of programs and partner with other community organizations and agencies to have a greater reach.

Days and Hours of Operations:


No change to current days or hours of operation (listed below for reference).

Monday - Friday = 7:00am-9:00pm

Saturday – Sunday = 8:00am-4:00pm (addition hours as needed for special events, rentals, etc)

600 W. Virginia Street | Suite 602 | Milwaukee, WI 53204 414.810.7613 www.gdg-architects.com



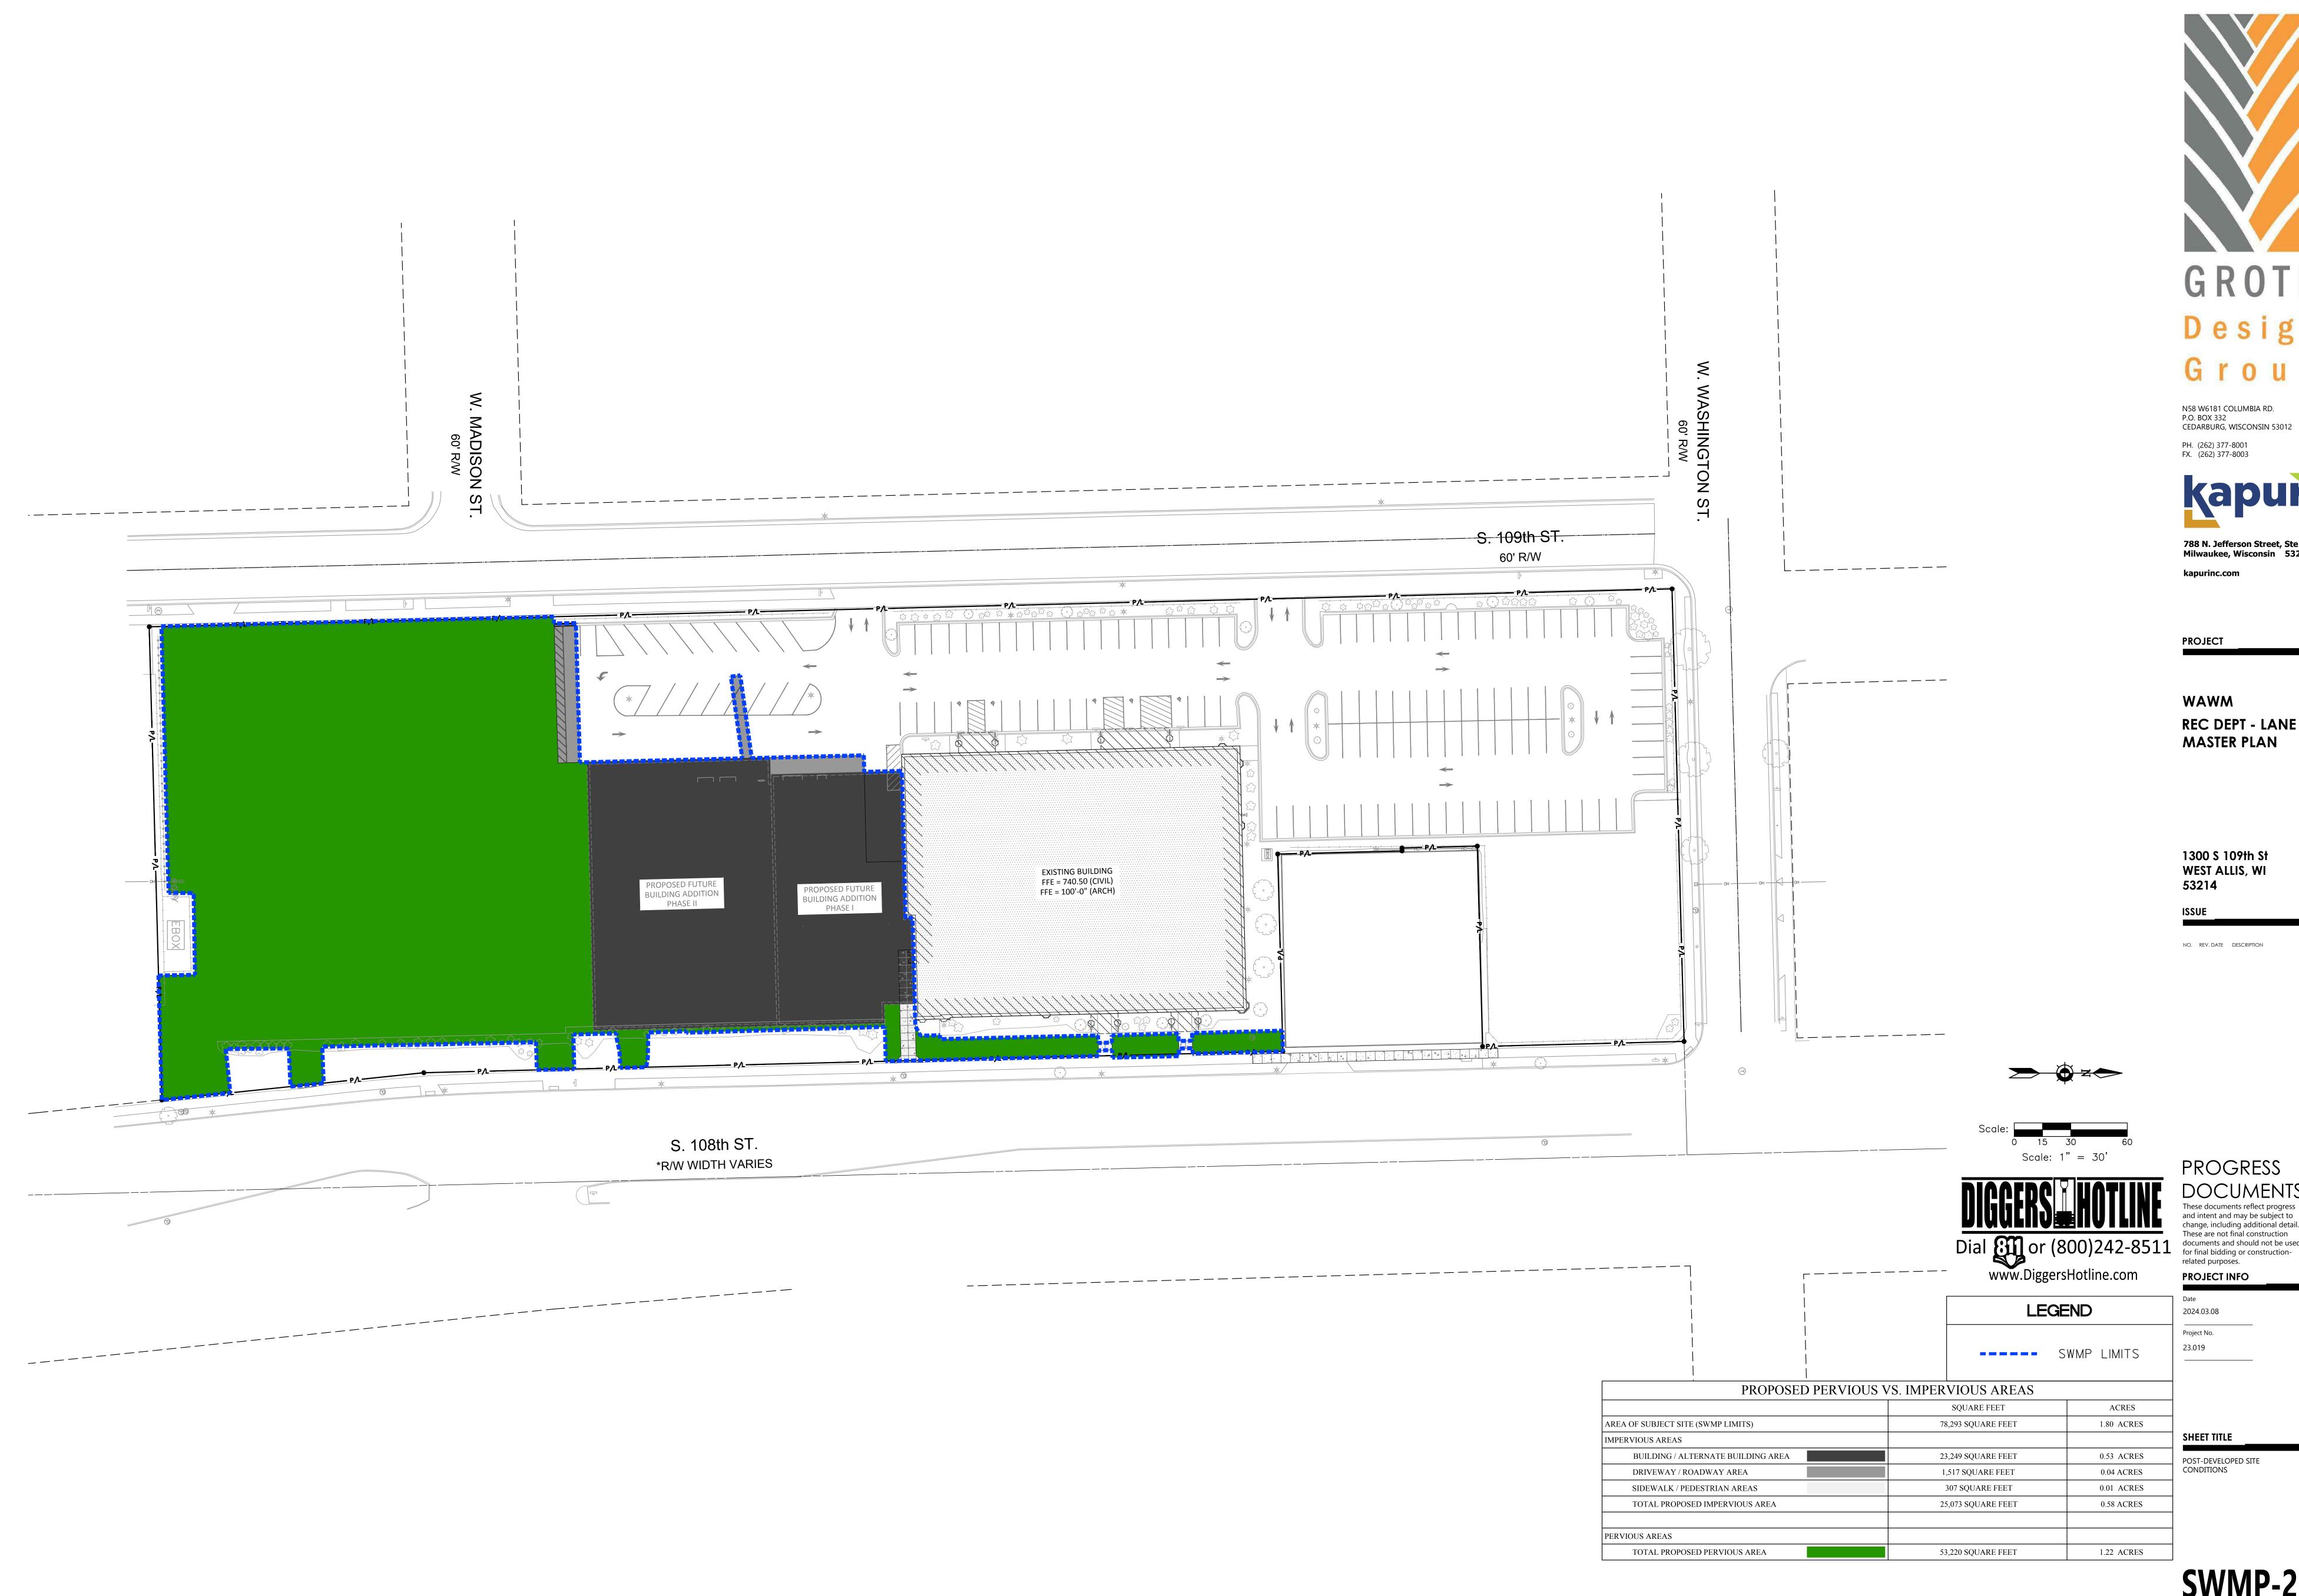



N58 W6181 COLUMBIA RD. P.O. BOX 332 CEDARBURG, WISCONSIN 53012 PH. (262) 377-8001 FX. (262) 377-8003



788 N. Jefferson Street, Ste 900 Milwaukee, Wisconsin 53202 kapurinc.com

WAWM REC DEPT - LANE MASTER PLAN

1300 S 109th St WEST ALLIS, WI 53214

NO. REV. DATE DESCRIPTION

PROGRESS

These documents reflect progress and intent and may be subject to change, including additional detail.

These are not final construction

related purposes.

documents and should not be used

PROJECT INFO 2024.03.08 Project No. 23.019

SHEET TITLE

POST-DEVELOPED SITE CONDITIONS


INDEX OF DRAWINGS

"X" INDICATES ISSUED FOR REVIEW/CONSTRUCTION

75% PROGRESS	CITY PLAN COMMISSION	CONSTRUCTION DOCUMENTS	TBD	ТВО	TBD	ВД	TBD	ВД	TBD	No	Sheet Name
X	X	Ŭ	F	<u> </u>	F	F	F	F	F	No. G001	TITLE SHEET, SHEET INDEX, LOCATION MAP
Χ										G002	GENERAL INFORMATION
X										G101 G102	CODE INFORMATION - LEVEL 1 CODE INFORMATION - LEVEL 2
X	X									C001	LAND SURVEY
	X									C101 C102	SITE DEMOLITION PLAN SITE LAYOUT PLAN
	X									C103	SITE GRADING & EROSION CONTROL PLAN
										C104	SITE UTILITY PLAN
										C105	SITE LANDSCAPE PLAN
										C201 C202	SITE DETAILS SITE DETAILS
										,	
X										A001	WALL TYPES
Χ										A002	GENERAL ARCH DETAILS
Χ	Х									AD101	DEMOLITION PLAN - LEVEL 1
X	Х									AD102	DEMOLITION PLAN - LEVEL 2
X										AD103 AD104	DEMOLITION REFLECTED CEILING PLAN - LEVEL 1 DEMOLITION REFLECTED CEILING PLAN - LEVEL 2
٨										AD 104	DEMOLITION REFLECTED CEILING PLAN - LEVEL 2
Χ	Х									A101	FLOOR PLAN - LEVEL 1
X	X									A102	FLOOR PLAN - LEVEL 2
X	X									A103 A111	ROOF PLAN REFLECTED CEILING PLAN - LEVEL 1
Х										A112	REFLECTED CEILING PLAN -LEVEL 2
Χ										A120	FINISH SCHEDULE
X										A121	FINISH FLOOR PLAN - LEVEL 1
X X	X									A122 A201	FINISH FLOOR PLAN - LEVEL 2 BUILDING ELEVATIONS
Χ										A311	WALL SECTIONS
										A411	ENLARGED PLANS, INTERIOR ELEVATIONS - LEVEL
										A450 A550	ENLARGED TOILET PLANS, INTERIOR ELEVATIONS GENERAL INTERIOR DETAILS
Χ										A600	DOOR SCHEDULE & TYPES
										J	
X										H001	SCHEDULES
X										HD101 HD102	LEVEL 0 & 1 - DEMOLITION PLANS LEVEL 2 & ROOF - DEMOLITION PLANS
										, 	
X										H101	LEVEL 1 - DUCTWORK PLAN
X X										H102 H103	LEVEL 2 - DUCTWORK PLAN ROOF PLAN
										H111	LEVEL 1 - PIPING PLAN
										H112	LEVEL 2 - PIPING PLAN
										H121	LEVEL 1 - PLENUM PLAN
										H122 H141	LEVEL 2 - PLENUM PLAN MECHANICAL / BOILER ROOM PLANS
										H201	DETAILS
										1	
										P101	PLUMBING PLAN - LEVEL 1 PLUMBING PLAN - LEVEL 2
										P102	FLUIVIDIINU FLAIN - LEVEL Z
										F101	FIRE PROTECTION PLAN - LEVEL 1
										F102	FIRE PROTECTION PLAN - LEVEL 2
Х										E001	ELECTRICAL SYMBOLS AND ABBREVIATIONS
X										ED101	ELECTRICAL DEMOLITION PLAN
Χ										ED102	ELECTRICAL DEMOLITION PLAN
v										E101	LIGHTING ELOOP DLAN - LEVEL 1
X										E101 E102	LIGHTING FLOOR PLAN - LEVEL 1 LIGHTING FLOOR PLAN - LEVEL 2
Х										E111	POWER FLOOR PLAN - LEVEL 1
Χ										E112	POWER FLOOR PLAN - LEVEL 2
X										E121 E201	FIRE ALARM & SECURITY FLOOR PLAN ONE-LINE DRAWING AND SCHEDULES
X										F301	FLECTRICAL SCHEDULES AND DETAILS

ELECTRICAL SCHEDULES AND DETAILS



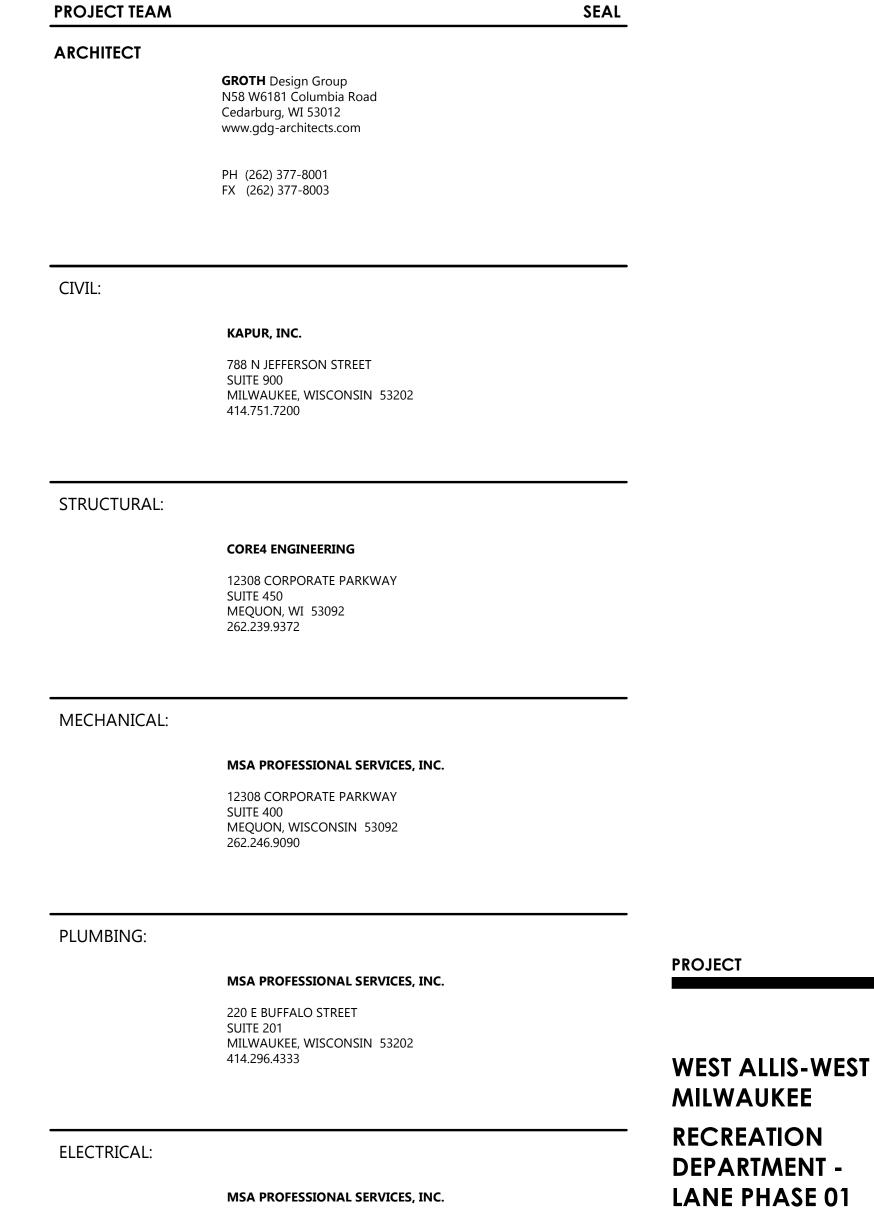

116 FREMONT STREET KIEL, WISCONSIN 53042

> 1300 S 109th St West Allis, WI

WEST ALLIS-WEST MILWAUKEE

RECREATION DEPARTMENT - LANE PHASE 01

1300 S 109th St West Allis, WI 53214

LOCATION MAP

PROJECT INFO

Date

2024-03-08


Project No.

23.019

SHEET TITLE

TITLE SHEET, SHEET INDEX, LOCATION MAP

G001

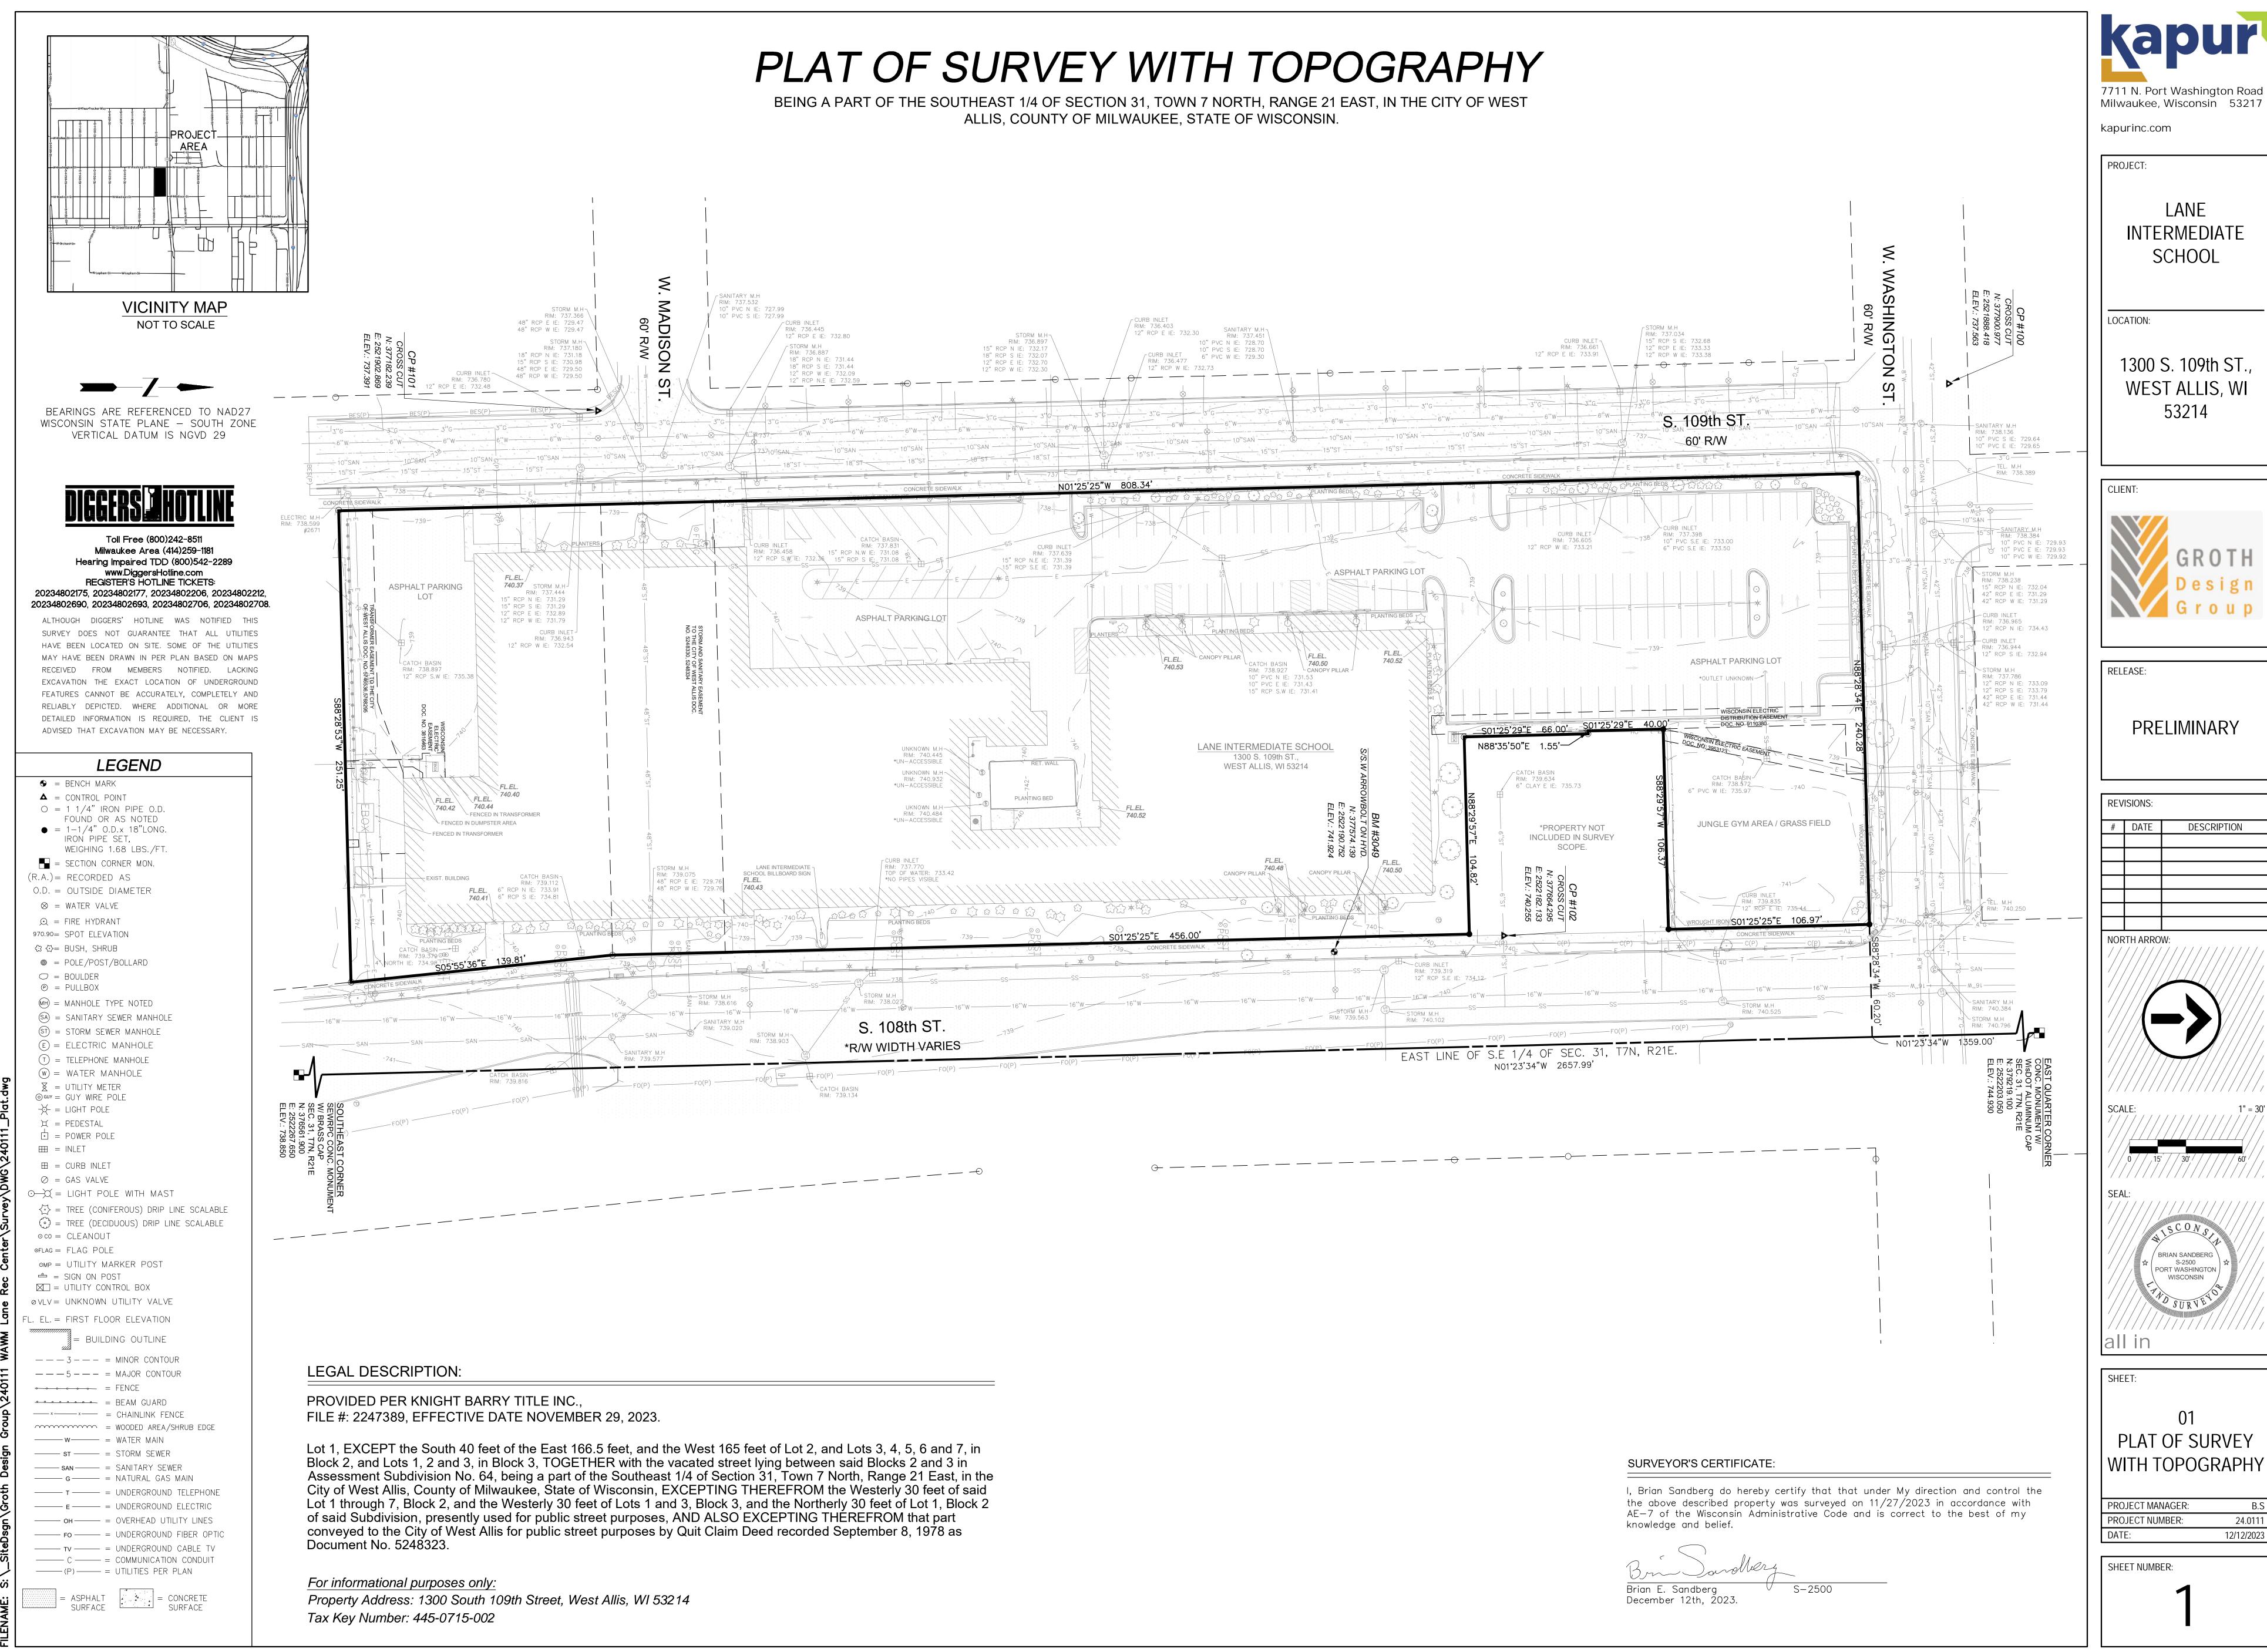

7711 N. Port Washington Road

kapurinc.com

PROJECT:

INTERMEDIATE **SCHOOL**


1300 S. 109th ST. WEST ALLIS, WI 53214



PRELIMINARY

REVISIONS:									
#	DATE	DESCRIPTION							

NORTH ARROW:

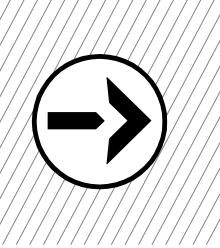


BRIAN SANDBERG PORT WASHINGTON WISCONSIN

PLAT OF SURVEY

PROJECT MANAGER: PROJECT NUMBER: 12/12/2023

SHEET NUMBER:

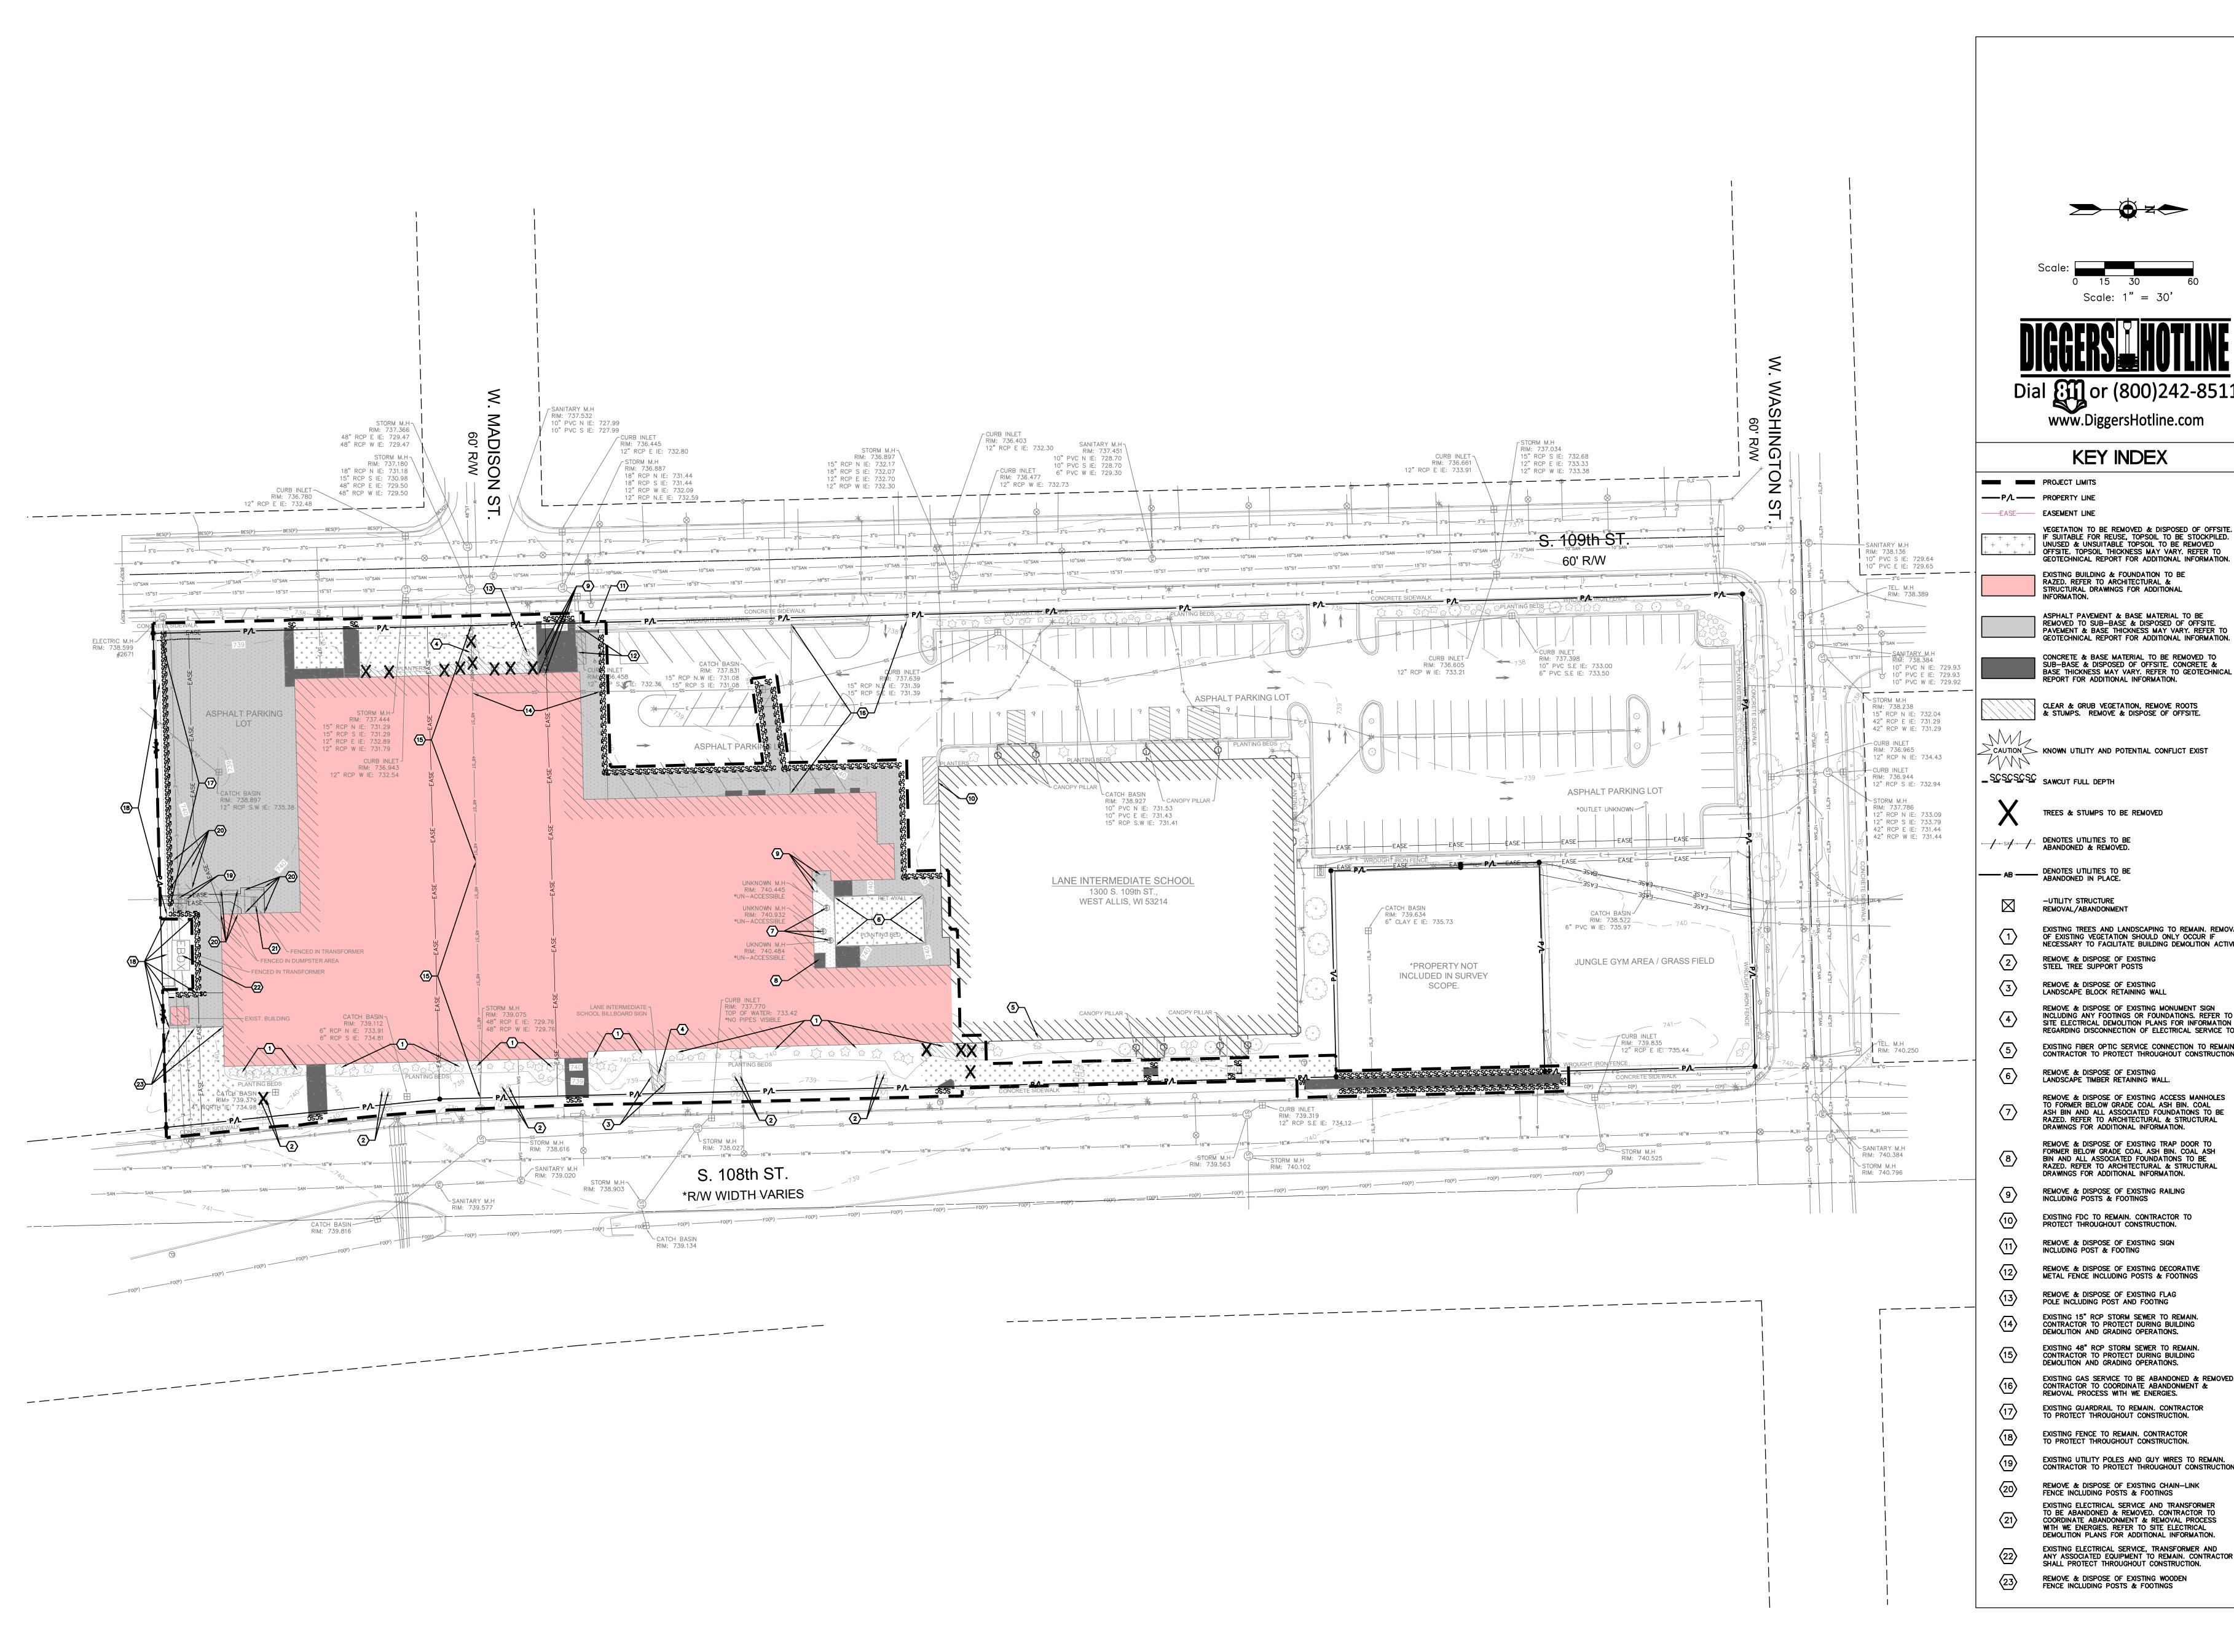



www.DiggersHotline.com

KEY INDEX

VEGETATION TO BE REMOVED & DISPOSED OF OFFSITE.

IF SUITABLE FOR REUSE, TOPSOIL TO BE STOCKPILED.

UNUSED & UNSUITABLE TOPSOIL TO BE REMOVED

OFFSITE. TOPSOIL THICKNESS MAY VARY. REFER TO

GEOTECHNICAL REPORT FOR ADDITIONAL INFORMATION.

ASPHALT PAVEMENT & BASE MATERIAL TO BE REMOVED TO SUB-BASE & DISPOSED OF OFFSITE. PAVEMENT & BASE THICKNESS MAY VARY. REFER TO GEOTECHNICAL REPORT FOR ADDITIONAL INFORMATION.

CLEAR & GRUB VEGETATION, REMOVE ROOTS & STUMPS. REMOVE & DISPOSE OF OFFSITE.

ECAUTION KNOWN UTILITY AND POTENTIAL CONFLICT EXIST

TREES & STUMPS TO BE REMOVED

-UTILITY STRUCTURE REMOVAL/ABANDONMENT

EXISTING TREES AND LANDSCAPING TO REMAIN. REMOVAL OF EXISTING VEGETATION SHOULD ONLY OCCUR IF NECESSARY TO FACILITATE BUILDING DEMOLITION ACTIVITIES.

LANDSCAPE BLOCK RETAINING WALL REMOVE & DISPOSE OF EXISTING MONUMENT SIGN INCLUDING ANY FOOTINGS OR FOUNDATIONS. REFER TO SITE ELECTRICAL DEMOLITION PLANS FOR INFORMATION

REGARDING DISCONNECTION OF ELECTRICAL SERVICE TO SIGN. EXISTING FIBER OPTIC SERVICE CONNECTION TO REMAIN. CONTRACTOR TO PROTECT THROUGHOUT CONSTRUCTION.

REMOVE & DISPOSE OF EXISTING LANDSCAPE TIMBER RETAINING WALL.

REMOVE & DISPOSE OF EXISTING ACCESS MANHOLES TO FORMER BELOW GRADE COAL ASH BIN. COAL ASH BIN AND ALL ASSOCIATED FOUNDATIONS TO BE RAZED. REFER TO ARCHITECTURAL & STRUCTURAL DRAWINGS FOR ADDITIONAL INFORMATION.

REMOVE & DISPOSE OF EXISTING TRAP DOOR TO FORMER BELOW GRADE COAL ASH BIN. COAL ASH BIN AND ALL ASSOCIATED FOUNDATIONS TO BE RAZED. REFER TO ARCHITECTURAL & STRUCTURAL DRAWINGS FOR ADDITIONAL INFORMATION.

INCLUDING POSTS & FOOTINGS

EXISTING FDC TO REMAIN. CONTRACTOR TO PROTECT THROUGHOUT CONSTRUCTION.

REMOVE & DISPOSE OF EXISTING DECORATIVE METAL FENCE INCLUDING POSTS & FOOTINGS

REMOVE & DISPOSE OF EXISTING FLAG POLE INCLUDING POST AND FOOTING EXISTING 15" RCP STORM SEWER TO REMAIN. CONTRACTOR TO PROTECT DURING BUILDING

EXISTING 48" RCP STORM SEWER TO REMAIN. CONTRACTOR TO PROTECT DURING BUILDING DEMOLITION AND GRADING OPERATIONS.

EXISTING GAS SERVICE TO BE ABANDONED & REMOVED. CONTRACTOR TO COORDINATE ABANDONMENT & REMOVAL PROCESS WITH WE ENERGIES.

EXISTING GUARDRAIL TO REMAIN. CONTRACTOR

EXISTING FENCE TO REMAIN. CONTRACTOR TO PROTECT THROUGHOUT CONSTRUCTION.

EXISTING UTILITY POLES AND GUY WIRES TO REMAIN. CONTRACTOR TO PROTECT THROUGHOUT CONSTRUCTION.

REMOVE & DISPOSE OF EXISTING CHAIN-LINK FENCE INCLUDING POSTS & FOOTINGS

EXISTING ELECTRICAL SERVICE AND TRANSFORMER TO BE ABANDONED & REMOVED. CONTRACTOR TO COORDINATE ABANDONMENT & REMOVAL PROCESS WITH WE ENERGIES. REFER TO SITE ELECTRICAL DEMOLITION PLANS FOR ADDITIONAL INFORMATION.

EXISTING ELECTRICAL SERVICE, TRANSFORMER AND ANY ASSOCIATED EQUIPMENT TO REMAIN. CONTRACTOR SHALL PROTECT THROUGHOUT CONSTRUCTION.

> REMOVE & DISPOSE OF EXISTING WOODEN FENCE INCLUDING POSTS & FOOTINGS

Design N58 W6181 COLUMBIA RD. P.O. BOX 332 CEDARBURG, WISCONSIN 53012

FX. (262) 377-8003

788 N. Jefferson Street, Ste 900 Milwaukee, Wisconsin 53202 kapurinc.com

PROJECT

PH. (262) 377-8001

WAWM REC DEPT - LANE MASTER PLAN

1300 S 109th St WEST ALLIS, WI 53214

ISSUE

NO. REV. DATE DESCRIPTION

PROGRESS These documents reflect progress

and intent and may be subject to change, including additional detail. These are not final construction documents and should not be used for final bidding or constructionrelated purposes. PROJECT INFO


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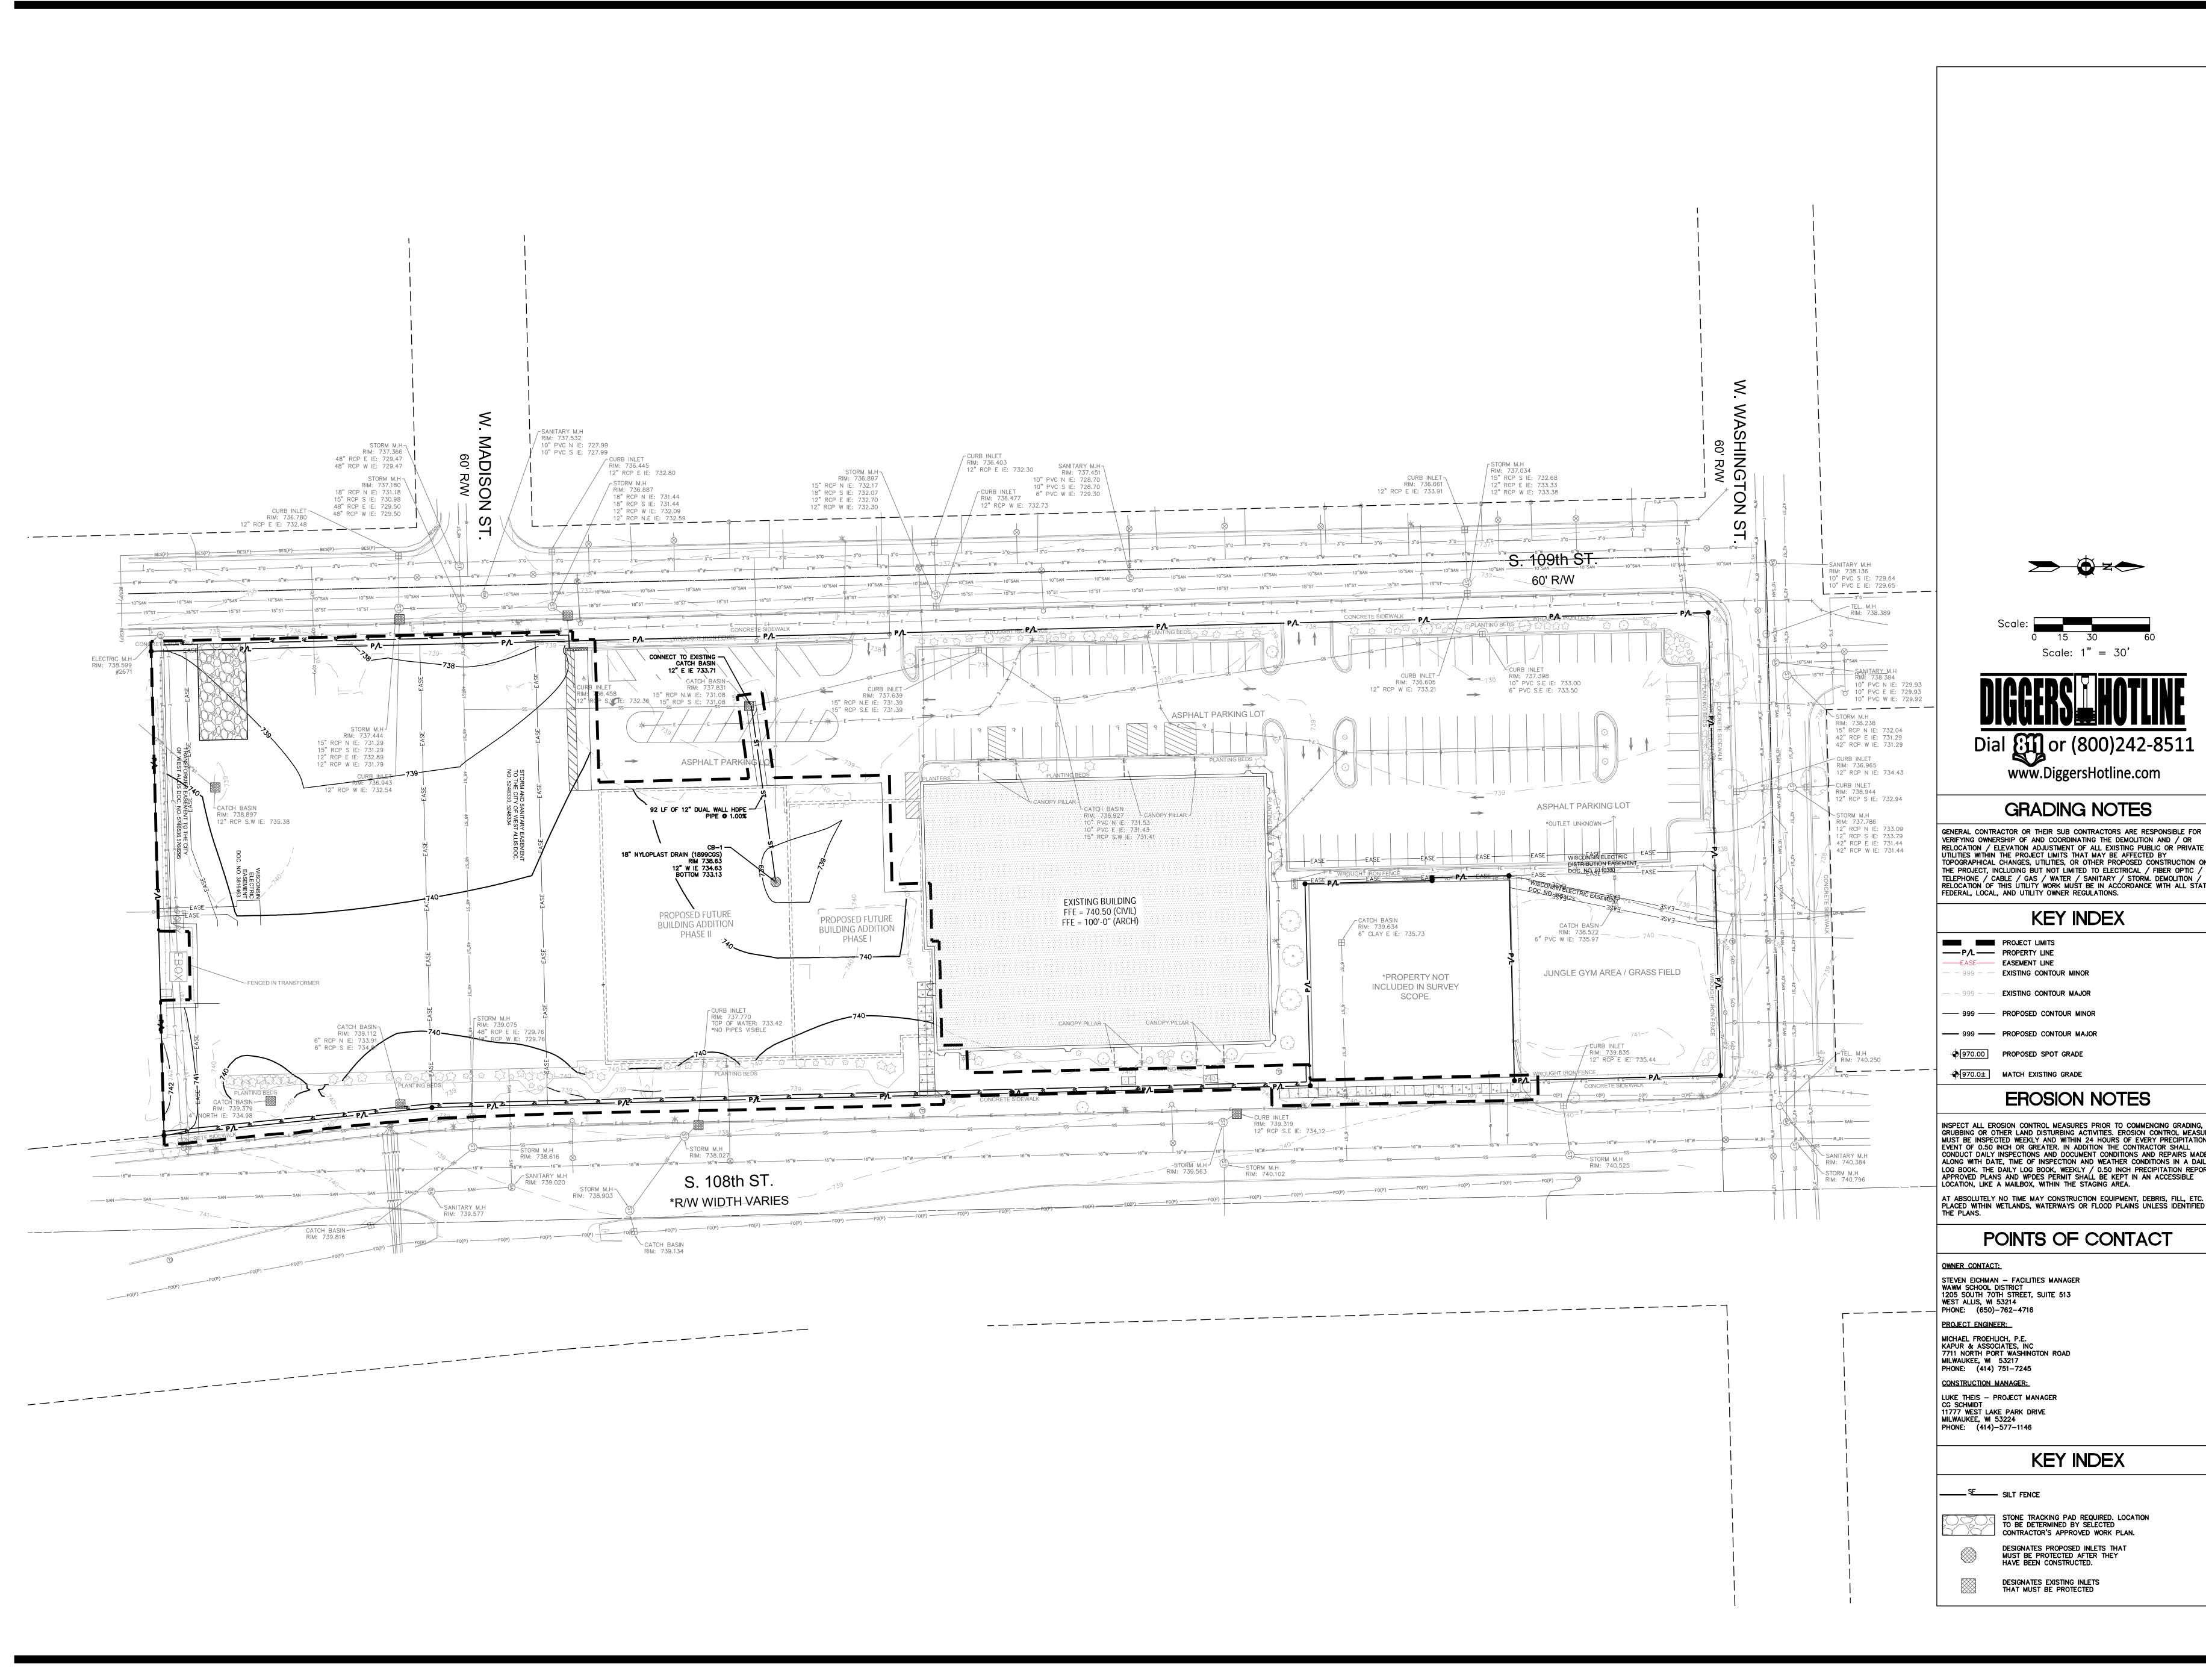
Project No.

23.019

SHEET TITLE SITE DEMOLITION

PLAN



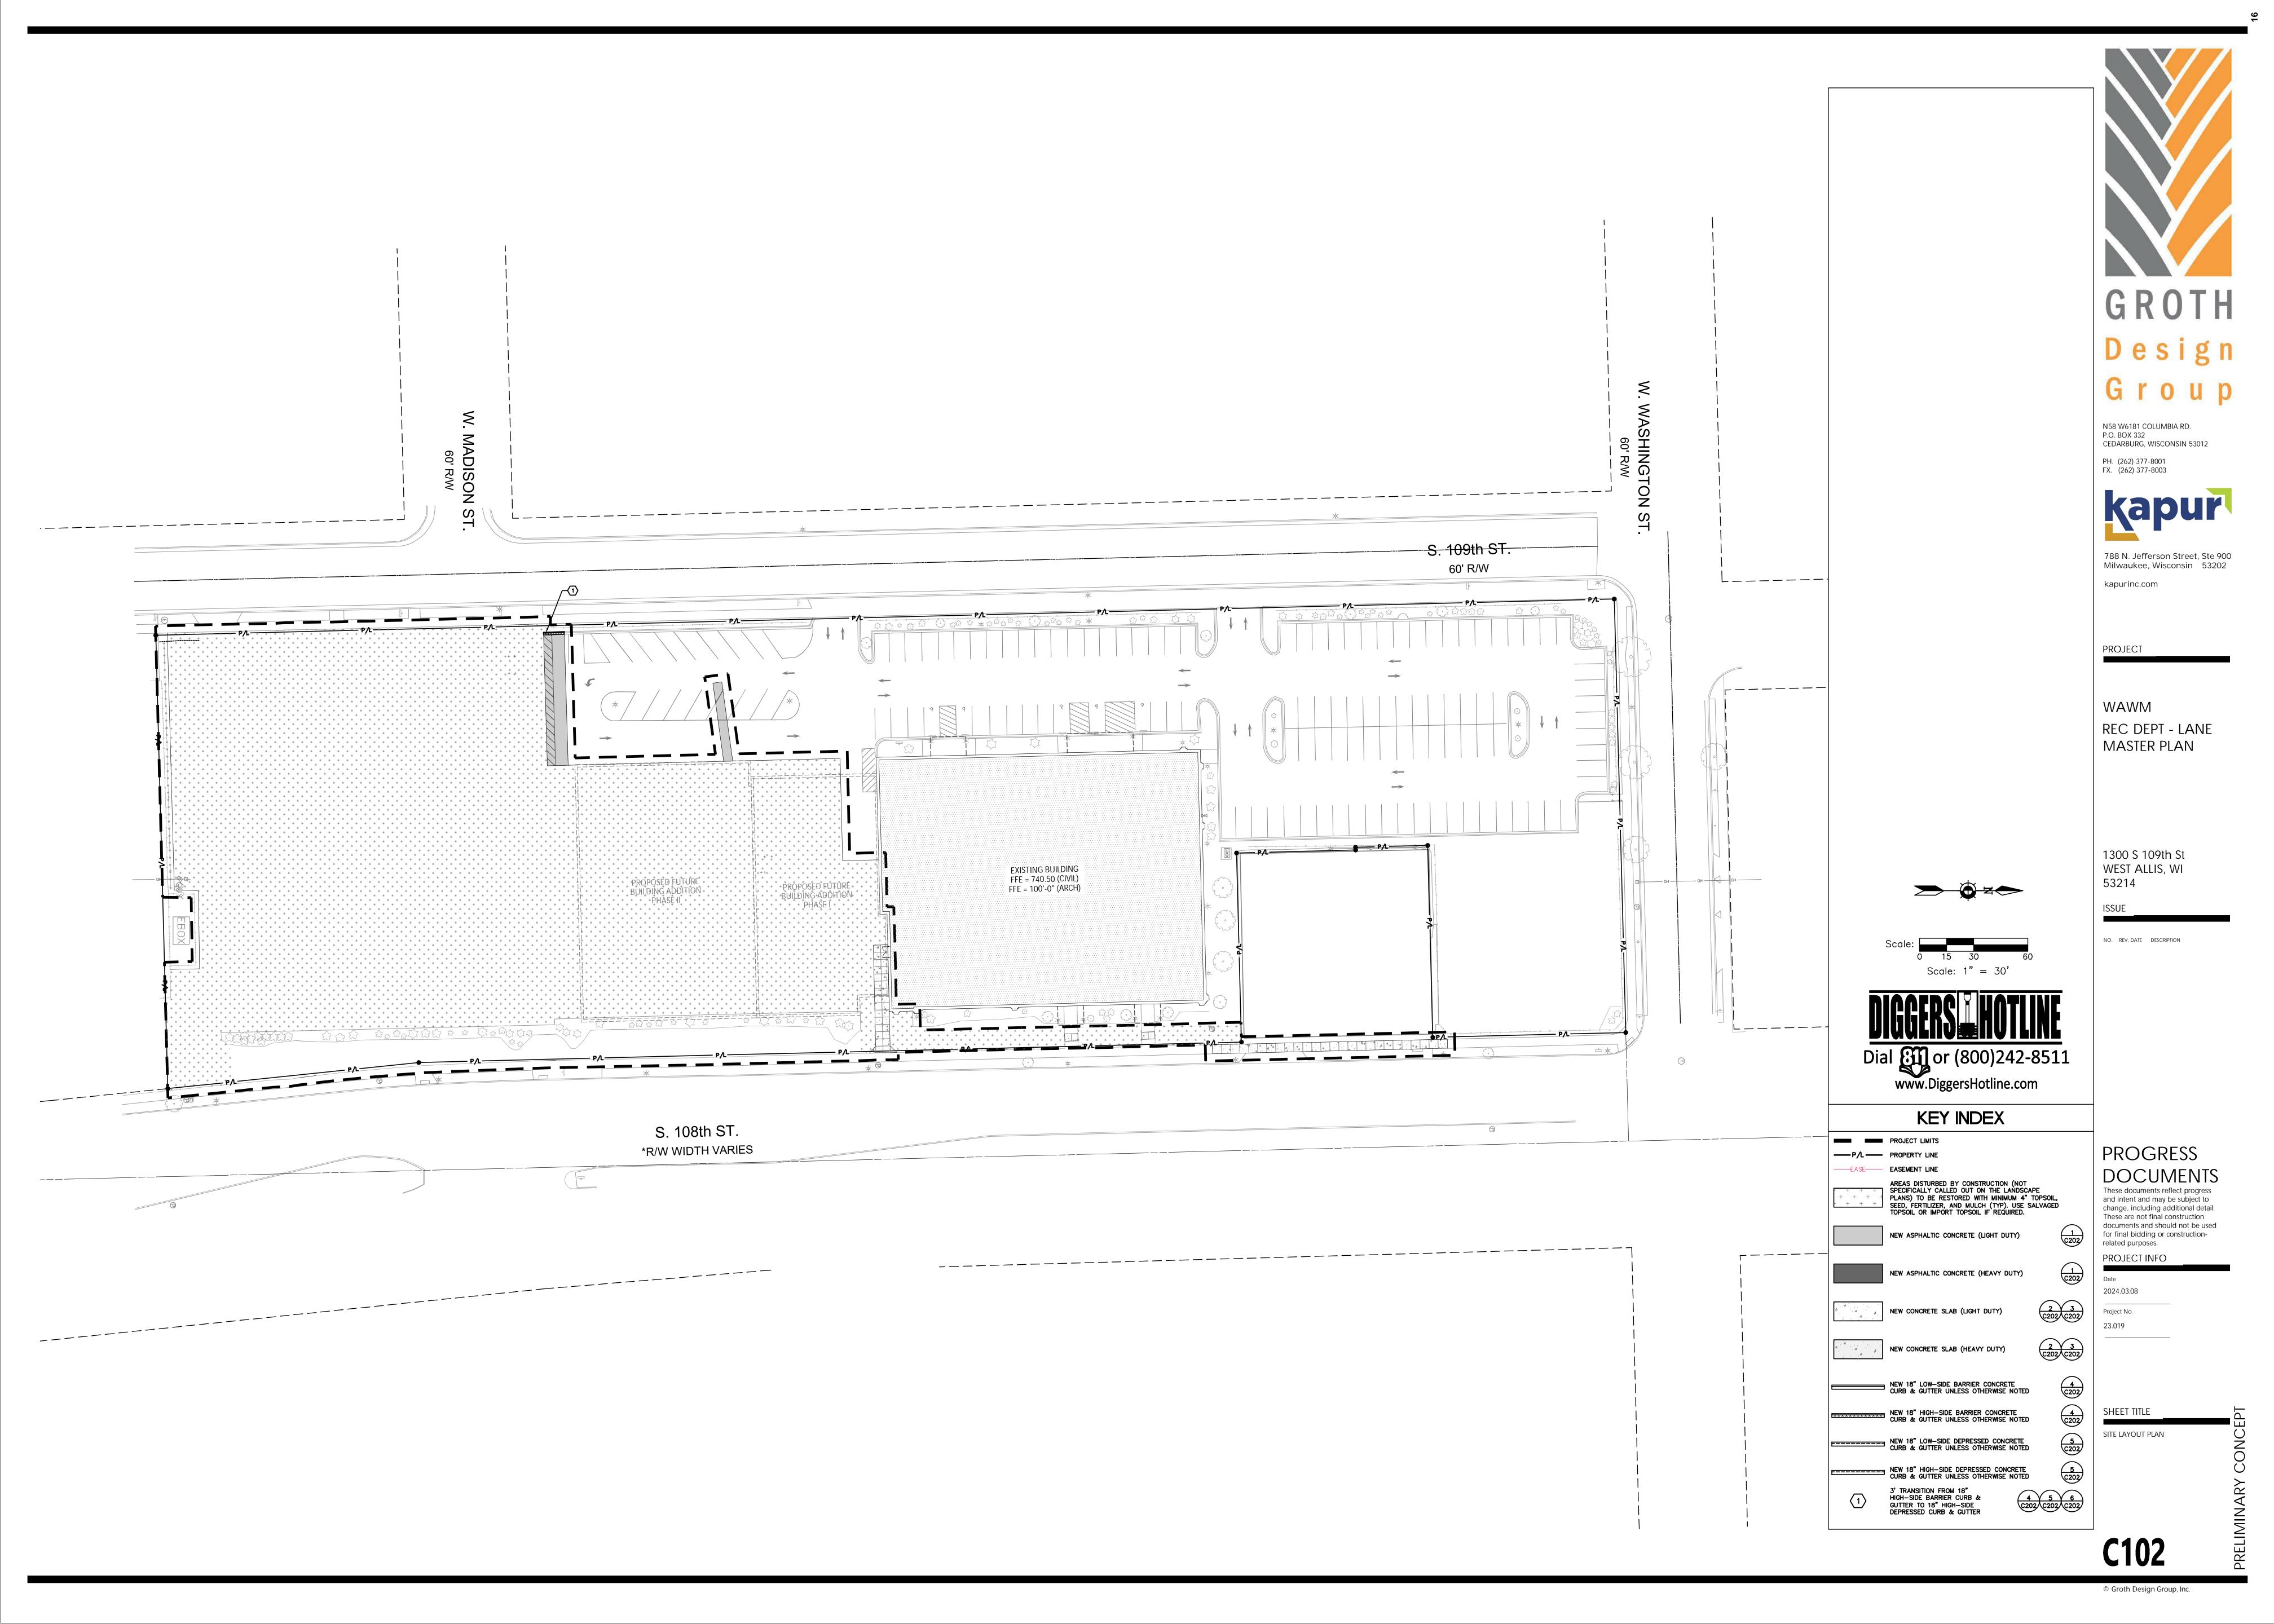



N58 W6181 COLUMBIA RD. P.O. BOX 332 CEDARBURG, WISCONSIN 53012 PH. (262) 377-8001 FX. (262) 377-8003



788 N. Jefferson Street, Ste 900 Milwaukee, Wisconsin 53202 kapurinc.com

PROJECT

WAWM

REC DEPT - LANE **MASTER PLAN**

1300 S 109th St

WEST ALLIS, WI

NO. REV. DATE DESCRIPTION

53214

GRADING NOTES

VERIFYING OWNERSHIP OF AND COORDINATING THE DEMOLITION AND / OR RELOCATION / ELEVATION ADJUSTMENT OF ALL EXISTING PUBLIC OR PRIVATE UTILITIES WITHIN THE PROJECT LIMITS THAT MAY BE AFFECTED BY TOPOGRAPHICAL CHANGES, UTILITIES, OR OTHER PROPOSED CONSTRUCTION ON THE PROJECT, INCLUDING BUT NOT LIMITED TO ELECTRICAL / FIBER OPTIC / TELEPHONE / CABLE / GAS / WATER / SANITARY / STORM. DEMOLITION / RELOCATION OF THIS UTILITY WORK MUST BE IN ACCORDANCE WITH ALL STATE, FEDERAL, LOCAL, AND UTILITY OWNER REGULATIONS.

KEY INDEX

EXISTING CONTOUR MAJOR

EROSION NOTES

INSPECT ALL EROSION CONTROL MEASURES PRIOR TO COMMENCING GRADING, GRUBBING OR OTHER LAND DISTURBING ACTIVITIES. EROSION CONTROL MEASURES MUST BE INSPECTED WEEKLY AND WITHIN 24 HOURS OF EVERY PRECIPITATION EVENT OF 0.50 INCH OR GREATER. IN ADDITION THE CONTRACTOR SHALL CONDUCT DAILY INSPECTIONS AND DOCUMENT CONDITIONS AND REPAIRS MADE ALONG WITH DATE, TIME OF INSPECTION AND WEATHER CONDITIONS IN A DAILY LOG BOOK. THE DAILY LOG BOOK, WEEKLY / 0.50 INCH PRECIPITATION REPORTS, APPROVED PLANS AND WPDES PERMIT SHALL BE KEPT IN AN ACCESSIBLE LOCATION, LIKE A MAILBOX, WITHIN THE STAGING AREA.

AT ABSOLUTELY NO TIME MAY CONSTRUCTION EQUIPMENT, DEBRIS, FILL, ETC. BE PLACED WITHIN WETLANDS, WATERWAYS OR FLOOD PLAINS UNLESS IDENTIFIED IN THE PLANS.

POINTS OF CONTACT

KEY INDEX

CONTRACTOR'S APPROVED WORK PLAN. DESIGNATES PROPOSED INLETS THAT MUST BE PROTECTED AFTER THEY HAVE BEEN CONSTRUCTED.

SHEET TITLE

SITE GRADING &

EROSION CONTROL

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These are not final construction

related purposes.

2024.03.08


Project No.

23.019

PROJECT INFO

documents and should not be used for final bidding or construction-

C103

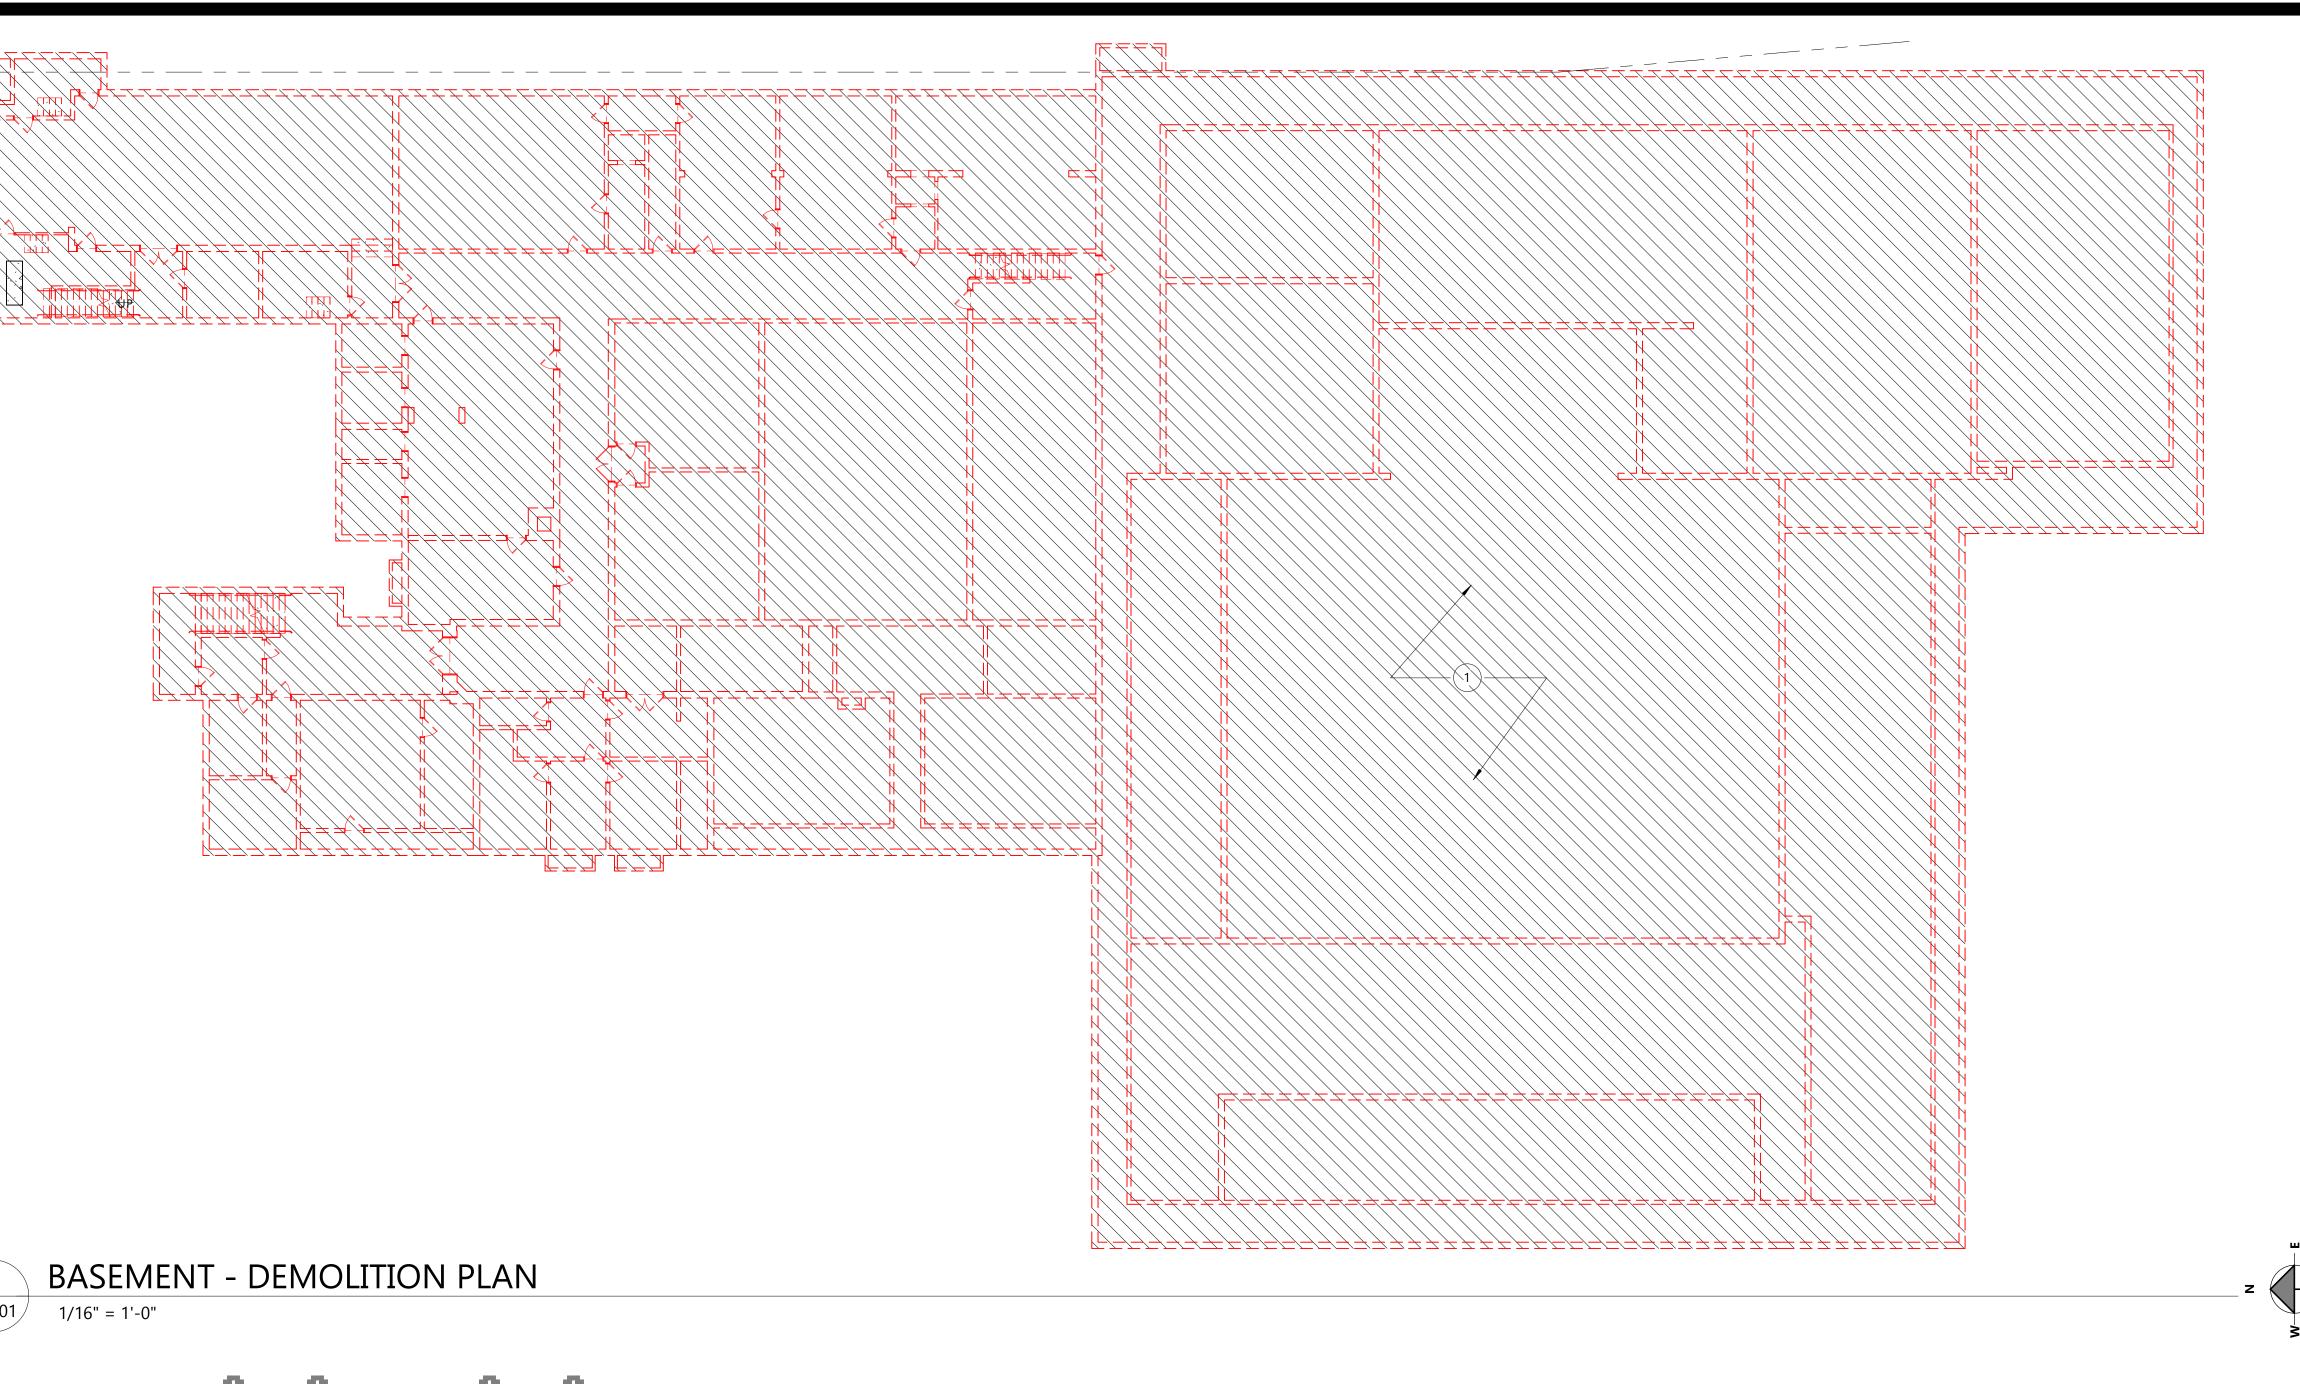

DEMOLITION PLAN - SYMBOL KEY

REMOVED DOOR

KEYED DEMOLITION PLAN NOTES

DESCRIPTION

REMOVE EXISTING DOOR, FRAME, & SIDE LITE(S) IN ITS ENTIRETY. IF POCKET DOOR,

PARTITION TO MATCH ADJACENT PARTITION CONSTRUCTION AND FINISH. PROVIDE

NECESSARY AND PER CODE. SALVAGE DOORS AND HARDWARE IN GOOD CONDITION

DEMO EXISTING DOOR AND FRAME. TO BE REPLACED WITH NEW EXTERIOR DOOR AND

REMOVE PARTITION AT POCKET AS NECESSARY TO REMOVE HARDWARE. PATCH

SMOOTH, PLUMB TRANSITIONS. DISCONNECT ALL ELECTRICAL HARDWARE AS

DEMO SECTION OF EXISTING PARTITION. COORDINATE EXTENT WITH NEW

(NOTE: EXISTING STEEL COLUMNS AND BEAMS ARE TO REMAIN.)

CONSTRUCTION. REMOVE EXISTING ELECTRICAL OUTLETS, WIRING, AND CONDUIT

REMOVE EXISTING PLUMBING FIXTURES AND ACCESSORIES. PREPARE FOR NEW

REMOVE EXISTING CASEWORK/COUNTER IN ITS ENTIRETY. PATCH AND PREPARE

REMOVE EQUIPMENT AND RETURN TO OWNER FOR REUSE. PATCH AND REPAIR ANY

DEMO ALL FIXTURES, CASEWORK, FLOOR FINISHES, AND WALL FINISHES. ALL TO BE

REMOVE EXISTING FLOORCOVERING AND BASE IN THIS AREA. PATCH AND PREPARE

FLOOR TO RECEIVE NEW FLOORCOVERING AND BASE. COORDINATE WITH NEW WORK.

PARTITION AND FLOOR SURFACE TO RECEIVE NEW FINISHES AS REQ'D.

BACK TO NEAREST JUNCTION BOX. REROUTE ALL NECESSARY WIRING AND CONDUIT.

FIXTURES OR REMOVE PIPING BACK TO NEAREST BRANCH PIPE, INSTALL VALVE AND

CAP PLUMBING. COORDINATE W/ NEW CONSTRUCTION. PATCH PARTITION TO MATCH ADJACENT PARTITION SURFACE. PATCH AND REPAIR FLOOR TO RECEIVE NEW FLOOR

EXISTING WALL TO REMAIN

= = REMOVED WALL

TAG #

NEW WALL

MASS DEMO

COVERING.

DAMAGED SURFACES.

REPLACED IN SAME LOCATION

DEMO LOCKERS

SALVAGE BY WAWM IN ALL DEMO AREAS

FOR REUSE. RETURN EXCESS HARDWARE TO OWNER.

REMOVE AND SALVAGE FUME HOOD FOR OWNER

A. CONTRACTOR TO REVIEW SCOPE OF NEW CONSTRUCTION IN CONJUNCTION WITH DEMOLITION PLANS TO COORDINATE SCOPE OF WORK. CONTRACTOR TO CONTACT OWNER & ARCHITECT WITH ANY QUESTIONS OR CONCERNS PRIOR TO MATERIAL REMOVAL

B. CONTRACTOR SHALL PRESERVE AND PROTECT ALL EXISTING BUILDING AMENITIES NOT SLATED FOR DEMOLITION OR REMODELING.

C. VERIFY ALL DIMENSIONS AND CONDITIONS IN FIELD PRIOR TO START OF WORK.
PORTIONS OF EXISTING CONSTRUCTION MAY HAVE BEEN REMOVED OR ALTERED. ALL
DISCREPANCIES BETWEEN EXISTING CONDITIONS AND CONTRACT DOCUMENTS SHOULD
BE BROUGHT TO THE ARCHITECT'S ATTENTION IMMEDIATELY.

D. REFER TO MECHANICAL, ELECTRICAL, AND PLUMBING PLANS FOR ADDITIONAL DEMOLITION ITEMS AND NOTES. COORDINATE WORK WITH MEP REQUIREMENTS

E. MAINTAIN CONTINUOUS UTILITY SERVICE TO ALL SPACES IN THE BUILDING NOT AFFECTED BY THIS WORK. COORDINATE W/ OWNER MINIMUM 72 HOURS IN ADVANCE FOR ANY DISRUPTION IN SERVICES REQUIRED TO PERFORM THE WORK OR TO MODIFY EXISTING PIPING, DUCTWORK, OR ASSOCIATED EQUIPMENT

SCOPE OF DEMOLITION SHOWN CONSTITUTES MINIMUM AMOUNT NEEDED TO MEET DESIGN INTENT. ADDITIONAL DEMOLITION, REMOVAL, PATCHING, REPAIRS, OR REPLACEMENT OF ITEMS MAY BE REQUIRED TO ACCOMMODATE CONTRACTOR PHASING, SEQUENCING, OR MEANS & METHODS. THE ARCHITECT SHALL BE NOTIFIED OF ADDITIONAL SCOPE REQUIRED TO COMPLETE THE WORK PRIOR TO REMOVAL. THE CONTRACTOR SHALL BE RESPONSIBLE FOR REPLACING ANY REMOVED ITEMS SHOWN IN THE DOCUMENTS AS EXISTING TO REMAIN.

REMOVE ALL EXISTING INCIDENTAL CONDITIONS AS REQUIRED TO ACCOMMODATE PROPOSED CONSTRUCTION WHETHER SHOWN ON PLANS OR NOT. INCLUDING BUT NOT LIMITED TO FASTENERS, CLIPS, MOULDINGS, OUTLETS, CONDUIT, WIRING, PIPING, FIXTURES, FITTINGS, AND OTHER SYSTEMS. REROUTE CIRCUITS, PLUMBING, AND DUCTWORK AS REQUIRED TO MAINTAIN SERVICEABILITY OF SYSTEMS TO REMAIN.

ALL HAZARDOUS MATERIALS TO BE DISPOSED OF PER APPLICABLE STATE, LOCAL, OR FEDERAL CODES & REGULATIONS

PATCH ANY OPENINGS OR GAPS IN EXISTING FLOORS, WALLS, ROOF, OR FIRE RESISTIVE ASSEMBLIES CAUSED BY THE WORK TO MAINTAIN THE INTEGRITY OF FIRE RATINGS, WEATHER RESISTANCE, VAPOR BARRIERS, ETC. ANY DEFICIENCIES FOUND IN THE EXISTING CONSTRUCTION SHOULD BE BROUGHT TO THE ARCHITECT AND OWNER'S ATTENTION IMMEDIATELY.

CONTRACTOR TO VERIFY EXISTING WALL CONSTRUCTION. CONTRACTOR TO PATCH AND REPAIR EXISTING WALLS TO REMAIN WITH LIKE CONSTRUCTION UNLESS NOTED

OTHERWISE AND PROVIDE A SUITABLE SURFACE TO RECEIVE NEW FINISHES.

REMOVE EXISTING FLOOR FINISHES SLATED FOR DEMOLITION TO SUB FLOOR AND

PREPARE FOR NEW FINISHES. SEE ROOM FINISH SCHEDULE

SALVAGE EXISTING DOORS AND HARDWARE FOR REUSE, REMOVE OR RETURN EXCESS DOORS AND HARDWARE TO OWNER.

M. SALVAGE EXISTING CASEWORK FOR REUSE, REMOVE OR RETURN EXCESS CASEWORK TO OWNER AT OWNER DISCRETION.

N. SALVAGE EXISTING PLUMBING FIXTURES FOR REUSE, REMOVE OR RETURN EXCESS FIXTURES TO OWNER AT OWNER DISCRETION. SEE PLUMBING DRAWINGS FOR ADDITIONAL INFORMATION

SALVAGE EXISTING LIFE SAFETY EQUIPMENT, FIRE EXTINGUISHERS, EXIT SIGNS, FIRE ALARMS, ETC. FOR REUSE, REMOVE OR RETURN EXCESS EQUIPMENT TO OWNER AT OWNER DISCRETION. SEE ELECTRICAL DRAWINGS FOR ADDITIONAL INFORMATION

P. SALVAGE EXISTING HVAC GRILLES AND LOUVERS FOR REUSE, REMOVE OR RETURN EXCESS TO OWNER AT OWNER DISCRETION. SEE MECHANICAL DRAWINGS FOR ADDITIONAL INFORMATION

SALVAGE EXISTING OUTLETS AND SWITCHES AND LIGHT FIXTURES FOR REUSE, PULL ALL ABANDONED WIRE FROM CONDUIT, RETURN EXCESS MATERIAL TO OWNER. SEE ELECTRICAL DRAWINGS FOR ADDITIONAL INFORMATION

SALVAGE EXISTING APPLIANCES, TOILET ACCESSORIES, SIGNAGE, AND EQUIPMENT FOR REUSE. REMOVE OR RETURN TO OWNER AT OWNER DISCRETION

LIFE SAFETY FEATURES ARE TO REMAIN IN OPERATION THROUGH ALL PHASES OF CONSTRUCTION INCLUDING SMOKE DETECTION AND OTHER SYSTEMS TO MEET ALL APPLICABLE CODES & REGULATIONS. VERIFY WITH OWNER AND LIFE SAFETY PLAN(S) FOR THE PROJECT.

GROTH

esign

N58 W6181 COLUMBIA RD. P.O. BOX 332

CEDARBURG, WISCONSIN 53012

PH. (262) 377-8001 FX. (262) 377-8003

DO IECT

WEST ALLIS-WEST MILWAUKEE RECREATION DEPARTMENT -LANE PHASE 01

1300 S 109th St West Allis, WI 53214

ISS

NO. REV. DATE DESCRIPTION


PROJECT INFO

23.019

SHEET TITLE

DEMOLITION PLAN - LEV

AD101

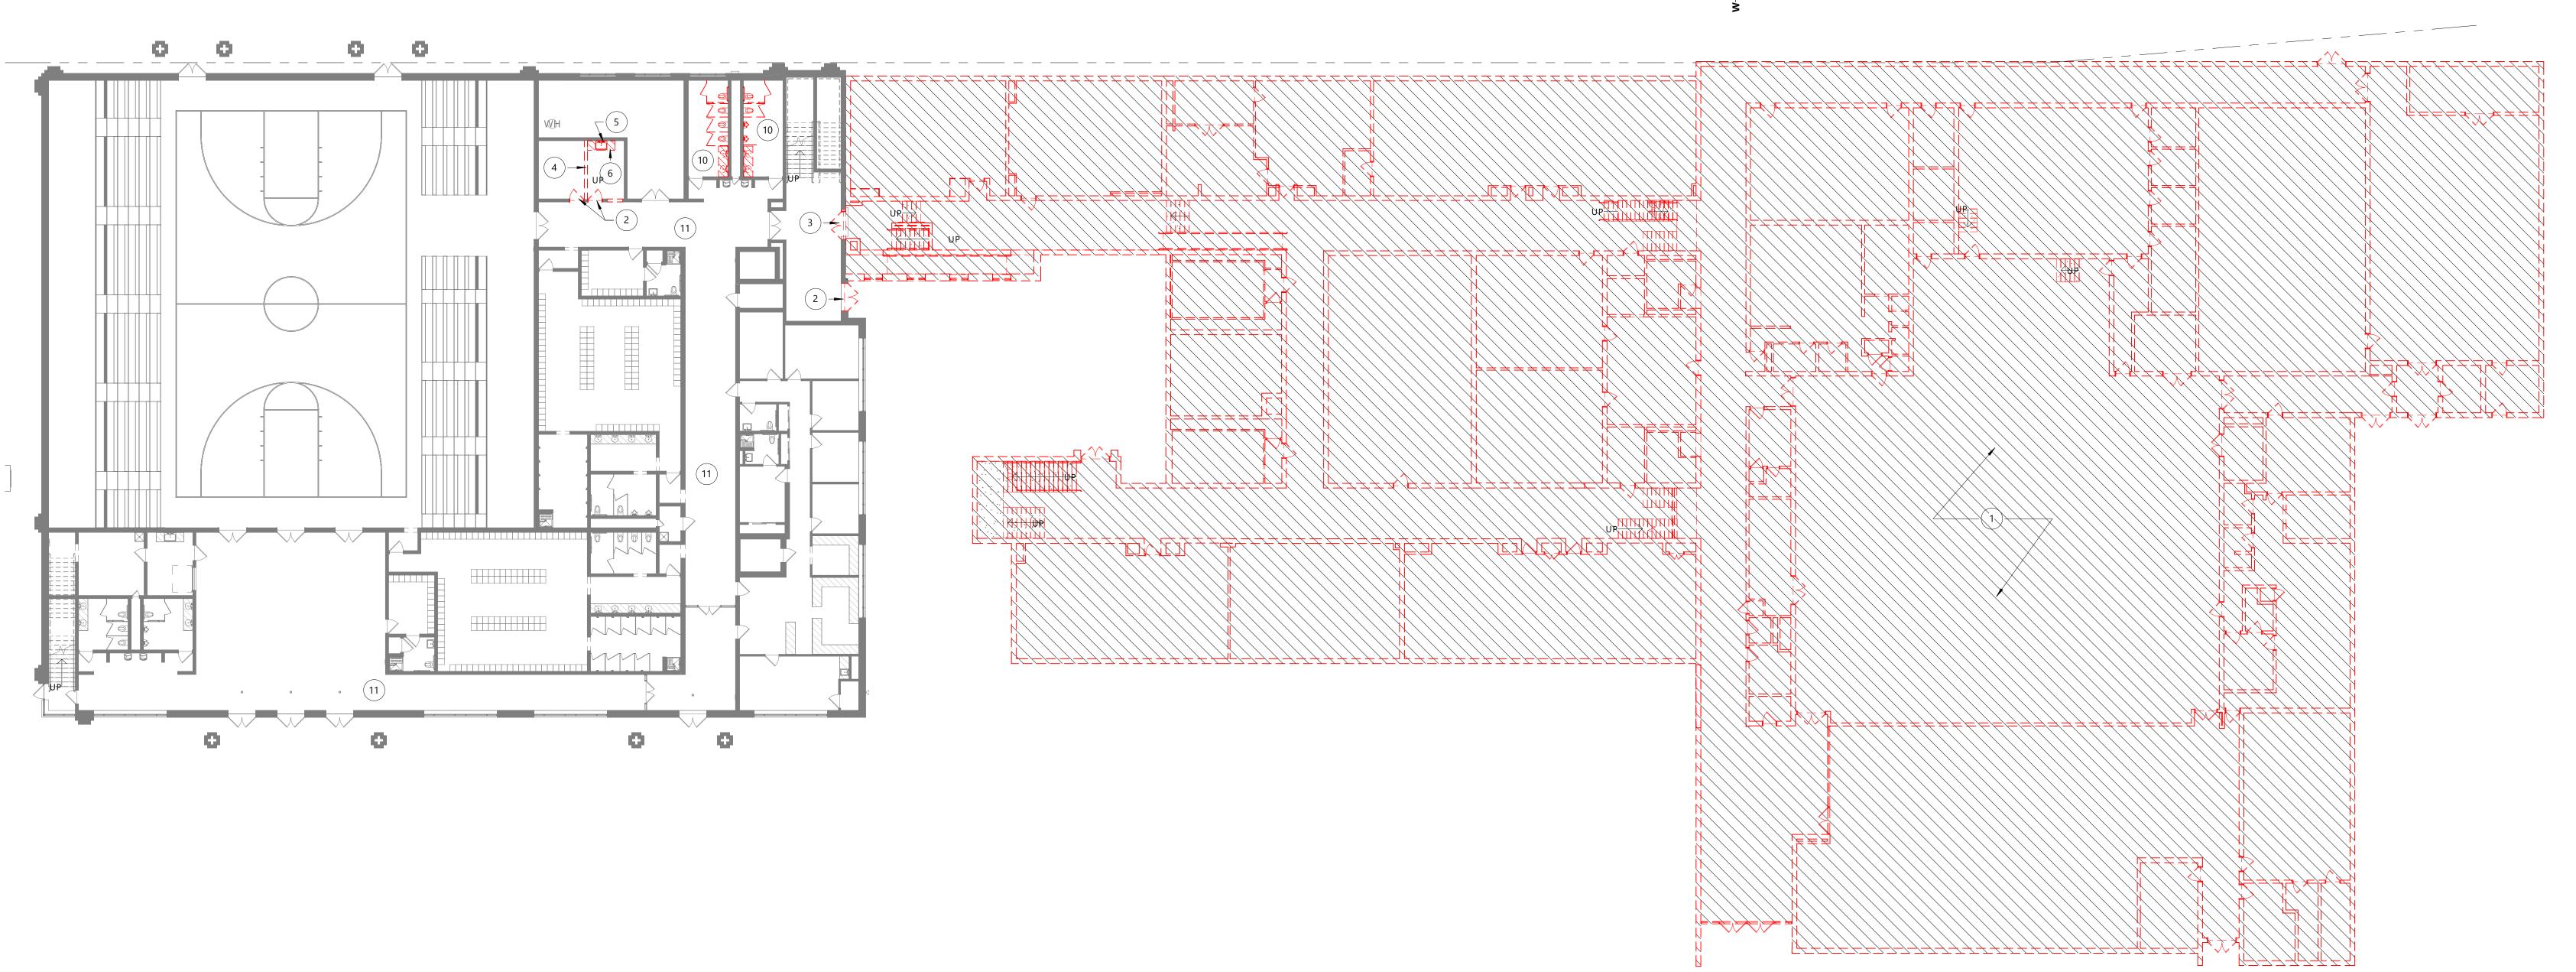

DEMOLITION PLAN GENERAL NOTES:

- A. CONTRACTOR TO REVIEW SCOPE OF NEW CONSTRUCTION IN CONJUNCTION WITH DEMOLITION PLANS TO COORDINATE SCOPE OF WORK. CONTRACTOR TO CONTACT OWNER & ARCHITECT WITH ANY QUESTIONS OR CONCERNS PRIOR TO MATERIAL REMOVAL
- CONTRACTOR SHALL PRESERVE AND PROTECT ALL EXISTING BUILDING AMENITIES NOT SLATED FOR DEMOLITION OR REMODELING.
- VERIFY ALL DIMENSIONS AND CONDITIONS IN FIELD PRIOR TO START OF WORK. PORTIONS OF EXISTING CONSTRUCTION MAY HAVE BEEN REMOVED OR ALTERED. ALL DISCREPANCIES BETWEEN EXISTING CONDITIONS AND CONTRACT DOCUMENTS SHOULD BE BROUGHT TO THE ARCHITECT'S ATTENTION IMMEDIATELY.
- REFER TO MECHANICAL, ELECTRICAL, AND PLUMBING PLANS FOR ADDITIONAL DEMOLITION ITEMS AND NOTES. COORDINATE WORK WITH MEP REQUIREMENTS
- MAINTAIN CONTINUOUS UTILITY SERVICE TO ALL SPACES IN THE BUILDING NOT AFFECTED BY THIS WORK. COORDINATE W/ OWNER MINIMUM 72 HOURS IN ADVANCE FOR ANY DISRUPTION IN SERVICES REQUIRED TO PERFORM THE WORK OR TO MODIFY EXISTING PIPING, DUCTWORK, OR ASSOCIATED EQUIPMENT
- SCOPE OF DEMOLITION SHOWN CONSTITUTES MINIMUM AMOUNT NEEDED TO MEET DESIGN INTENT. ADDITIONAL DEMOLITION, REMOVAL, PATCHING, REPAIRS, OR REPLACEMENT OF ITEMS MAY BE REQUIRED TO ACCOMMODATE CONTRACTOR PHASING, SEQUENCING, OR MEANS & METHODS. THE ARCHITECT SHALL BE NOTIFIED OF ADDITIONAL SCOPE REQUIRED TO COMPLETE THE WORK PRIOR TO REMOVAL. THE CONTRACTOR SHALL BE RESPONSIBLE FOR REPLACING ANY REMOVED ITEMS SHOWN IN THE DOCUMENTS AS EXISTING TO REMAIN.
- REMOVE ALL EXISTING INCIDENTAL CONDITIONS AS REQUIRED TO ACCOMMODATE PROPOSED CONSTRUCTION WHETHER SHOWN ON PLANS OR NOT. INCLUDING BUT NOT LIMITED TO FASTENERS, CLIPS, MOULDINGS, OUTLETS, CONDUIT, WIRING, PIPING, FIXTURES, FITTINGS, AND OTHER SYSTEMS. REROUTE CIRCUITS, PLUMBING, AND
- DUCTWORK AS REQUIRED TO MAINTAIN SERVICEABILITY OF SYSTEMS TO REMAIN. ALL HAZARDOUS MATERIALS TO BE DISPOSED OF PER APPLICABLE STATE, LOCAL, OR FEDERAL CODES & REGULATIONS
- PATCH ANY OPENINGS OR GAPS IN EXISTING FLOORS, WALLS, ROOF, OR FIRE RESISTIVE ASSEMBLIES CAUSED BY THE WORK TO MAINTAIN THE INTEGRITY OF FIRE RATINGS, WEATHER RESISTANCE, VAPOR BARRIERS, ETC. ANY DEFICIENCIES FOUND IN THE EXISTING CONSTRUCTION SHOULD BE BROUGHT TO THE ARCHITECT AND OWNER'S ATTENTION IMMEDIATELY.
- CONTRACTOR TO VERIFY EXISTING WALL CONSTRUCTION. CONTRACTOR TO PATCH AND REPAIR EXISTING WALLS TO REMAIN WITH LIKE CONSTRUCTION UNLESS NOTED OTHERWISE AND PROVIDE A SUITABLE SURFACE TO RECEIVE NEW FINISHES.
- REMOVE EXISTING FLOOR FINISHES SLATED FOR DEMOLITION TO SUB FLOOR AND
- SALVAGE EXISTING DOORS AND HARDWARE FOR REUSE, REMOVE OR RETURN EXCESS


PREPARE FOR NEW FINISHES. SEE ROOM FINISH SCHEDULE

- DOORS AND HARDWARE TO OWNER. SALVAGE EXISTING CASEWORK FOR REUSE, REMOVE OR RETURN EXCESS CASEWORK TO OWNER AT OWNER DISCRETION.
- SALVAGE EXISTING PLUMBING FIXTURES FOR REUSE, REMOVE OR RETURN EXCESS FIXTURES TO OWNER AT OWNER DISCRETION. SEE PLUMBING DRAWINGS FOR ADDITIONAL INFORMATION
- SALVAGE EXISTING LIFE SAFETY EQUIPMENT, FIRE EXTINGUISHERS, EXIT SIGNS, FIRE ALARMS, ETC. FOR REUSE, REMOVE OR RETURN EXCESS EQUIPMENT TO OWNER AT OWNER DISCRETION. SEE ELECTRICAL DRAWINGS FOR ADDITIONAL INFORMATION
- SALVAGE EXISTING HVAC GRILLES AND LOUVERS FOR REUSE, REMOVE OR RETURN EXCESS TO OWNER AT OWNER DISCRETION. SEE MECHANICAL DRAWINGS FOR
- SALVAGE EXISTING OUTLETS AND SWITCHES AND LIGHT FIXTURES FOR REUSE, PULL ALL ABANDONED WIRE FROM CONDUIT, RETURN EXCESS MATERIAL TO OWNER. SEE ELECTRICAL DRAWINGS FOR ADDITIONAL INFORMATION
- SALVAGE EXISTING APPLIANCES, TOILET ACCESSORIES, SIGNAGE, AND EQUIPMENT FOR
- REUSE. REMOVE OR RETURN TO OWNER AT OWNER DISCRETION
- LIFE SAFETY FEATURES ARE TO REMAIN IN OPERATION THROUGH ALL PHASES OF CONSTRUCTION INCLUDING SMOKE DETECTION AND OTHER SYSTEMS TO MEET ALL APPLICABLE CODES & REGULATIONS. VERIFY WITH OWNER AND LIFE SAFETY PLAN(S) FOR

DEMOLITION PLAN - SYMBOL KEY

ADDITIONAL INFORMATION

EXISTING WALL TO REMAIN EXISTING DOOR TO REMAIN = = REMOVED WALL

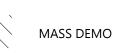

KEYED DEMOLITION PLAN NOTES

TAG # SALVAGE BY WAWM IN ALL DEMO AREAS REMOVE EXISTING DOOR, FRAME, & SIDE LITE(S) IN ITS ENTIRETY. IF POCKET DOOR, REMOVE PARTITION AT POCKET AS NECESSARY TO REMOVE HARDWARE. PATCH PARTITION TO MATCH ADJACENT PARTITION CONSTRUCTION AND FINISH. PROVIDE

DESCRIPTION

SMOOTH, PLUMB TRANSITIONS. DISCONNECT ALL ELECTRICAL HARDWARE AS

- NECESSARY AND PER CODE. SALVAGE DOORS AND HARDWARE IN GOOD CONDITION FOR REUSE. RETURN EXCESS HARDWARE TO OWNER. DEMO EXISTING DOOR AND FRAME. TO BE REPLACED WITH NEW EXTERIOR DOOR AND
- DEMO SECTION OF EXISTING PARTITION. COORDINATE EXTENT WITH NEW CONSTRUCTION. REMOVE EXISTING ELECTRICAL OUTLETS, WIRING, AND CONDUIT BACK TO NEAREST JUNCTION BOX. REROUTE ALL NECESSARY WIRING AND CONDUIT.
- (NOTE: EXISTING STEEL COLUMNS AND BEAMS ARE TO REMAIN.) REMOVE EXISTING PLUMBING FIXTURES AND ACCESSORIES. PREPARE FOR NEW FIXTURES OR REMOVE PIPING BACK TO NEAREST BRANCH PIPE, INSTALL VALVE AND CAP PLUMBING. COORDINATE W/ NEW CONSTRUCTION. PATCH PARTITION TO MATCH ADJACENT PARTITION SURFACE. PATCH AND REPAIR FLOOR TO RECEIVE NEW FLOOR
- REMOVE EXISTING CASEWORK/COUNTER IN ITS ENTIRETY. PATCH AND PREPARE PARTITION AND FLOOR SURFACE TO RECEIVE NEW FINISHES AS REQ'D. REMOVE EQUIPMENT AND RETURN TO OWNER FOR REUSE. PATCH AND REPAIR ANY DAMAGED SURFACES.
- REMOVE AND SALVAGE FUME HOOD FOR OWNER
- DEMO LOCKERS DEMO ALL FIXTURES, CASEWORK, FLOOR FINISHES, AND WALL FINISHES. ALL TO BE REPLACED IN SAME LOCATION
 - REMOVE EXISTING FLOORCOVERING AND BASE IN THIS AREA. PATCH AND PREPARE FLOOR TO RECEIVE NEW FLOORCOVERING AND BASE. COORDINATE WITH NEW WORK.

N58 W6181 COLUMBIA RD. P.O. BOX 332 CEDARBURG, WISCONSIN 53012 PH. (262) 377-8001

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WEST ALLIS-WEST MILWAUKEE RECREATION DEPARTMENT -LANE PHASE 01

1300 S 109th St West Allis, WI 53214

NO. REV. DATE DESCRIPTION

PROJECT INFO

2024-03-08 Project No.


SHEET TITLE

DEMOLITION PLAN - LEVEL 2

AD102

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LEVEL 2 - DEMOLITION PLAN 1/16" = 1'-0"

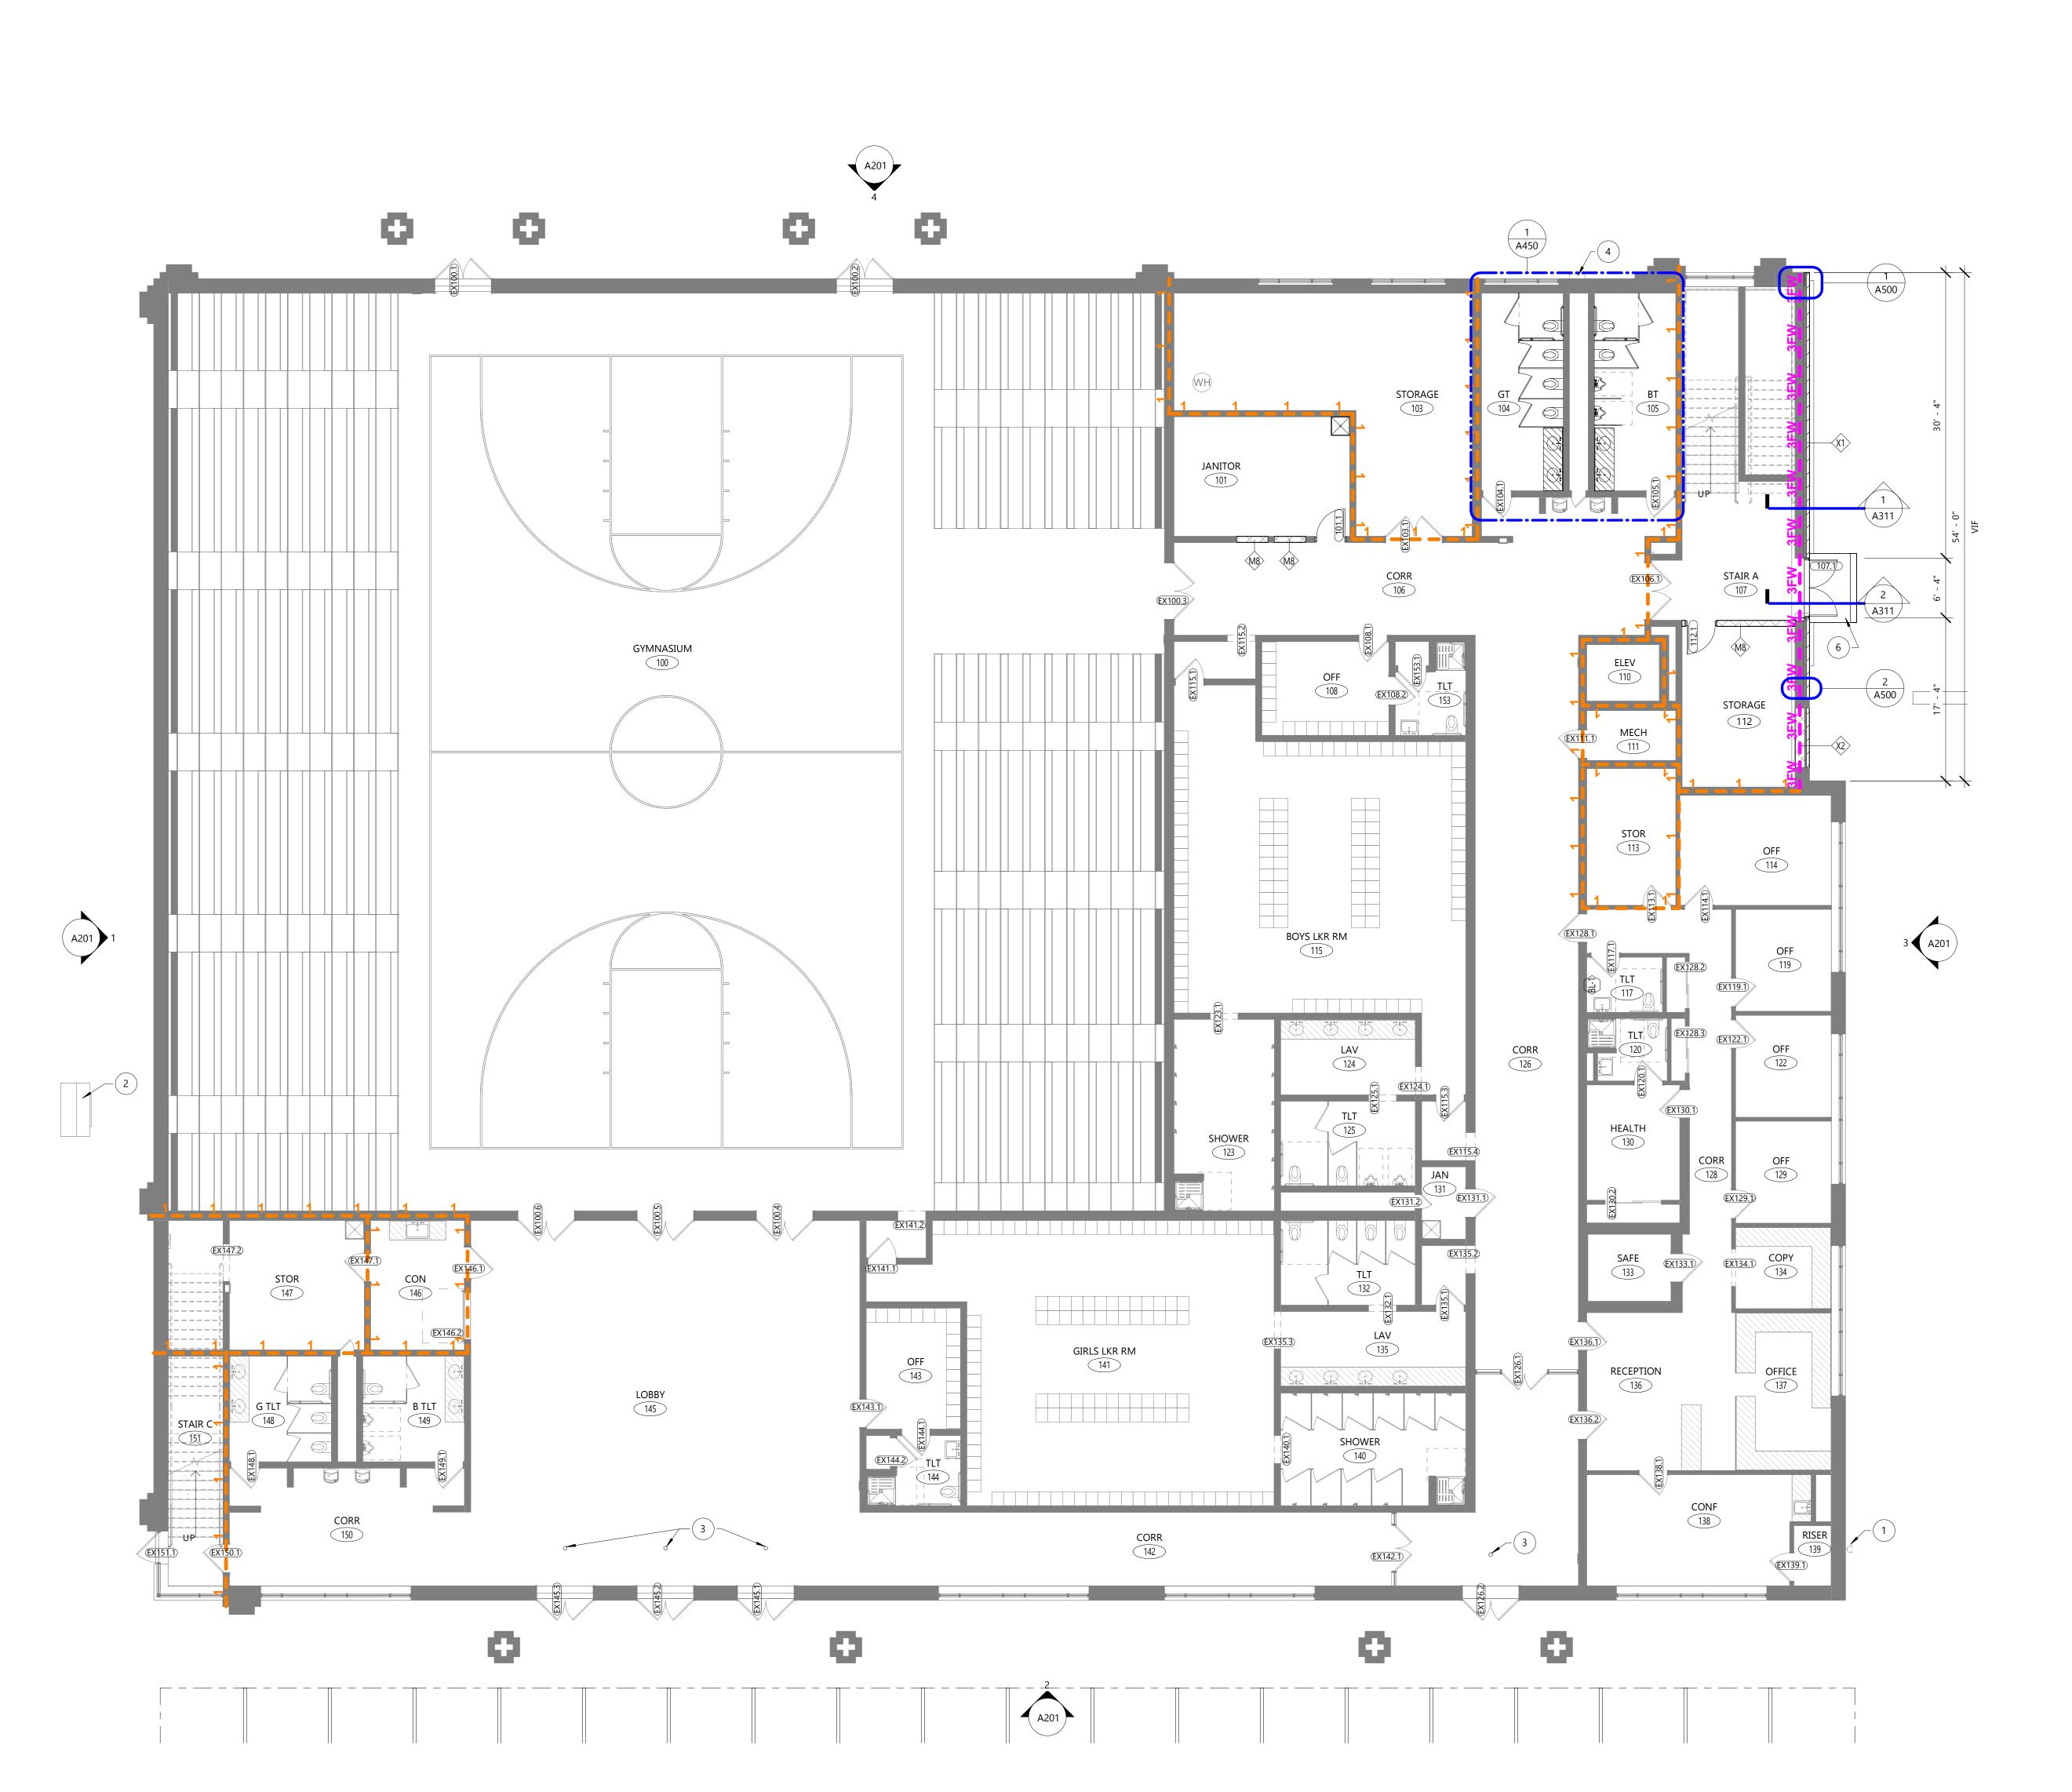

FLOOR PLAN GENERAL NOTES:

- A. SEE WALL SCHEDULE FOR WALL ASSEMBLY INFORMATION. NOTE: SEE SECTIONS AND ELEVATIONS FOR CHANGES IN MATERIALS/WALL TYPES/ACCENT-ELEMENTS THAT MAY NOT BE INDICATED AT PLAN CUT.
- B. SEE 7 / A002 FOR TYPICAL DIMENSIONS OF DOOR OPENING FROM ADJACENT WALL.
- PROVIDE BLOCKING AT ALL MILLWORK AND WALL HUNG ELEMENTS IN WALLS. CONTRACTOR TO COORDINATE W/ OWNER REPRESENTATIVE FOR FINAL LOCATIONS OF OWNER-FURNISHED EQUIPMENT. SEE DETAIL 9 / A002 . ALL WOOD BLOCKING TO BE FIRE-RETARDANT TREATED WOOD IN BUILDINGS OF NONCOMBUSTIBLE CONSTRUCTION (IBC TYPE I & II) AND IN RATED WALLS IN BUILDINGS OF COMBUSTIBLE CONSTRUCTION (IBC TYPE III, IV, & V).
- PROVIDE CORNER GUARDS AS SHOWN GRAPHICALLY. SEE FINISH PLAN FOR COLORS & TYPES. ALL OUTSIDE CORNERS NOT SHOWN RECEIVING CORNER GUARDS ARE TO BE VERIFIED WITH ARCHITECT DURING BIDDING
- ALL INTERIOR PLAN DIMENSIONS ARE TO FACE OF INTERIOR FINISH OF WALL, U.N.O.
- F. ALL EXTERIOR DIMENSIONS ARE PER DETAIL 8 / A002 , U.N.O.
- G. ALL VERTICAL DIMENSIONS TO BE ABOVE FINISH FLOOR (A.F.F.) U.N.O.

FOR FUTURE PAINTING APPLICATION

FLOOR PLAN - SYMBOL KEY

= = = REMOVED WALL

===== NEW WALL

101.1 DOOR TAG

FIRE EXTINGUISHERS

TS TOUCHLESS SENSOR DOOR ACTUATOR

PP PUSH PAD DOOR ACTUATOR

CR CARD READER

CJ CONTROL JOINT

1 FIRE DEPARTMENT CONNECTION

FIBER OPTIC CONNECTION

ROOF ACCESS LADDER NEW CONCRETE STOOP

TRANSFORMER FLOOR DRAIN

FE-#

- H. ALL DOORS USED IN CONJUNCTION WITH EXITS SHALL BE ARRANGED TO READILY OPEN WITHOUT THE USE OF A KEY OR SPECIAL KNOWLEDGE FROM THE SIDE OF EGRESS.
- I. A THERMAL BREAK IN THE CONCRETE FLOOR SLAB IS REQUIRED AT ALL EXTERIOR DOOR LOCATIONS: SEE DOOR DETAILS FOR MORE INFORMATION
- J. ALL PARTITION PENETRATIONS SHALL BE FIELD VERIFIED, BRACED, AND SEALED TO MEET REQUIRED RATINGS. UTILIZE UL-APPROVED METHODS
- K. PROVIDE PROPER PREPARATION TO ALL SURFACES TO RECEIVE NEW FINISHES

ALL ROOMS TO RECEIVE ROOM AND NUMBER SIGNAGE ADJACENT TO DOOR,

- COORDINATE BLOCKING REQUIREMENTS WITH SIGN VENDOR. M. WHERE FLOOR DRAINS ARE REQUIRED (SEE PLUMBING) PITCH CONCRETE SLAB TO
- DRAINS 1/8" PER FOOT, TYP, UNLESS NOTED OTHERWISE. N. ALL GYPSUM BOARD INTERIOR SURFACES TO RECEIVE A LEVEL 4 FINISH AND PRIME COAT
- O. ALL PARTITIONS TO BE TYPE P1 AND EXTEND TO THE UNDERSIDE OF FLOOR/ROOF DECK
- ABOVE UNLESS NOTED OTHERWISE

EXISTING WALL TO REMAIN EXISTING DOOR TO REMAIN

MILLWORK. SEE INTERIOR ELEVATIONS AND DETAILS

FE-1 - RECESSED CABINET FE-2 - SEMI-RECESSED CABINET

FE-3 - SURFACE MOUNTED CABINET

FE-4 - SURFACE MOUNTED EXTINGUISHER ONLY

KEYED FLOOR PLAN NOTES

7 PLASTIC LAMINATE COUNTERTOP ON 3/4" PARTICLE BOARD (25" DEEP UNLESS NOTED OTHERWISE ON PLANS). FRONT WATERFALL EDGE. PROVIDE COVED, WATERFALL

BACKSPLASHES AND SIDESPLASHES WHERE SHOWN IN ELEVATIONS

8 STAINLESS STEEL DROP-IN SINK W/ GOOSENECK FAUCET & WRIST BLADES

DESCRIPTION

WALL TYPE TAG. SEE WALL TYPES SHEET FOR ADDITIONAL INFORMATION

REMOVED DOOR

₿L-3 WINDOW TAG

Design

N58 W6181 COLUMBIA RD. P.O. BOX 332 CEDARBURG, WISCONSIN 53012 PH. (262) 377-8001 FX. (262) 377-8003

WEST ALLIS-WEST

1300 S 109th St West Allis, WI

NO. REV. DATE DESCRIPTION

MILWAUKEE RECREATION DEPARTMENT -**LANE PHASE 01**

53214

PROJECT INFO

2024-03-08


Project No.

SHEET TITLE

FLOOR PLAN - LEVEL 1

A101

LEVEL 1 - FLOOR PLAN

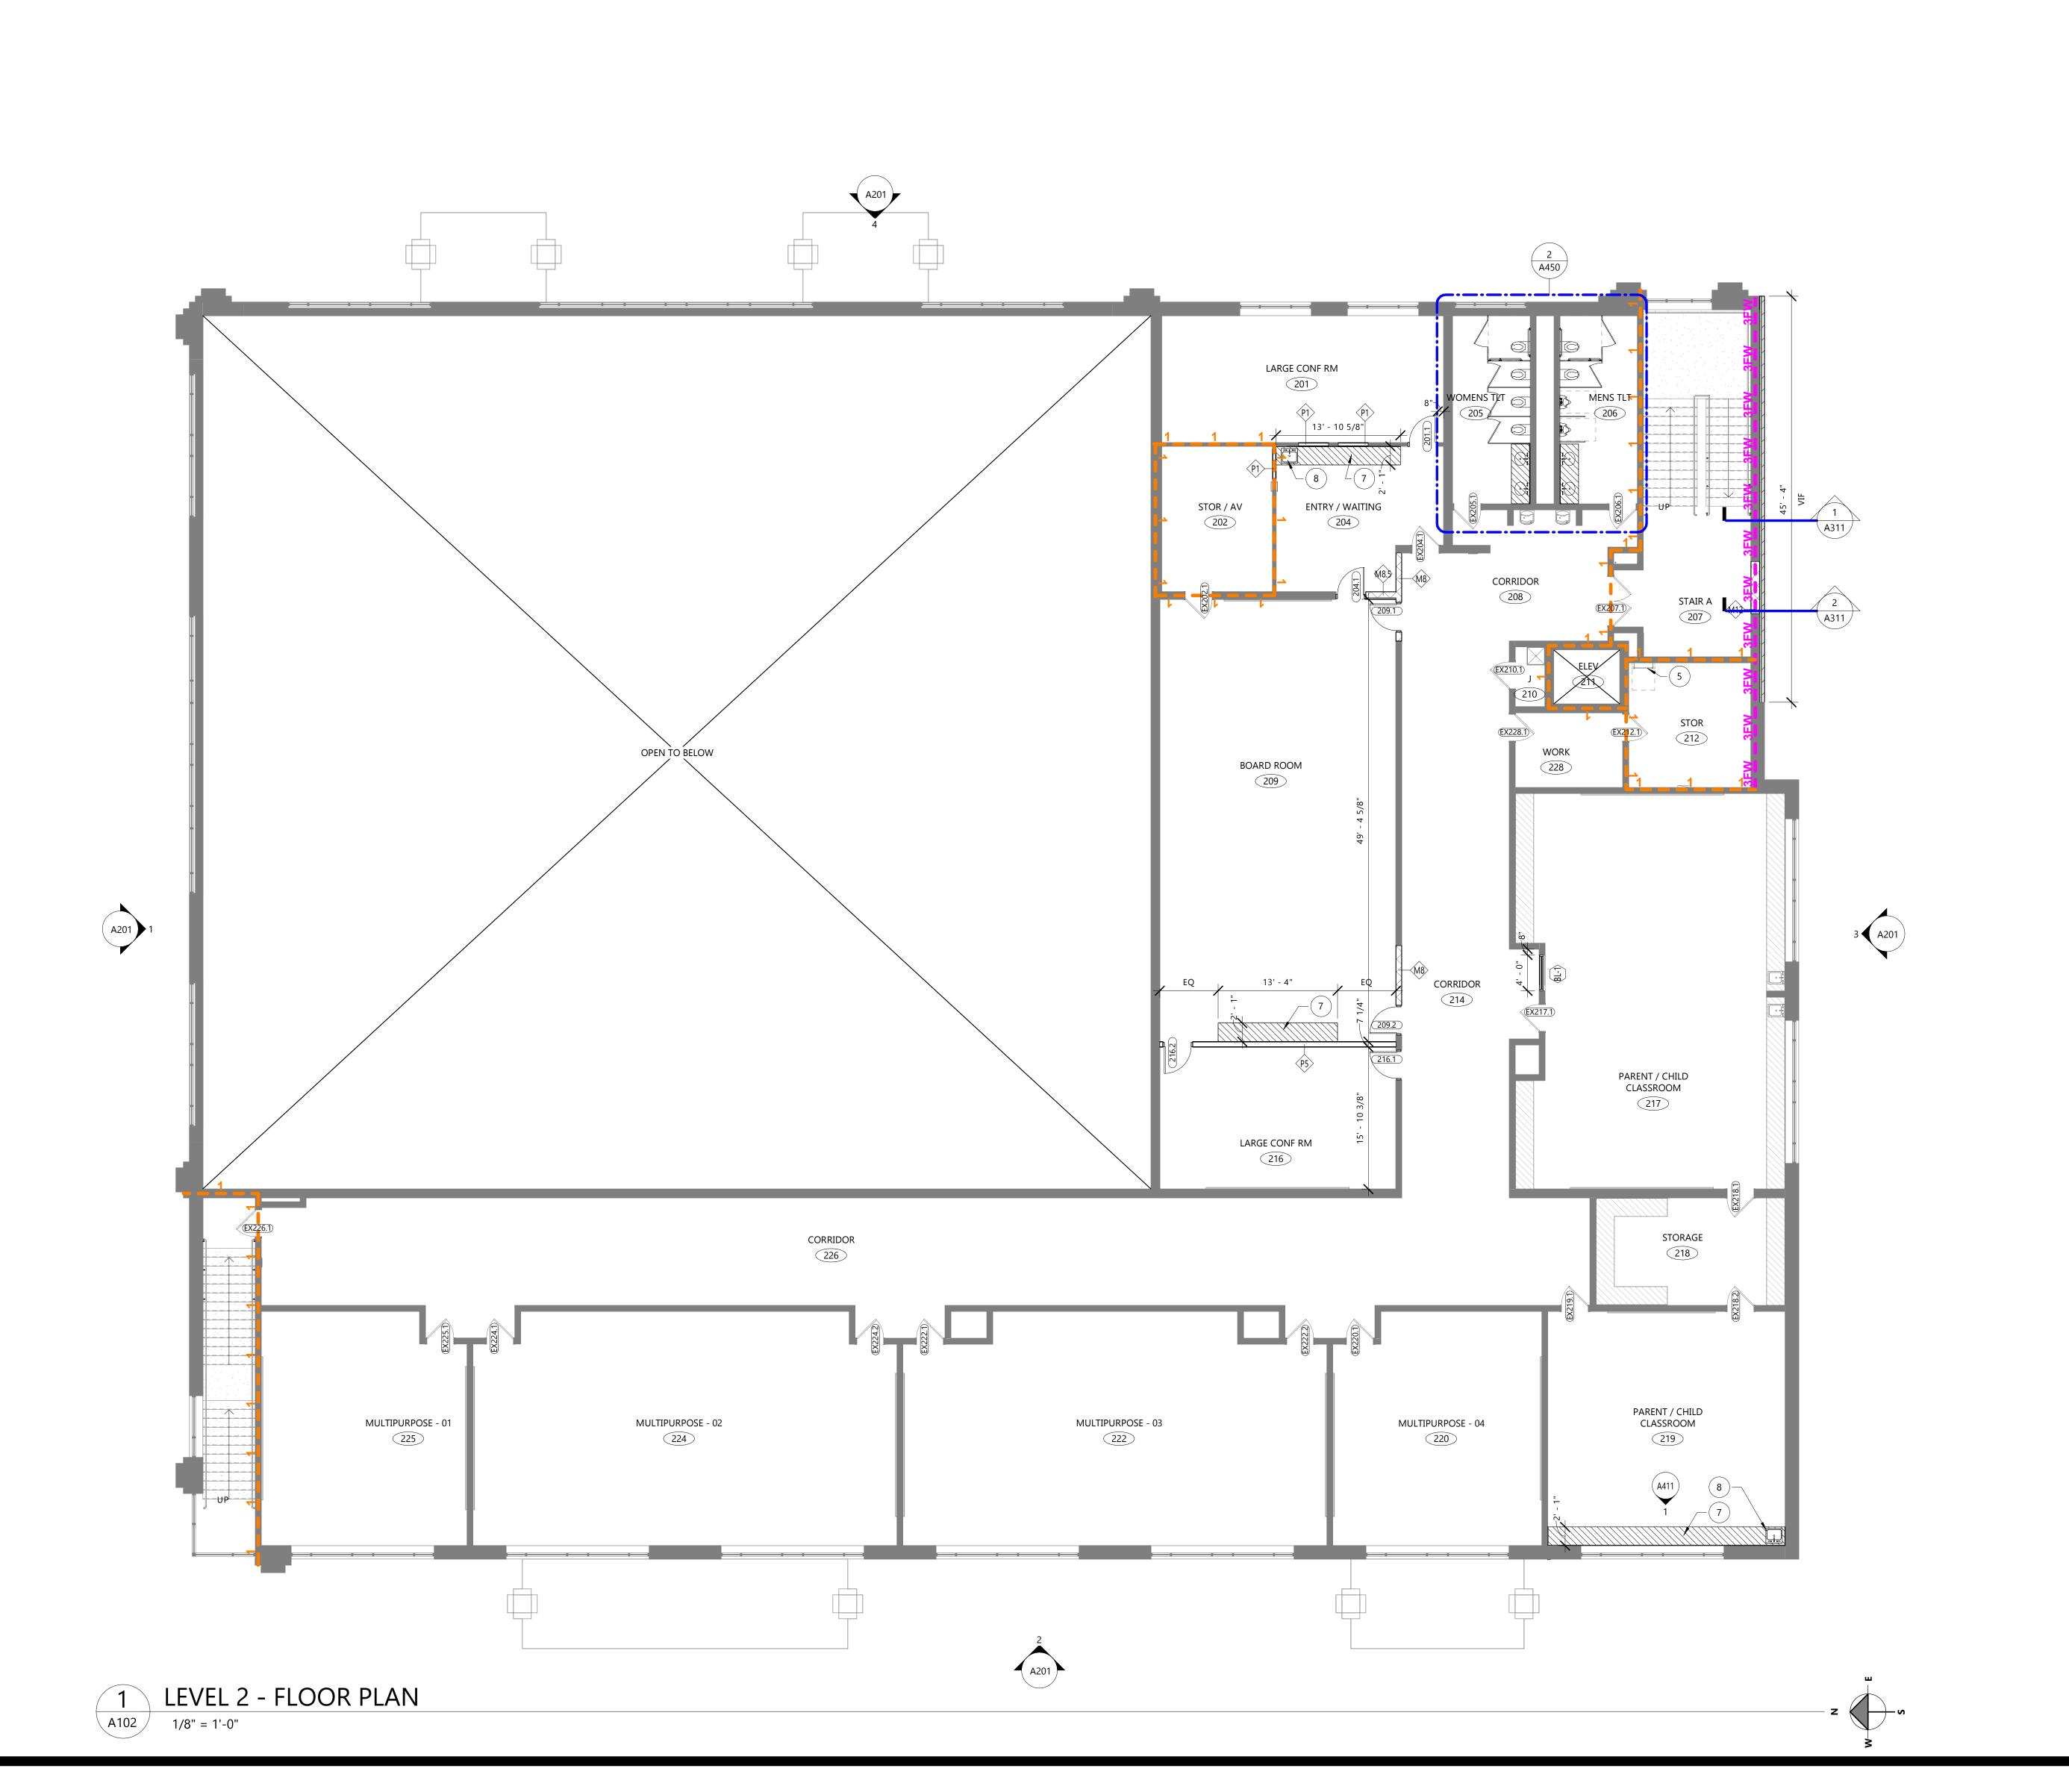

FLOOR PLAN GENERAL NOTES:

- A. SEE WALL SCHEDULE FOR WALL ASSEMBLY INFORMATION. NOTE: SEE SECTIONS AND ELEVATIONS FOR CHANGES IN MATERIALS/WALL TYPES/ACCENT-ELEMENTS THAT MAY NOT BE INDICATED AT PLAN CUT.
- B. SEE 7 / A002 FOR TYPICAL DIMENSIONS OF DOOR OPENING FROM ADJACENT WALL.
- PROVIDE BLOCKING AT ALL MILLWORK AND WALL HUNG ELEMENTS IN WALLS. CONTRACTOR TO COORDINATE W/ OWNER REPRESENTATIVE FOR FINAL LOCATIONS OF OWNER-FURNISHED EQUIPMENT. SEE DETAIL 9 / A002 . ALL WOOD BLOCKING TO BE FIRE-RETARDANT TREATED WOOD IN BUILDINGS OF NONCOMBUSTIBLE CONSTRUCTION (IBC TYPE I & II) AND IN RATED WALLS IN BUILDINGS OF COMBUSTIBLE CONSTRUCTION (IBC TYPE III, IV, & V).
- PROVIDE CORNER GUARDS AS SHOWN GRAPHICALLY. SEE FINISH PLAN FOR COLORS & TYPES. ALL OUTSIDE CORNERS NOT SHOWN RECEIVING CORNER GUARDS ARE TO BE VERIFIED WITH ARCHITECT DURING BIDDING
- E. ALL INTERIOR PLAN DIMENSIONS ARE TO FACE OF INTERIOR FINISH OF WALL, U.N.O.
- F. ALL EXTERIOR DIMENSIONS ARE PER DETAIL 8 / A002 , U.N.O.
- G. ALL VERTICAL DIMENSIONS TO BE ABOVE FINISH FLOOR (A.F.F.) U.N.O.
- H. ALL DOORS USED IN CONJUNCTION WITH EXITS SHALL BE ARRANGED TO READILY OPEN
- WITHOUT THE USE OF A KEY OR SPECIAL KNOWLEDGE FROM THE SIDE OF EGRESS.

I. A THERMAL BREAK IN THE CONCRETE FLOOR SLAB IS REQUIRED AT ALL EXTERIOR DOOR

- LOCATIONS: SEE DOOR DETAILS FOR MORE INFORMATION J. ALL PARTITION PENETRATIONS SHALL BE FIELD VERIFIED, BRACED, AND SEALED TO MEET REQUIRED RATINGS. UTILIZE UL-APPROVED METHODS
- K. PROVIDE PROPER PREPARATION TO ALL SURFACES TO RECEIVE NEW FINISHES
- ALL ROOMS TO RECEIVE ROOM AND NUMBER SIGNAGE ADJACENT TO DOOR, COORDINATE BLOCKING REQUIREMENTS WITH SIGN VENDOR.
- M. WHERE FLOOR DRAINS ARE REQUIRED (SEE PLUMBING) PITCH CONCRETE SLAB TO DRAINS 1/8" PER FOOT, TYP, UNLESS NOTED OTHERWISE.

N. ALL GYPSUM BOARD INTERIOR SURFACES TO RECEIVE A LEVEL 4 FINISH AND PRIME COAT

- FOR FUTURE PAINTING APPLICATION O. ALL PARTITIONS TO BE TYPE P1 AND EXTEND TO THE UNDERSIDE OF FLOOR/ROOF DECK
- ABOVE UNLESS NOTED OTHERWISE

PH. (262) 377-8001 FX. (262) 377-8003

Design

N58 W6181 COLUMBIA RD.

CEDARBURG, WISCONSIN 53012

WEST ALLIS-WEST

MILWAUKEE

RECREATION

1300 S 109th St

NO. REV. DATE DESCRIPTION

West Allis, WI

53214

DEPARTMENT -

LANE PHASE 01

P.O. BOX 332

FLOOR PLAN - SYMBOL KEY

EXISTING WALL TO REMAIN EXISTING DOOR TO REMAIN

= = = REMOVED WALL REMOVED DOOR

WALL TYPE TAG. SEE WALL TYPES SHEET FOR ADDITIONAL INFORMATION

NEW WALL

WINDOW TAG

FE-# FIRE EXTINGUISHERS

> FE-1 - RECESSED CABINET FE-2 - SEMI-RECESSED CABINET FE-3 - SURFACE MOUNTED CABINET

FE-4 - SURFACE MOUNTED EXTINGUISHER ONLY

MILLWORK. SEE INTERIOR ELEVATIONS AND DETAILS

PP PUSH PAD DOOR ACTUATOR

TS TOUCHLESS SENSOR DOOR ACTUATOR

CR CARD READER

CJ CONTROL JOINT

KEYED FLOOR PLAN NOTES

DESCRIPTION

1 FIRE DEPARTMENT CONNECTION TRANSFORMER

FLOOR DRAIN

FIBER OPTIC CONNECTION

ROOF ACCESS LADDER

NEW CONCRETE STOOP

PLASTIC LAMINATE COUNTERTOP ON 3/4" PARTICLE BOARD (25" DEEP UNLESS NOTED OTHERWISE ON PLANS). FRONT WATERFALL EDGE. PROVIDE COVED, WATERFALL

8 STAINLESS STEEL DROP-IN SINK W/ GOOSENECK FAUCET & WRIST BLADES

BACKSPLASHES AND SIDESPLASHES WHERE SHOWN IN ELEVATIONS

PROJECT INFO


2024-03-08

Project No.

SHEET TITLE

FLOOR PLAN - LEVEL 2

A102

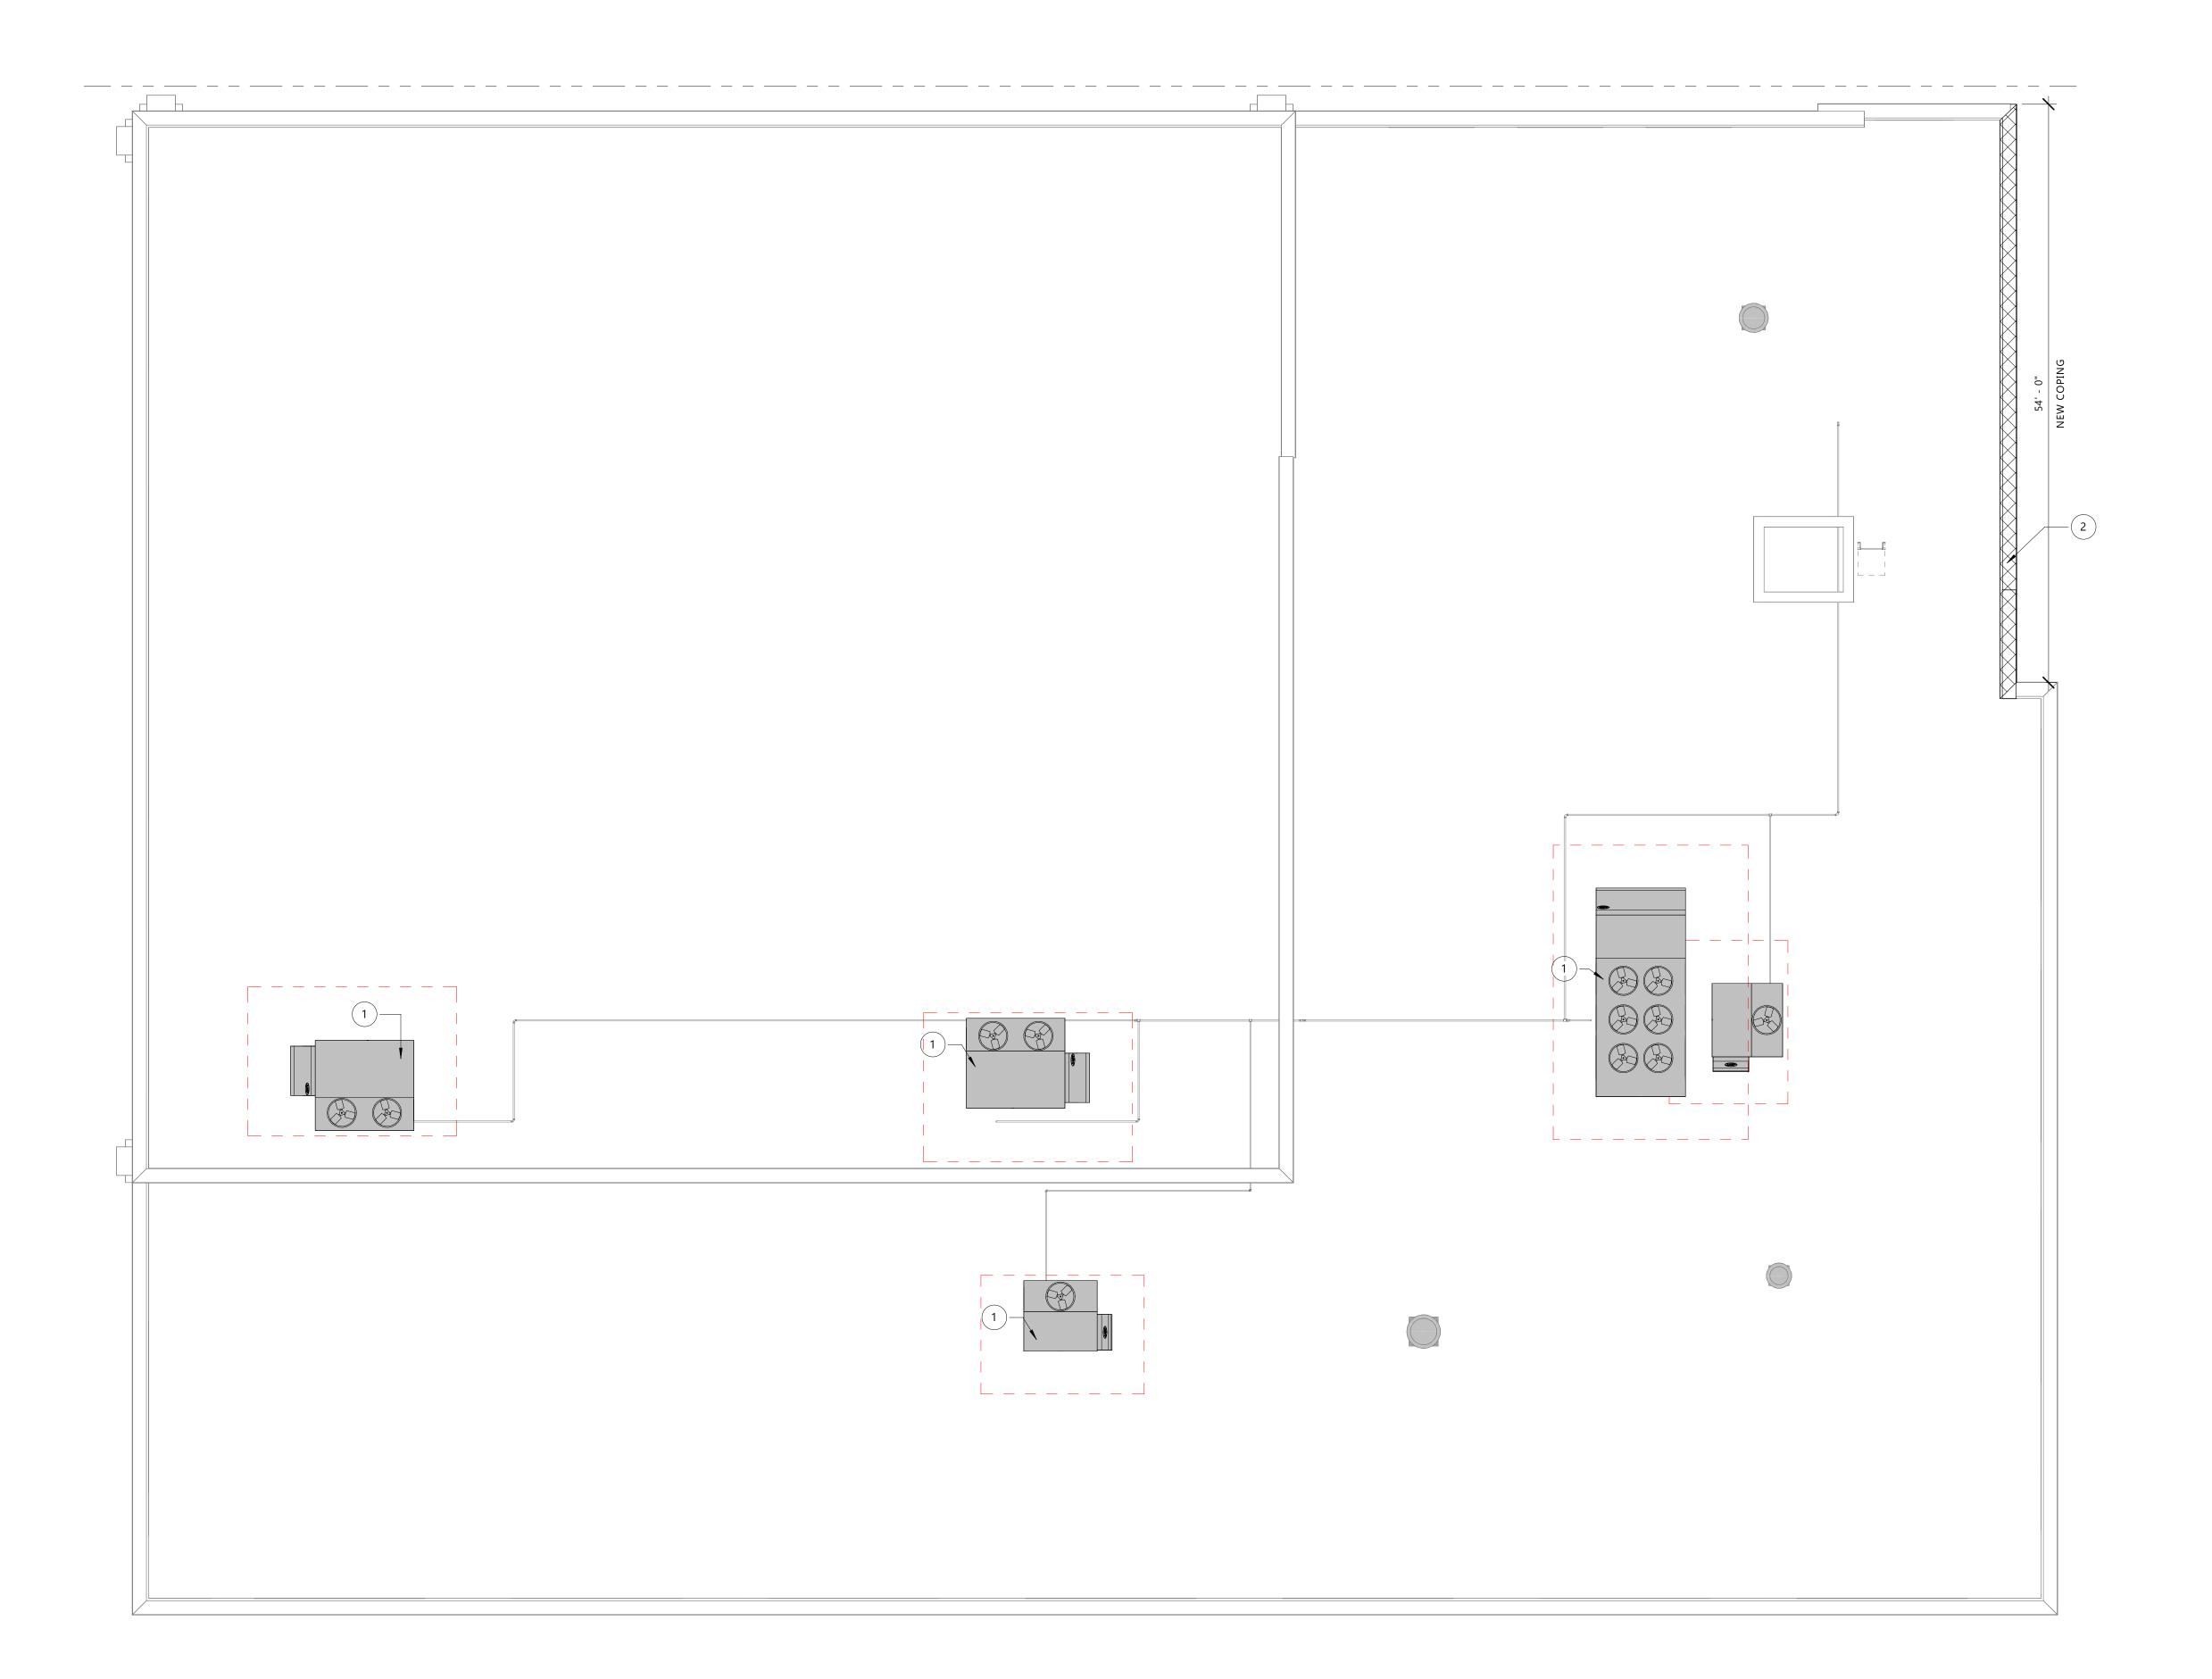

ROOF PLAN GENERAL NOTES:

- A. CONTRACTOR SHALL COORDINATE ROOFING INSTALLATION WITH MECHANICAL & PLUMBING DRAWINGS. PROVIDE CURBING AND FLASHING AS REQUIRED AT ROOF PENETRATIONS TO MAINTAIN INTEGRITY OF ROOF MEMBRANE.
- B. ALL GRAVEL STOPS AND COPINGS TO HAVE CONTINUOUS HOLD-DOWN CLIPS.
- C. PROVIDE TAPERED EDGE STRIPS AS NECESSARY AT ROOF EDGES.
- D. ALL ROOF PENETRATIONS AND EQUIPMENT CURBS TO BE FLASHED PER MANUFACTURER'S REQUIREMENTS.
- E. PROVIDE APPROVED TRANSITIONS BETWEEN EXISTING ROOFING AND NEW ROOFING TO MAINTAIN EXISTING ROOF WARRANTY.



N58 W6181 COLUMBIA RD. P.O. BOX 332 CEDARBURG, WISCONSIN 53012

PH. (262) 377-8001 FX. (262) 377-8003

KEYED ROOF PLAN NOTES

1 REPLACEMENT MECHANICAL EQUIPMENT. SEE MECHANICAL FOR ADDITIONAL

2 REMOVE EXISTING COPING AND REPLACE WITH NEW PREFINISHED METAL COPING. COORDINATE W/ NEW CONSTRUCTION.

PROJE

WEST ALLIS-WEST MILWAUKEE RECREATION DEPARTMENT -LANE PHASE 01

1300 S 109th St West Allis, WI 53214

ISSU

NO. REV. DATE DESCRIPTION

PROJECT INFO

Date 2024-03-08


Project No.

SHEET TITLE

ROOF PLAN

- 4 - -

A103

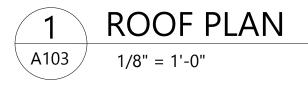



KEYED EXTERIOR ELEVATIONS

TAG # DESCRIPTION

NEW EXTERIOR WALL. MATCH EXISTING BRICK

PREFINISHED ALUMINUM COPING/GRAVEL STOP PAINTED TO MATCH EXISTING COPING. SEE SECTIONS AND DETAILS FOR ADDITIONAL INFORMATION

INSULATED HOLLOW METAL DOOR. SEE DOOR SCHEDULE FOR ADDITIONAL INFORMATION NEW EXTERIOR WALL INFILL. MATCH EXISTING BRICK

PAINT EXISTING STANDING SEAM METAL ROOF CANOPIES AND FASCIA, COLOR: BLUE TO MATCH EXISTING FACILITY; CLEAN AND PREP CANOPIES AS NECESSARY TO RECEIVE NEW



N58 W6181 COLUMBIA RD. P.O. BOX 332 CEDARBURG, WISCONSIN 53012

PH. (262) 377-8001 FX. (262) 377-8003

WEST ALLIS-WEST MILWAUKEE RECREATION DEPARTMENT -LANE PHASE 01

1300 S 109th St West Allis, WI 53214

NO. REV. DATE DESCRIPTION

PROJECT INFO

2024-03-08

Project No.

SHEET TITLE

BUILDING ELEVATIONS

A201

Sanitary Sewer Requirements - Chapter 2 MMSD Will a private interceptor main sewer serving two or more buildings be installed? If yes, MMSD Chapter 2 requires MMSD approval of new private interceptor main sewers. Details and plans for new private interceptor main sewers shall be submitted to the City of West Allis Department of Building Inspection and Neighborhood Services for initial assessment for compliance to local ordinances and MMSD requirements. Changes and/or corrections if needed to be addressed as needed. Plans then submitted to MMSD for final approval by the City of West Allis. If a sewer line will be crossing property lines, additional easements and/or ownership investigation may be required. Is the land use/zoning changing or residential density changing? If yes, flow allocations from MMSD will be required. Flow allocation worksheets are completed & submitted by the engineering department - additional information will be needed from the developer. **Water Services** Will any new water services create a "looped" system and tie back into City of West Allis water mains? If yes, check valves will be required per NR 811.68(3) if water main is to be privately owned. If yes and no check valves are installed, water main will be considered public and will require additional approvals and fees. Easements will be required along with City of West Allis Engineering Department and State of Wisconsin DNR approvals and inspections. All tapping of City of West Allis water mains shall be done by City of West Allis Water Department. Fees are determined by size of main and new water service. **Plumbing Plan Reviews** Does the new building(s) have a total of 10 or more interior and exterior plumbing fixtures** and/or over 1 acre of storm water drainage system? In no, no plan reviewed required. If yes, plumbing plan review by the City of West Allis as an agent municipality of the State of Wisconsin will be required to review the plumbing system for compliance to state and local plumbing codes. Fees are determined by size and scope of plans. Contact City of West Allis Building Inspection and Neighborhood Services Plumbing Division for more information on plumbing plan reviews. Plan review application available at the Department of Building Inspection and Neighborhood Services or at www.westalliswi.gov/BINS. Approximate time required for plumbing review is 10 business days. **Fixtures include: Catch Basins/Inlets, Manholes Floor Drains, Roof Drains, Hosebibbs Sinks, Water Closets, Urinals, etc. Plumbing Appliances (Dishwasher, etc.) Grease Interceptors Cross Connection Control Devices **Other Fees** Right of way excavation permit & driveway permits. Required if any excavating is done in City Right of Way (sidewalks, roads, alleys, etc.). County or State permits may also be required depending on roadway being excavated. Please see

Last Revised 8-1-2023 Page 2 of 7

https://www.westalliswi.gov/727/Engineering-Permits-Applications

Required if any City trees need to be removed.

Required if any City light poles need to be moved.

Forestry Department.

Electrical Department.

Appendix A

MMSD Green Infrastructure Plan Requirements

- What is it:

A simple sustainable way to capture, control and store rainwater and melting snow.

How:

 Install green infrastructure including: rain barrels, rain gardens, trees, porous pavers, green roofs, cisterns, bio swales, etc.

Requirements:

If between 5,000 square feet and ½ acre (21,780 square feet) are added, the amount of rainfall that equals ½" of rain across the impervious area must be held on-site using green infrastructure.

Example: If 5,000 square feet of impervious area is added, 1,559 gallons of Green Infrastructure (G.I.) capacity will be required.

Process:

A G.I. plan describing runoff management shall be submitted to City of West Allis Department of Building Inspection and Neighborhood Services for initial assessment. City of West Allis will forward plans to MMSD for final approval. MMSD and the Fresh Coast Resource Center are available to further walk you through the process and help with any green infrastructure sizing and placement needs.

GI plans:

- The elements of a complete sewer plan submittal:
 - A description of the project with dimensions for the net new impervious surfaces
 - A description of the proposed GI with dimensions
 - One or more drawings that show the location of the new impervious surfaces and the proposed GI
 - Calculations showing the volume of the proposed GI is equal to or greater than the required detention volume.
 - Maintenance plan

Fees/Time:

 Fees will be determined by size and scope of G.I. plan. Approximate time for MMSD final approval is 3 – 4 weeks.

Resources:

MMSD's Guide:

<u>HOW TO CREATE & SUBMIT A GREEN INFRASTRUCTURE PLAN</u> or visit https://www.mmsd.com/government-business/rules-regulations/rules and look for this document under Chapter 13

 Fresh Coast Guardian Site: www.freshcoastguardians.com

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Appendix B

MMSD Storm Water Management Plan Requirements

- What is it:

 A detailed plan developed by an engineer describing how storm water will be controlled, managed and how sediment will be captured along with the maintenance of the system using a series of engineering formulas. Required information needed is included in Appendix C, MMSD's submittal checklist. Engineer shall also complete MMSD's Chapter 13 Cover Checklist (Excel file) available at https://www.mmsd.com/government-business/rules-regulations/rules, under Chapter 13, or download Chapter 13 SWMP Worksheet.

Process:

The completed storm water management plan (SWMP) and construction plan set with all of MMSD's required information and engineering data shall be submitted to the City of West Allis Department of Building Inspection and Neighborhood Services for initial assessment of compliance to local ordinances and state plumbing codes. Upon initial assessment, plans will be forwarded to AECOM for final assessment of MMSD's requirements. If changes/corrections are needed, a revised SWMP will be submitted. Once SWMP has been approved by the City & AECOM, completed SWMP and construction plans will be forwarded to MMSD by AECOM on behalf of the City for final MMSD approval.

Fees/Time:

 City of West Allis assessment fees will be determined by size and scope of plan. Approximate time from plan submittal to final MMSD approval is 3 – 4 weeks.

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Appendix C

MMSD Chapter 13 Surface Water and Storm Water Reviews Storm Water Management Plan Submittal Checklist

Municipality:	Date submitted:	
Name of contact person:	Telephone number:	
Project name:	·	
New submittal		
Resubmittal #:		

The following items must be provided in a Storm Water Management Plan (SMP) to be considered a complete submittal and initiate the District's Chapter 13 review process:

- 1. Municipality cover letter stating that the SWMP has been reviewed and approved
- 2. Chapter 13 cover sheet (Excel file) available at: https://www.mmsd.com/government-business/rules-regulations/rules (under Chapter 13) or download Chapter 13 SWMP Worksheet.
- 3. Narrative that includes:
 - a. Project description
 - b. Project address
 - c. Procedure used to meet Chapter 13
 - Table listing pre- and post-development or redevelopment runoff volumes or runoff release rates
 - e. Local ordinance requirements or off-site drainage constraints that may be more restrictive than District's Rules
 - f. Storm water management facility description
 - g. Site maps that show:
 - i. Boundary of the drainage area tributary to the project site
 - ii. General roads, pedestrian ways, access to site, adjacent land uses, existing man-made structures, and public facilities
 - iii. Existing and proposed contours at a minimum of 2-foot intervals, extending a minimum of 200 feet beyond the limits of the proposed development and flow path for each subbasin
 - iv. Streams, lakes, ponds, existing drainage swales, floodplains, wetlands, natural storage, and other physical features within or adjacent to the project area
 - v. Locations of existing and proposed utilities, sewers, and water lines
 - vi. Areas to be cut or filled
 - vii. Proposed area of any construction or demolition activity that disturbs native soil or the soil under a base course or subbase course
 - viii. Locations of proposed buildings, roads, parking areas, and other permanent structures
- 4. Modeling that includes:
 - a. Hydrologic and hydraulic design calculations including all assumptions and criteria for the existing and post-development conditions for the design storms
 - b. Maximum depth and elevation, design, volume, peak outflow for the 50% and 1% probability (2- and 100-year) storm events, area, and time to drain (based on hydrograph routing computations)
 - c. For volumetric design procedure calculations, existing and post-development hydrographs, critical time period and existing and post-development out- flow volumes for the 50% and 1% probability (2- and 100-year) storm events during the critical time period
 - d. For multi-site facilities, analysis of ultimate development in the tributary watershed, consideration of multiple phases of construction, use of the volumetric procedure, identification of required drainage improvements between the developments or redevelopments of the multi-site facility, and effective conveyance to multiple storage facilities
- 5. Operation, maintenance, and inspection plan
- 6. Existing and proposed conveyance system including:
 - a. Design drawings and details for all conveyance facilities
 - b. System inlet details
 - c. Outlet and outfall designs and details
 - d. Hydraulic grade line calculations and plots developed in the design of the storm water facilities
 - e. Calculations of outlet conditions at site discharge point

Last Revised 8-1-2023 Page 5 of 7



STAFF REPORT WEST ALLIS PLAN COMMISSION Wednesday, March 27, 2024 Common Council Chambers 6:00 PM

Watch: https://www.youtube.com/user/westalliscitychannel

- 3A. Conditional Use Permit for Tsunami Express Carwash, a proposed Car Wash with accessory drive-through service, located at 10928 W. Oklahoma Ave.
- 3B. Site, Landscaping, and Architectural Design Review for Tsunami Express Carwash, a proposed Car Wash with accessory drive-through service, located at 10928 W. Oklahoma Ave. (Tax Key No. 520-0151-001

Overview and Zoning

A 5,000 square foot car wash is proposed to be constructed on the site currently operated by Incredi-Roll Skate & Family Fun Center at 10928 W. Oklahoma Ave. (Plan set link).

Tsunami Express Carwash hours of operation are from 7am to 8pm daily and

employ about 8-10. The car wash will have 2-3 employees on site.



The property is zoned C-4. <u>Car Wash Service</u> uses require a conditional use permit. Additional conditional use criteria states that no conditional use permit may be issued unless no lot zoned for residential purposes is located adjacent to the lot. All adjacent lots are zoned commercial and do not conflict with the conditional use criteria (the nearest residential development/Windsong is about 300-ft away). Accessory drive-through service also requires a conditional use permit.




Site Plan

The property is currently owned/utilized by <u>Incredi-Roll</u> which is a recreational/entertainment use within the Hwy 100 corridor (a major north-south corridor through the city spanning 3.5 miles). The existing


building is proposed for demolition and will be replaced by a single-story building for the proposed car wash. The site is proposed to have access from W. Oklahoma Ave. from two curb cuts on the southwest and southeast corners of the site. Both curb cuts lead directly into a parking lot for the car wash. Extending from the east edge of the parking lot are two lanes. The southern lane wraps around the site going directly north of the proposed building, leading to three separate lanes for a payment kiosk under a canopy. The three lanes merge into one again and then lead into the car wash or back to the parking lot. The drive aisle continues through the building and eventually exits into the eastern portion of the parking lot.

The parking lot shows a total of 31 parking stalls. For Conditional Uses the maximum number of parking stalls permitted is determined by the Conditional Use Permit. Staff recommends reduction of parking stalls to align with our zoning code parking maximum intentions (service uses). A refuse area with an enclosure is shown on the northwest corner of the parking lot. A vacuum pump house is also proposed in the parking lot on the southwest corner.

To conform with Design Review Guidelines staff is recommending site changes. Design Review Guidelines call for locating vehicle parking areas away from the public sidewalk while strategically buffering from the public realm. Staff recommends that the proposed car wash building is moved closer to the south property line and the parking lot & drive aisles are oriented towards the rear of the property. In this proposal the parking lot and drive-through lanes would be buffered from the public realm. Additionally, to increase traffic safety Engineering and Planning recommend removal of two curb cuts along W. Oklahoma Ave. Vehicles would instead utilize an existing access point directly west of the parcel. This would require coordination with the adjacent property owner for a cross access easement. Staff has provided this alternative to Milwaukee County and is awaiting feedback. Staff will continue to work with the applicants on any site changes.

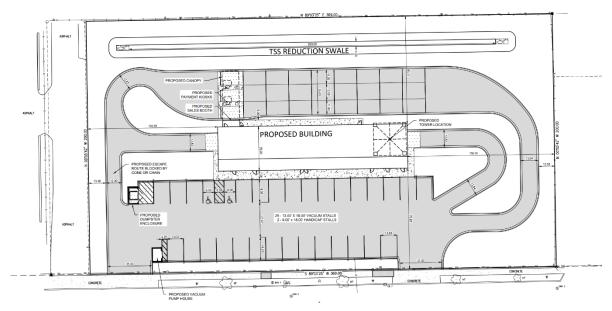


Submitted Site Plan

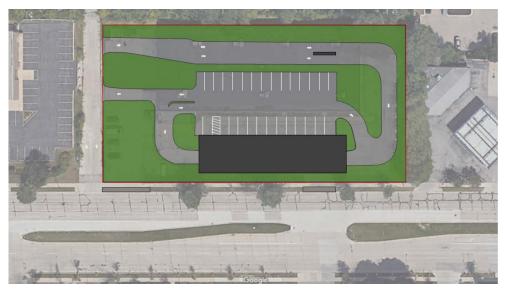

Recommended site changes example

Landscaping Plan

The property is bound by landscaping on all sides. Along the southern property line is a variety of deciduous shrubs and ornamental trees. The western edge of the property shows a mix of trees. This

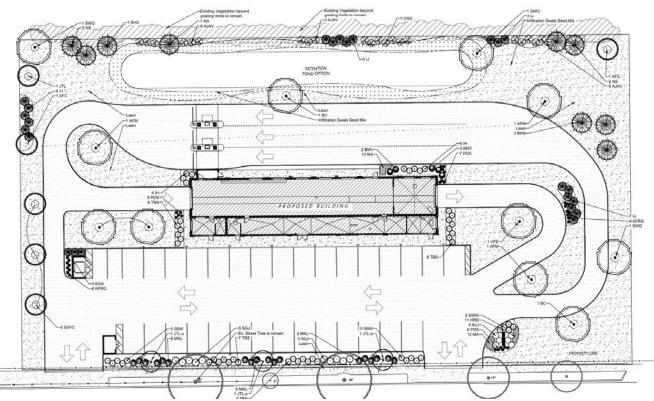

continues to the northern edge of the property with a mix of shrubs as well. An optional retention pond is also shown on the northern portion of the site. A mix of trees continues along the eastern edge of the property. In between the drive through lanes are a mix of trees and shrubs. Landscaping is shown along the building with a mix of perennials and shrubs. Additional landscaping is also shown around a proposed freestanding sign and the trash enclosure. The use of weigelia is not recommended by staff. Site plan


changes may alter the proposed landscape plan that was submitted by the applicant. Any changes to the site will require technical review and approval by staff.

Architectural Plan

The proposed building is comprised of brick veneer, cast stone, split face CMU, and EIFS for the exterior elevations. EIFS is not a permitted exterior material (Design Guidelines). Higher quality material will be needed to replace the EIFS on the building. The south, street facing façade is made up primarily of masonry and split face CMU. Multiple windows align the south façade along with 4 doors. Staff recommends increased glazing along windows and doors for enhanced visual appeal. The west façade shows a mix of masonry and precast stone. A garage door is shown along with two windows. The west elevation also shows the the canopy for the payment kiosks. This consists of masonry pillars covered with an aluminum canopy. The north façade is similar to the south façade with a mix of masonry and split face CMU. The east façade appears similar to the west façade with a garage door encased by precast stone. Masonry is also utilized and is used to form a gabled roof. The pump house is shown to be constructed with split face CMU. The roof is comprised of a mix of concrete planks, steel bar joists and steel trusses colored blue.





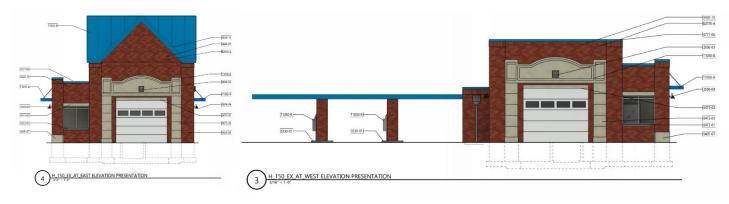

Recommendation: Hold action. With the writing of this report, staff still has some significant concerns and has not had adequate communications with some of the newer project leads from the Tsunami team, and is also awaiting feedback from Milwaukee Co.

Staff shared the following points for review that should at minimum be incorporated into future discussions and plan changes. As part of the Conditional Use Permit and Site, Landscaping, and Architectural Design Review for Tsunami Express Carwash, a proposed Car Wash with accessory drivethrough service, at 10928 W. Oklahoma Ave. (Tax Key No. 520-0151-001):

- 1. A revised Site, Landscaping, and Architectural Plan being submitted to the Planning office to show the following: (a) Site plan showing recommended site access and building location changes per Engineering and Planning; (b) EIFS is not a permitted exterior material. Higher quality material will be needed to replace the EIFS on the building; (c) The south, street facing façade is made up primarily of masonry and split face CMU. Multiple windows align the south façade along with 4 doors. Staff recommends increased glazing along windows and doors for enhanced visual appeal; (d) Landscaping plan showing replacement of weigela and additional landscaping per City Forester recommendation; (e) incorporating vacuum pump house into main building envelope or closer in proximity to main building and away from drive entrances; (e) projected decibel level readings being shared with staff and in consideration with surrounding uses; (f) curb being installed along the west exterior perimeter of the property. Contact Steve Schaer, Manager of Planning and Zoning at 414-302-8466.
- A <u>Street excavation permit</u> being applied for in OpenGov prior to work beginning. Any concrete work in the right of way needs to be completed by a licensed and pre-qualified contractor within the City of West Allis. Contact Greg Bartelme at (414) 302-8367.
 W. Oklahoma Ave. (CTH NN) being a County Highway and subject to County permit (plans have been shared with Milw. Co.).
- Documentation and approval showing compliance with the City of West Allis Storm water Management Ordinance, to be submitted to the Building Inspections and Neighborhood Services Department by a registered Civil Engineer. A storm water permit must be obtained from the City.
- 4. Signage plans being reviewed for compliance and subject to permitting.



STAFF REPORT WEST ALLIS PLAN COMMISSION Wednesday, March 27, 2024 Common Council Chambers 6:00 PM

Watch: https://www.youtube.com/user/westalliscitychannel

- 4A. Conditional Use Permit for The Salon Suites, a proposed Beauty, Wellness, and Massage Therapy use located at 11575 W. Theo Trecker Way.
- 4B. Site, Landscaping, and Architectural amendment for The Salon Suites, a proposed Beauty, Wellness, and Massage Therapy use located at 11575 W. Theo Trecker Way (Tax Key No. 445-0756-001).

Overview and Zoning

The property is zoned I-1, light industrial and "The Suites" is a real estate acquisition company specializing in providing salon suites to professionals in the beauty and wellness industry. While primary tenants consist of hair professionals, ethicians, and cosmetologists, they also frequently accommodate massage therapists within our premises, as it is a common practice for them to rent salon suites.



Salon Suites will offer about 40 leasable (100-150-sf) work areas within the two-floor, 12,500-sf building. Approximately 10-15% of the tenant spaces may be leased to massage therapy businesses. The building will be remodeled to offer common area amenities for the public (lobby & corridors to access suites), and a breakroom for tenants. While most leasable space within the building will be permitted "neighborhood services" (like aesthetician, hair, beauty, nails), the city zoning code requires some additional review of "massage therapy" uses require a conditional use.





Rather than requiring a conditional use public hearing each time a new small business leases a suite, staff's recommending one conditional use permit to function universally to cover future massage therapy business operations on site. The property owner and their tenants will be required to acknowledge and abide by the criteria to meet the terms of the conditional use permit. Conditional uses may be terminated or limited in term. Staff offers some common considerations that could be applied to the conditional use below to maintain integrity of the facility.

Property owner and Massage therapy businesses on site shall:


- 1. State of WI licensed operation.
- 2. Maintain customer appointment records.
- 3. All customers enter/exit through common/public areas.
- 4. 24/7 Video camera within common public access points.
- 5. Daytime Hours (not open before 7am or after 10pm).

What is conditional use? Conditional use is a type of use that is allowed upon meeting all conditions specified in the code and those imposed by the common council. Conditional uses are required to go before the City Plan Commission for consideration of proposed operations and a site, landscaping, and architectural design review. Plan Commission's decision is referred to the Common Council for public hearing. The timing of the conditional use process is 45-60 days. For instance, this application was submitted in early March, staff conducted a technical review over a period of three weeks, shared feedback/recommendation with the applicant, and published a staff report w/ recommendation to the Plan Commission on March 27. A public hearing before the City Council to be conducted in April. A class 2 notice is required by State Statutes in advance of the public hearing. For more info refer to the Planning and Zoning web.

Site, Landscaping, and Architectural Plans


The majority of improvements to the existing building will be interior updates and floor plan changes (carpentry, plumbing, HVAC, and electrical) to deliver white-box readied spaces (stubbed in plumbing, electrical, HVAC) where tenants may then install their countertops and sinks. Tenant fixture installations would require a plumbing permit.

The Plan Commission's role is more concerned with any planned exterior site changes, or exterior building alterations. The only significant exterior improvement that may be installed is a new ADA ramp on the north side of the building. The rear entrance is already ADA accessible and the building features an elevator, so the north ramp may not be installed.

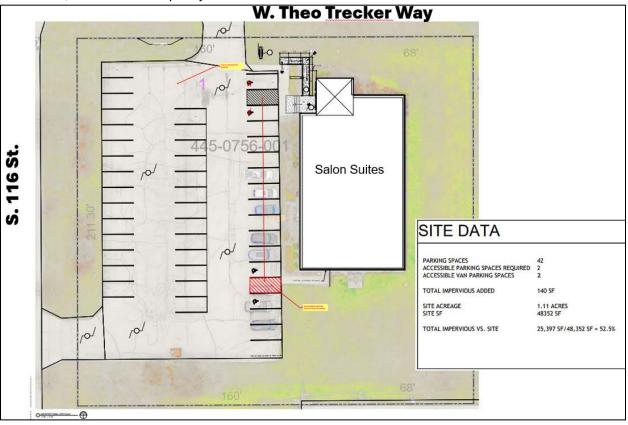

Recommendation: Common Council approval of the Conditional Use Permit and Site, Landscaping, and Architectural amendment for The Salon Suites, a proposed Beauty, Wellness, and Massage Therapy use located at 11575 W. Theo Trecker Way (Tax Key No. 445-0756-001), subject to the following conditions:

- 1. Common Council approval of the Conditional use permit with the following universal criteria for massage therapy:
 - a. State of WI licensed operation.
 - b. Maintain customer appointment records.
 - c. All customers enter/exit through common/public areas.
 - d. 24/7 Video camera within common public access points.
 - e. Daytime Hours (not open before 7am or after 10pm).
- 2. A revised Site and Architectural Plan being submitted to the Department of Development to show the following: (a) confirmation on plans of north ramp being installed or not; (b) refuse location and 4-sided screening details being shown on site plan. Contact Steve Schaer, Manager of Planning and Zoning at 414-302-8466.
- 3. Signage and lighting plans subject to Planning design review and permitting.

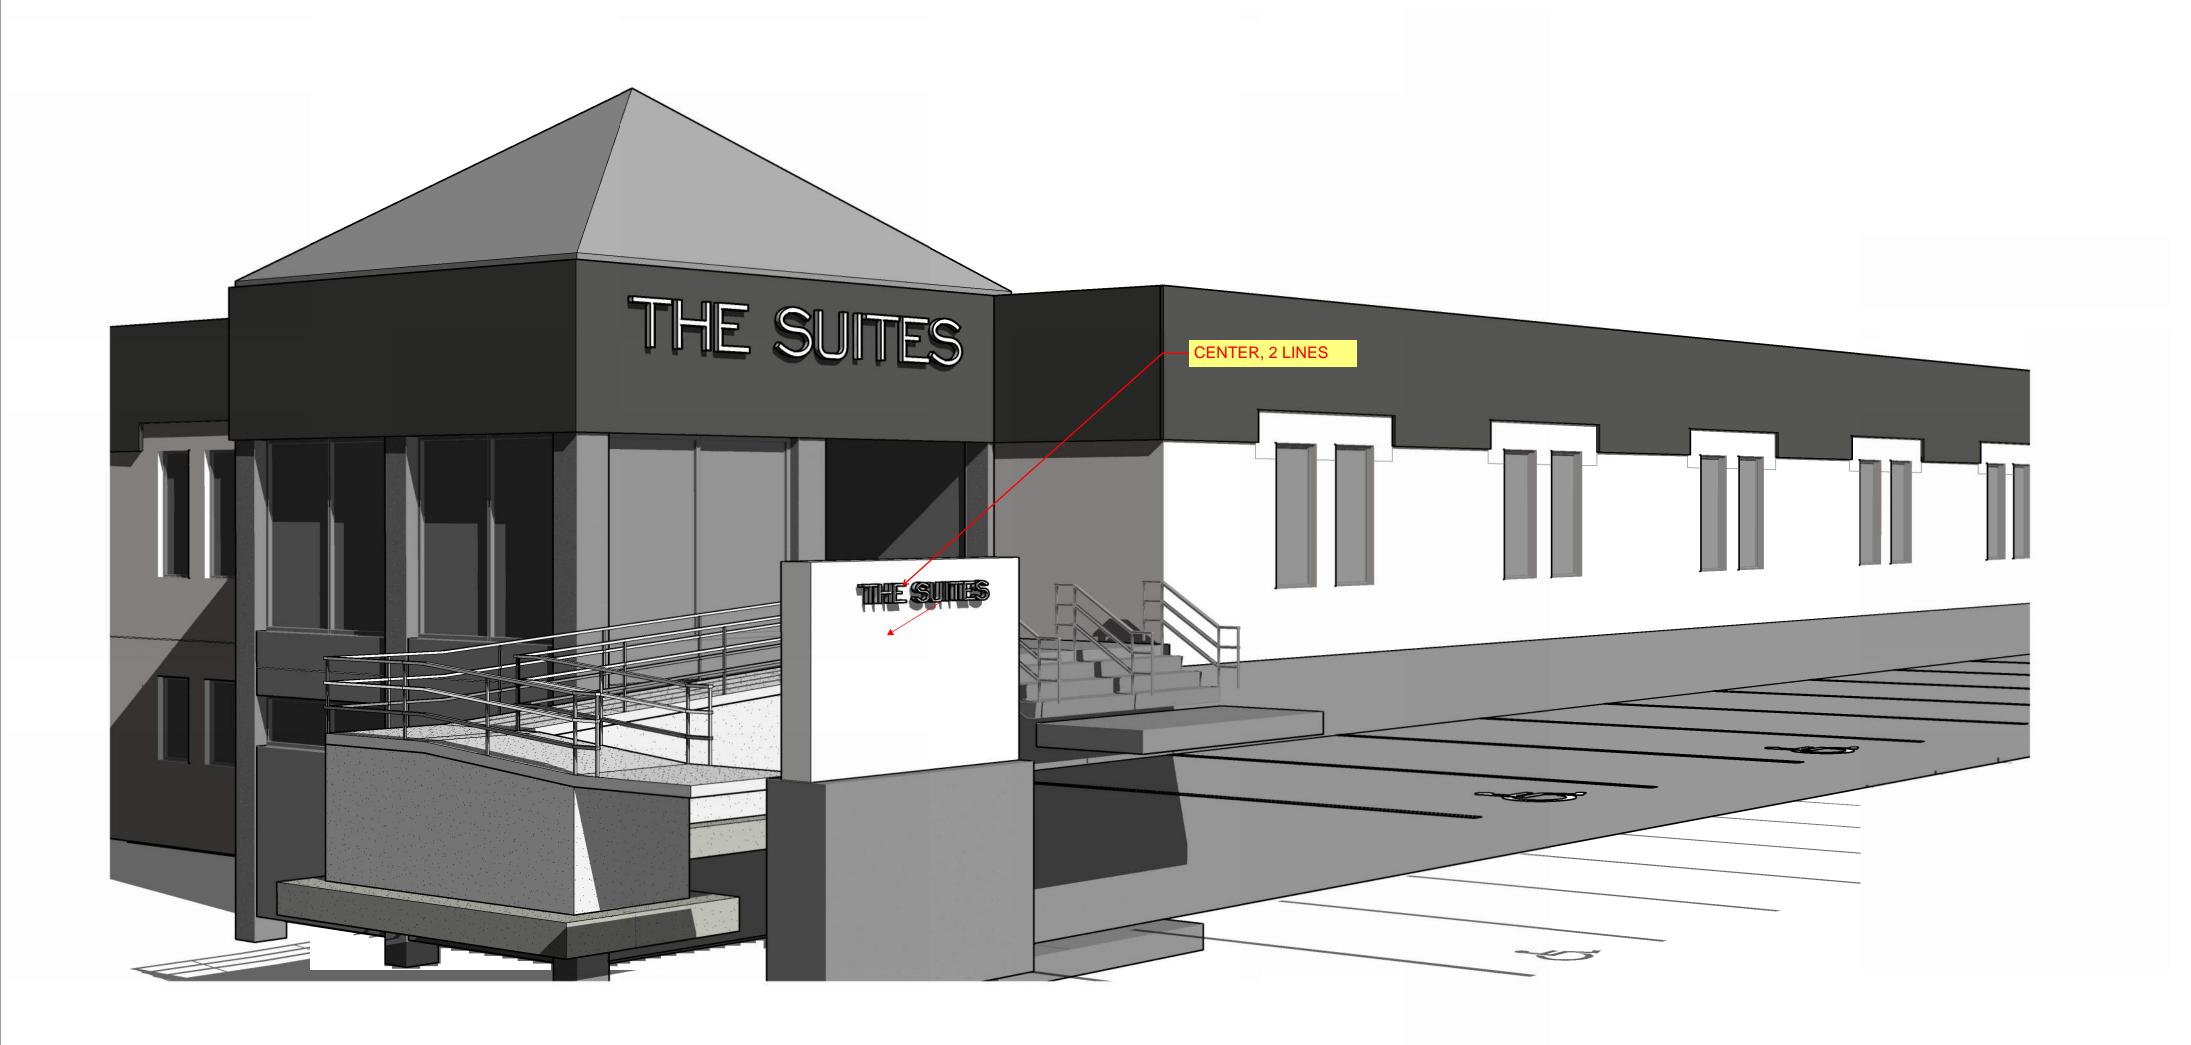

THE SUITES IV

11575 W. THEO TREKKER WAY WEST ALLIS, WI

PROJECT TEAM

TREDO GROUP LLC

8425 N. PORT WASHINGTON DRIVE FOX POINT, WI 53217 PHONE (414) 254-0498

DIRECT PHONE: EMAIL ADDRESS: Jeff Tredo, AIA (414) 254-0498



03/12/2024 PROJECT NUMBER:

24008

© Tredo Group,

219 NORTH MILWAUKEE STREET SUITE 630 MILWAUKEE WISCONSIN 53202 (414) 254-0498

ARCHITECTURAL: TREDO GROUP LLC

8425 N. PORT WASHINGTON DRIVE Fox Point, WI 53217 PHONE (414) 254-0498 www.tredogroup.com

PROJECT CONTACT: **EMAIL ADDRESS:**

Jeff Tredo , Architect jeff.tredo@tredogroup.com

TREDOGROUP.COM

THE SUITES IV

11575 W. THEO TREKKER WAY WEST ALLIS, WI

03/12/2024

GENERAL BUILDING DATA SHEET INDEX ARCHITECTURAL LIFE SAFETY PLANS ARCHITECTURAL A010 PARTITION TYPES ARCHITECTURAL SITE AS100 ARCHITECTURAL SITE PLAN ARCHITECTURAL **ELEVATIONS** ARCHITECTURAL DEMOLITION LL FLR DEMOLITION PLAN 1ST FLR DEMOLITION PLAN ARCHITECTURAL LL FLR PLAN LL FLR RCP INTERIOR & CASEWORK DETAILS MIKE M. TO LOOK INTO DISS. CREDIT — FOR RAMP SEPARATE APPLICATION THROUGH SITE LANDSCAPING, **ARCHITECTURAL** CONDITIONAL USE REVIEW. PERMIT HEARING 3/27/24 FOR MASSAGE THERAPIST 10-15% OF TENANTS, CITY

APPLICABLE CODES AND ZONING

2018 WISCONSIN COMMERCIAL BUILDING CODE (SPS 361-366) 2015 INTERNATIONAL EXISTING BUILDING CODE 2015 INTERNATIONAL BUILDING CODE ASSEMBLY OCCUPANCY, GROUP A-3 **BUSINESS OCCUPANCY, GROUP B**

ZONING: CITY OF WEST ALLIS

CONSTRUCTION CLASSIFICATION

RENOVATION TYPE OF CONSTRUCTION, IIIB

COMMON COUNCIL

SET CRITERIA. LOG

4/16/24, CITY TO

OF PEOPLE

45-60 DAYS.

COMING AND

GOING, CAMERAS

BUTTERFLY MX.

BUILDING AREA

LEVEL 3 ALTERATION 10,626 SF / 12,326 GSF = 83% AREA OF WORK

CODE ANALYSIS

ALTERATION LEVEL 3 (AREA OF WORK EXCEEDS 50% OF EXISTING BUILDING): CHAPTERS 7,8,9 IEBC

CURRENT OCCUPANCY - B. OFFICE USE GROUP

RROPOSED OCCUPANCY - B, NEIGHBORHOOD SERVICES

DETECTION DEVICE.

BUILDING.

1105/1.5 IBC - ONE ACCESSIBLE ENTRANCE PROVIDED FOR EACH TENANT. - 60% ALL ENTRANCES TO BE ACCESSIBLE

804.2.5 IEBC FIRE PROTECTION SYSTEMS - PROVIDE FIRE ALARM WITH REWIRED EXISTING SYSTEM

- APPROVED LOCAL ALARM SERVICE - PER NFPA 72 TIED TO OCCUPANT NOTIFICATION SYSTEM - BACKUP POWER PER NFPA 72 - SMOKE DETECTION IN FURNACE ROOM

- CONNECT ALL EXISTING FIRE ALARMS TOGETHER 904.2 IEBC - FIRE ALARM PROVIDE SHOP DRAWINGS ENTIRE DESIGN APPROVAL FIRE INSPECTOR CITY OF WEST ALLIS. PROVIDE FIRE ALARM MANUAL PULL IN CONSPICUOUS AREA TO INITIATE FIRE ALARM. - FIRE ALARM TIED TO FIRE DETECTION DEVICE-OR-WATER FLOW

- CORRIDORS & ECLOSURE FOR EXIT ACCESS STAIR - FSR-C - ROOMS AND ENCLOSED SPACES FSR-A ACCESSIBLE ROUTE - ACCESSIBLE ROUTE TO WORK AREA REQUIRED - ONE ACCESSIBLE ROUTE IN MULTISTORY BUILDING, EXCEPTION 1.2 - HEALTH CARE PROVIDER GROUP B NOT REQUIRED TO BE ON✓ ACCESSIBLE ROUTE. **ELECTRICAL** 808.3.1IEBC - (2) DUPLEX OUTLETS EACH TENANT, KITCHEN (2) DUPLEX OUTLETS

- RESILIENT FLOORING CLASS II, NFPA 253 COMPLIANT

- ALARM NOTIFICATION DEVICED TIED TO ONE ANOTHER

CORRIDORS AND WAITING LOBBIES.

CONSTANTLY MONITORED STATION.

APPLIANCES.

BOX ON DUCT.

MEANS OF EGRESS

LEVEL PER IBC.

INTERIOR FINISHES

804.4 IBC

BUILDING PER 903.3.3 IBC

1 OR 2 NFPA 701 COMPLIANT

BATTERY BACKUP.

AUTOMATIC SMOKE DETECTION DEVICES NOT REQUIRED IN

DUCT SMOKE DTECTORS @ DOWNSTREAM OF FIRST MAIN

PROVIDE SMOKE DETECTOR AT FIRE ALRAM CONTROL UNIT.

- 50' DEAD END CORRIDOR ALLOWED SPRINKLERED EXISTING

- INTERIOR EXIT/PASSAGE = FLAME SPREAD RATING FSR-C

- IONIZATION SMOKE ALARM MIN. 10' AWAY FROM COOKING

MECHANICAL & PLUMBING - 5 CFM/OCCUPANT OF OUTDOOR AIR & 15 CFM/OCCUPANT PER INDOOR AIR QUALITY PROCEDURE PER ASHRAE 62 OF VENTILATED AIR.

- PLUMBING FIXTURE INCREASE GREATER THAN 20%, RECALCULATE FIXTURE COUNT ENTIRE BUILDING. STRUCTURAL EVALUATION AND ANALYSIS

- EVALUATION REQUIRED WITH ALTERATION LEVEL 3 TO EXISTING BUILDING.

SITE LOCATION MAP

NOT FORSEEN AS

REQUIRED.



PROJECT NAME THE SUITES IV

WEST ALLIS, WI

11575 W. THEO TREKKER WAY

PROGRESS DOCUMENTS

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PROJECT NUMBER


24008 DATE

03/12/2024 SHEET TITLE INDEX

SHEET NUMBER


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OCCUPANT LOAD DATA: 73 OCC UPPER FLOOR OCCUPANT LOAD-LOWER LEVEL OCCUPANT LOAD-59 OCC 132 OCC TOTAL OCCUPANTS-66 OCC 66 OCC **FEMALE** PLUMBING FIXTURES CH. 29 WATER CLOSET MALE: 1/25 FIRST 50, 1/50 REMAINDER 2 REQUIRED, 4 PROVIDED WATER CLOSET **FE**MALE: 1/25 FIRST 50, 1/50 REMAINDER 2 REQUIRED, 4 PROVIDED LAVATORY MALE 1/40 FOR FIRST 80, 1/80 REMAINDER 2 REQUIRED, 4 PROVIDED LAVATORY FEMALE 1/40 FOR FIRST 80, 1/80 REMAINDER 2 REQUIRED, 4 PROVIDED DRINKING FOUNTAINS: 2 REQUIRED, 2 PROVIDED 1/100 SERVICE SINK: 1 REQUIRED, 1 PROVIDED SYMBOLS EXIT WITH (XX") FIRE EXTINGUISHER CABINET WITH (75' OF TRAVEL)

1 1ST FLOOR LIFE SAFETY PLAN 1/8" = 1'-0"

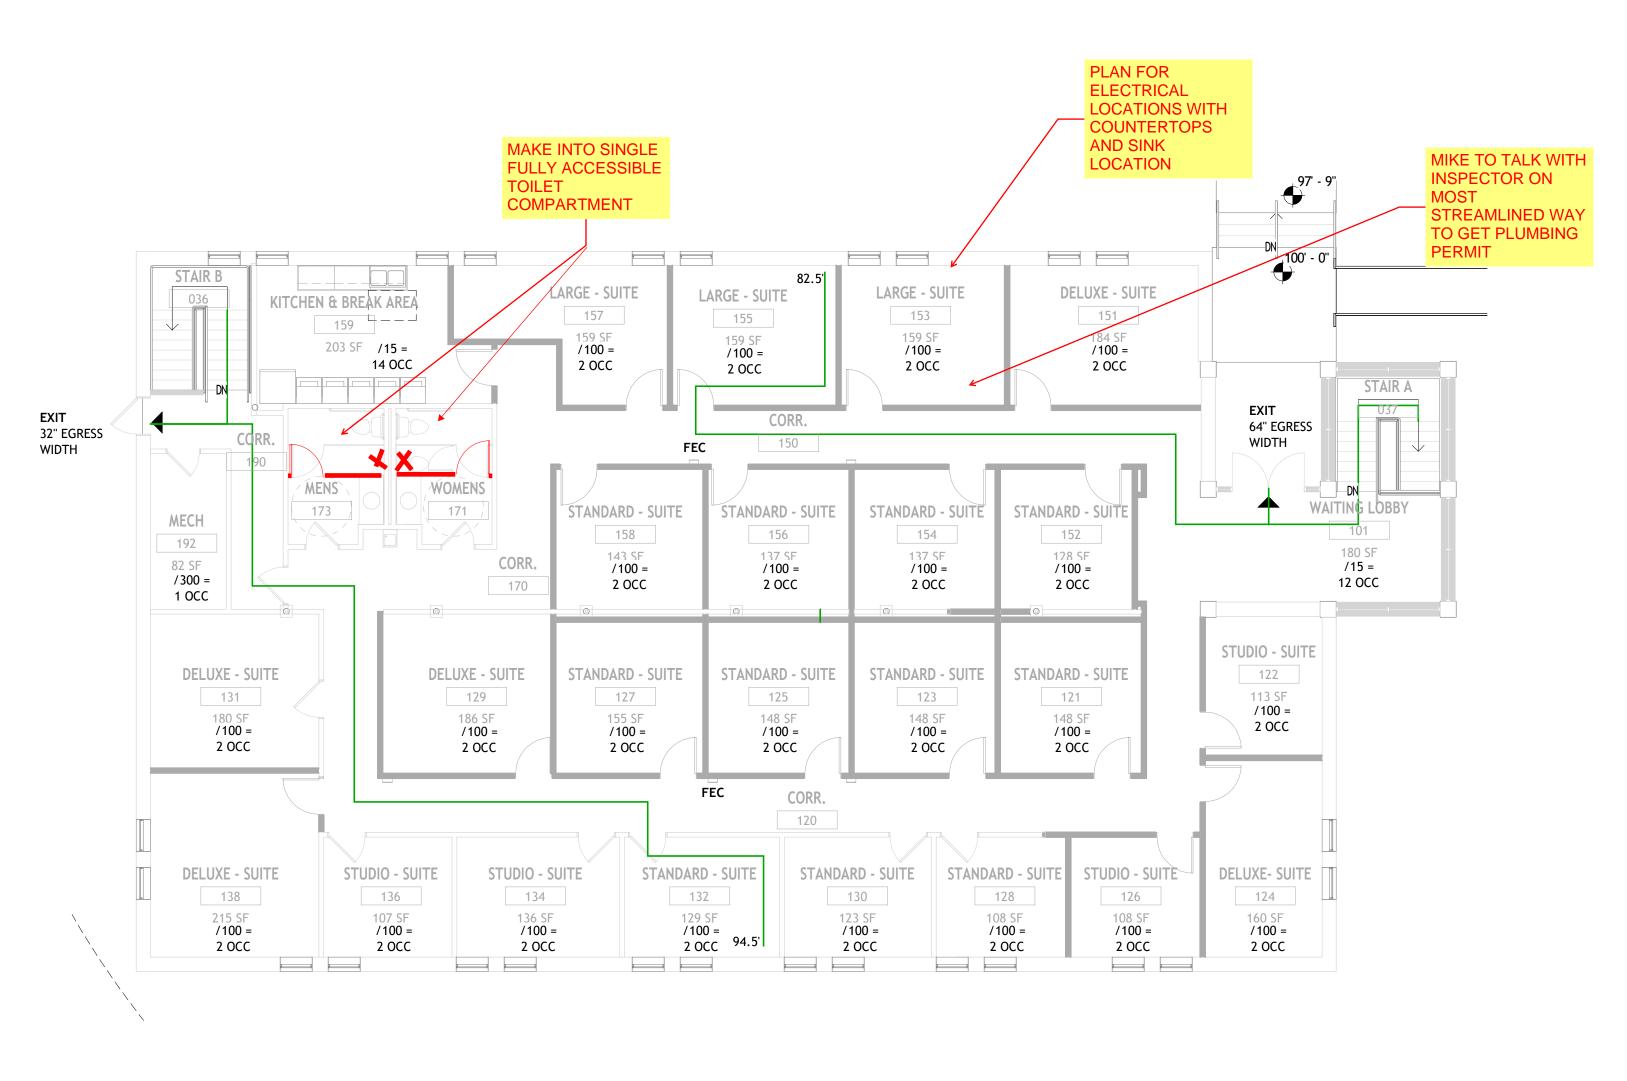

PROJECT NAME THE SUITES IV

11575 W. THEO TREKKER WEST ALLIS, WI
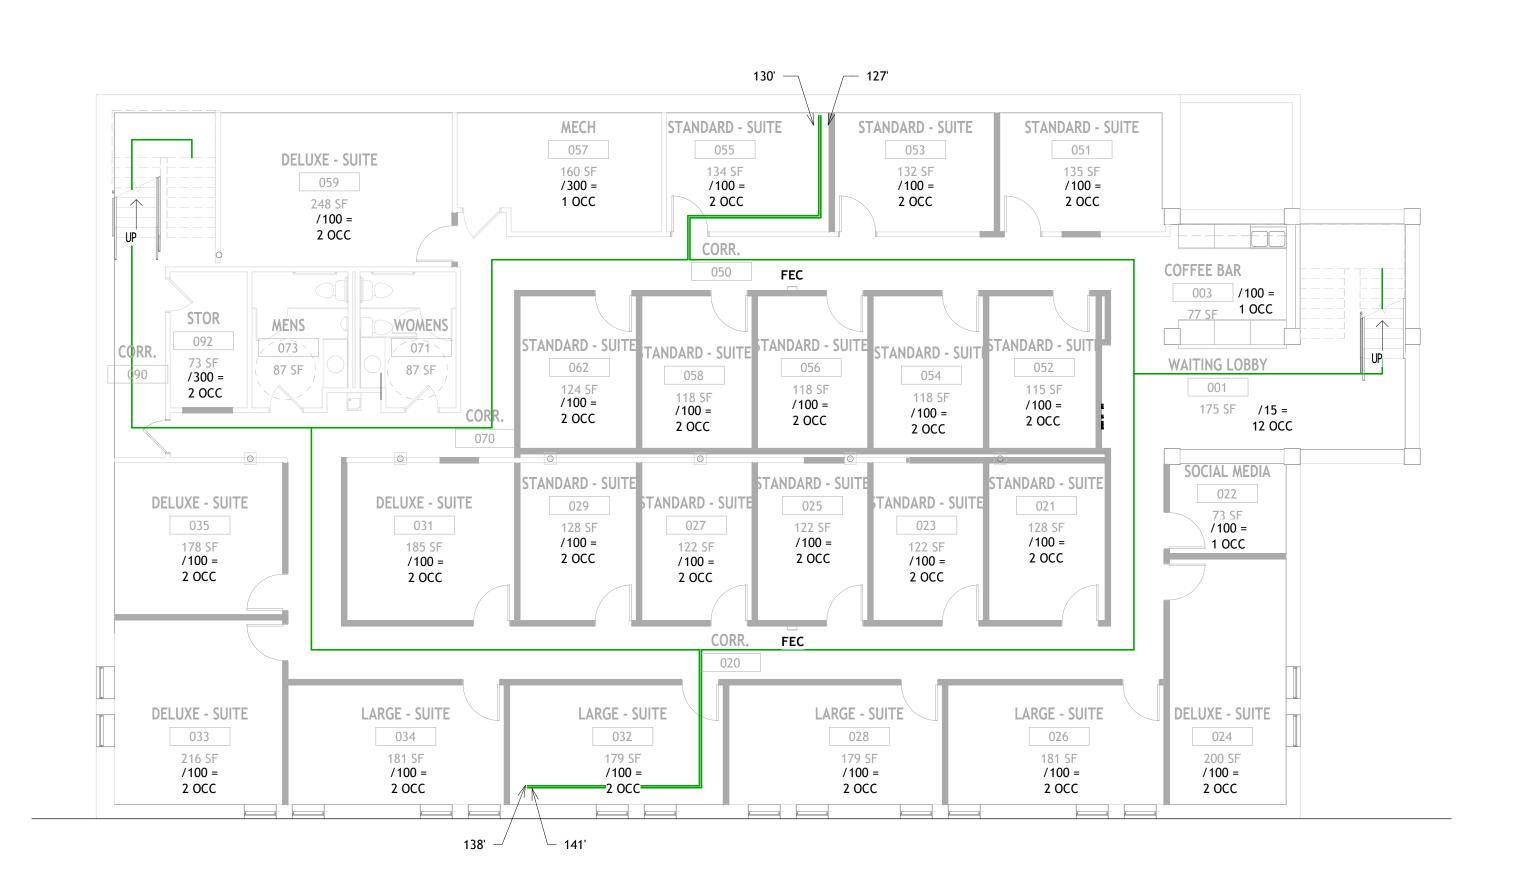
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PROJECT NUMBER

DATE

03/12/2024

SHEET TITLE

LIFE SAFETY PLANS

SHEET NUMBER

2 LOWER LEVEL LIFE SAFETY PLAN 1/8" = 1'-0"

G101 © Tredo Group, Ilc.



KEYNOTES - SITE PLAN

ACCESSIBLE 4" THICK CONCRETE RAMP, SIDEWALL POWDER COAT RAILING AT 36" AFF, BRUSHED FINISH,
ASPHALT CONTRACTOR TO ASSESS PARKING SURFACE, PROVIDE REPLACEMENT/ MILLING AND STRIPING AS SHOWN.

FILL IN ANY GAPS GREATER THAN 1/2" DIAMTER SPHERE IN CONCRETE THRESHOLDS/CONNECTIONS TO ALLOW FOR ACCESSIBLE ROUTE FROM PARKING LOT.

PROVIDE SIGNAGE BY OWNER ON EXISTING SIGNAGE LOCATION

GENERAL NOTES AND REMARKS

GENERAL NOTES
A.

REMARKS

1. SAMPLE REMARK

2. SAMPLE REMARK

SITE DATA

PARKING SPACES 42
ACCESSIBLE PARKING SPACES REQUIRED 2
ACCESSIBLE VAN PARKING SPACES 2

TOTAL IMPERVIOUS ADDED 140 SF

SITE ACREAGE 1.11 ACRES
SITE SF 48352 SF

TOTAL IMPERVIOUS VS. SITE 25,397 SF/48,352 SF = 52.5%

PROJECT NAME
THE SUITES IV

11575 W. THEO TREKKER WAY WEST ALLIS, WI

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DATE DESCRIPTION

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PROJECT NUMBER 24008

DATE 03/12/2024

SHEET TITLE
ARCHITECTURAL SITE
PLAN

SHEET NUMBER

AS100





PROJECT NAME THE SUITES IV

11575 W. THEO TREKKER WAY WEST ALLIS, WI

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24008

DATE 03/12/2024

ELEVATIONS

SHEET TITLE


SHEET NUMBER

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SHEET NOTES - DEMOLITION

- COORDINATE REMOVAL OF EXISTING CABINETS AND CASEWORK WITH <OWNER>. SALVAGE OR REMOVE AS DIRECTED.
- 2. COORDINATE REMOVAL OF EXISTING DOORS, FRAMES, AND HARDWARE WITH <OWNER>. SALVAGE OR REMOVE AS DIRECTED. REFER TO ROOM FINISH SCHEDULE TO IDENTIFY ALL AREAS BEING ALTERED
- INCLUDING ROOMS WHERE ALTERATIONS ARE LIMITED TO NEW FINISHES. AT ALL ALTERED LOCATIONS, REMOVE ALL INTERIOR AND WALL MOUNTED ITEMS. REMOVE ALL FINISHES AND RESIDUAL GLUE. PREPARE SURFACES FOR NEW FINISH APPLICATION.
- 4. SEE MEP PLANS (IF AVAILABLE) FOR ADDITIONAL DEMOLITION ITEMS AND NOTES. DESIGN / BUILD CONTRACTOR SHALL COORDINATE AND PERFORM WORK. 5. PATCH AND REPAIR FLOOR IN PREPARATION FOR NEW FLOORING WHERE WALLS
- HAVE BEEN REMOVED.
- 6. PATCH AND REPAIR CEILING GRID SYSTEM WHERE WALLS AND PARTITIONS HAVE BEEN REMOVED.



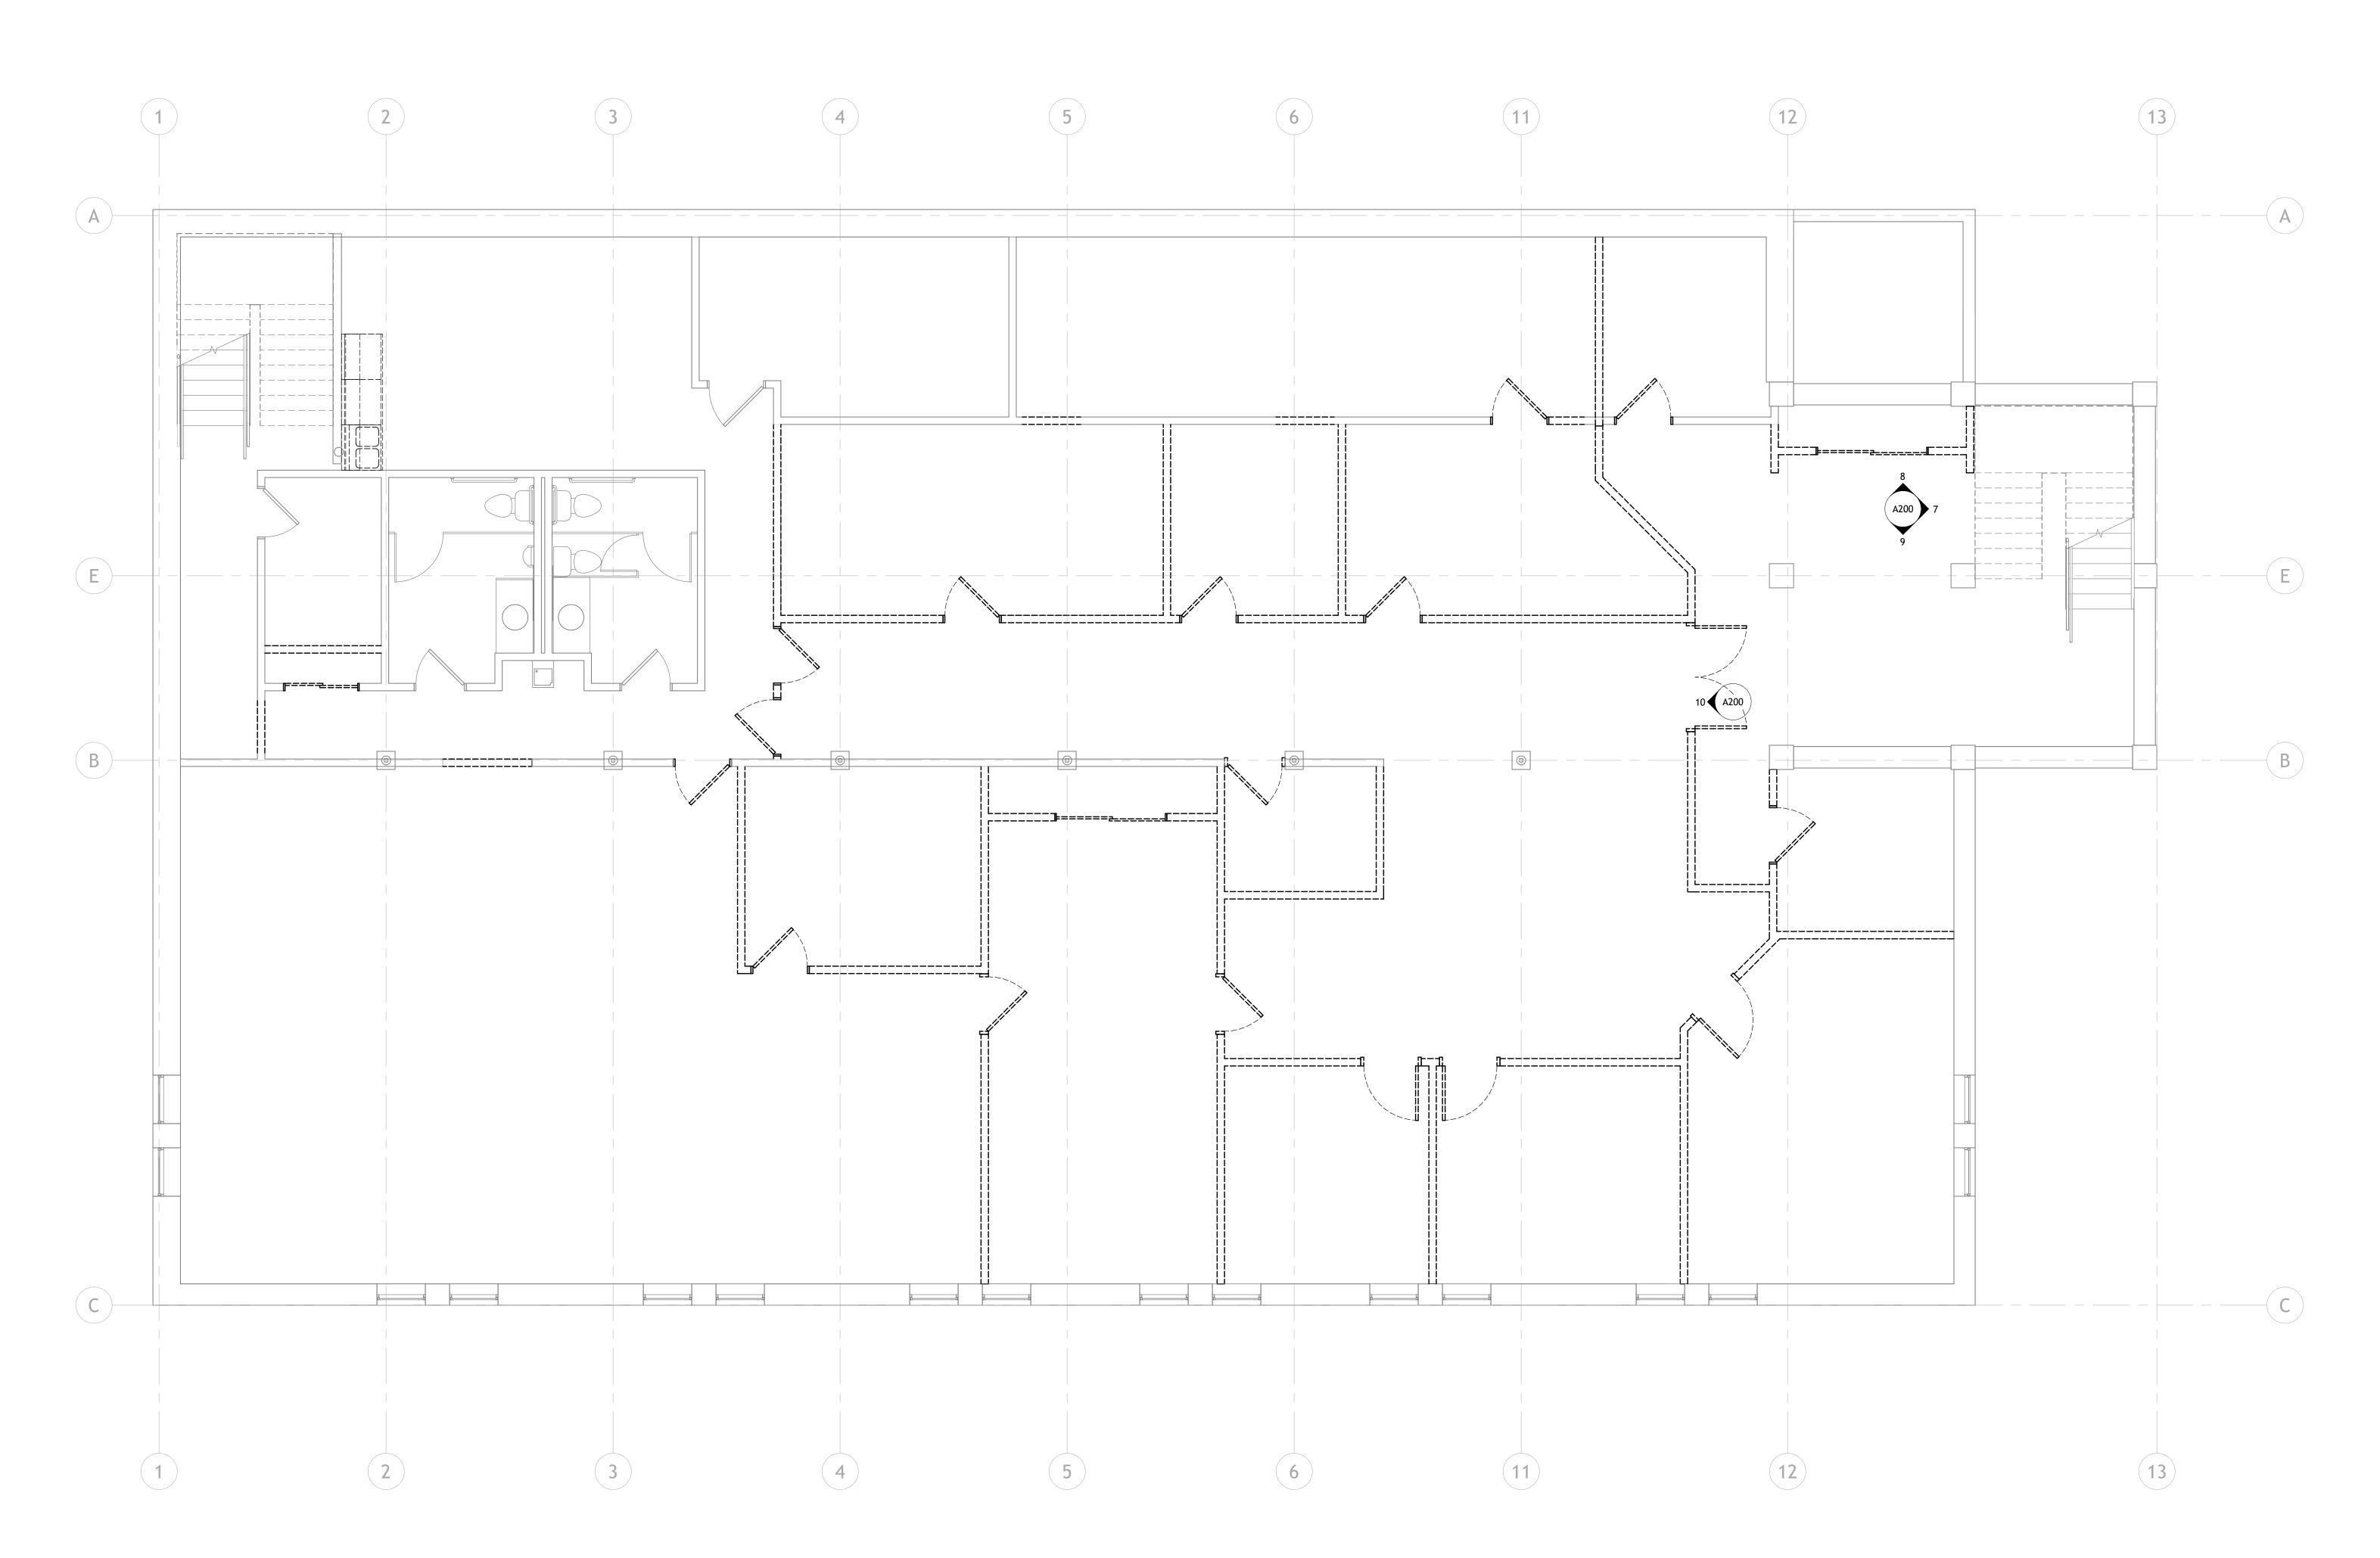

PROJECT NAME THE SUITES IV

11575 W. THEO TREKKER WEST ALLIS, WI

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DRAWING ISSUANCE DESCRIPTION

SET TYPE PROGRESS SET

PROJECT NUMBER 24008

DATE 03/12/2024

SHEET TITLE
LL FLR DEMOLITION PLAN

SHEET NUMBER

1/4" = 1'-0"

SHEET NOTES - DEMOLITION

- COORDINATE REMOVAL OF EXISTING CABINETS AND CASEWORK WITH <OWNER>. SALVAGE OR REMOVE AS DIRECTED.
- 2. COORDINATE REMOVAL OF EXISTING DOORS, FRAMES, AND HARDWARE WITH <OWNER>. SALVAGE OR REMOVE AS DIRECTED. REFER TO ROOM FINISH SCHEDULE TO IDENTIFY ALL AREAS BEING ALTERED
- INCLUDING ROOMS WHERE ALTERATIONS ARE LIMITED TO NEW FINISHES. AT ALL ALTERED LOCATIONS, REMOVE ALL INTERIOR AND WALL MOUNTED ITEMS. REMOVE ALL FINISHES AND RESIDUAL GLUE. PREPARE SURFACES FOR NEW FINISH APPLICATION.
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- 6. PATCH AND REPAIR CEILING GRID SYSTEM WHERE WALLS AND PARTITIONS HAVE BEEN REMOVED.
- HAVE BEEN REMOVED.

tredogroup 219 NORTH MILWAUKEE STREET SUITE 630 MILWAUKEE WISCONSIN 53202 (414) 254-0498 TREDOGROUP.COM

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PROJECT NUMBER 24008

DATE

03/12/2024

SHEET TITLE
1ST FLR DEMOLITION
PLAN SHEET NUMBER

SHEET NOTES - FLOOR PLAN

- 1. BEFORE BEGINNING WORK, INVESTIGATE AND VERIFY THE EXISTENCE AND LOCATION OF MECHANICAL AND ELECTRICAL SYSTEMS AND OTHER CONSTRUCTION AFFECTING THE WORK. IF DISCREPANCIES ARE DISCOVERED, NOTIFY ARCHITECT PROMPTLY.
- 2. PROVIDE REQUIRED UTILITY SERVICES TO EQUIPMENT, FURNISHINGS AND APPLIANCES. COORDINATE REQUIREMENTS WITH < OWNER> < TENANT>. 3. DIMENSIONS ON FLOOR PLANS ARE TO FINISH FACE OF WALLS UNLESS NOTED
- OTHERWISE. 4. VERIFY STRUCTURAL ELEMENTS INCLUDING BUT NOT LIMITED TO POST TENSION CABLES OR OTHER REINFORCEMENT EMBEDDED IN FLOOR SLABS PRIOR TO
- CORING OR CUTTING. COORDINATE VERIFICATION METHOD WITH <OWNER> <OWNER REPRESENTATIVE> <BUILDING FACILITY MANAGER>. 5. PROVIDE ALL FINISH SAMPLES TO <ARCHITECT> <OWNER> FOR REVIEW AND
- APPROVAL PRIOR TO INSTALLATION INCLUDING BUT NOT LIMITED TO CARPET, WALL COVERINGS, PAINT DRAW-DOWNS, VINYL BASE, <OTHER>. 6. ALL WALLS SHALL BE WALL TYPE S3A-11 UNLESS NOTED OTHERWISE. SEE WALL
- TYPES <G000>. 7. PROVIDE MOISTURE RESISTANT AND MOLD RESISTANT GYPSUM BOARD AT
- PLUMBING FIXTURE WALLS. 8. LOCATE ALL DOOR JAMBS 4" FROM ADJACENT PERPENDICULAR WALL UNLESS NOTED OTHERWISE.
- 9. PROVIDE BLOCKING AND FRAMING AS INDICATED AND AS REQUIRED TO SUPPORT FACING MATERIALS, FIXTURES, SPECIALTY ITEMS, MILLWORK AND TRIM.
- 10. PROVIDE 3/4" FIRE-RETARDANT TREATED PLYWOOD AS BACKING PANELS FOR TELEPHONE & ELECTRICAL EQUIPMENT AT <ROOM NAME AND NUMBER>. INSTALL AT 1'-0" AFF TO FINISHED CEILING. PAINT PLYWOOD TO MATCH ADJACENT WALL FINISH. COORDINATE FINAL SIZE AND LOCATION WITH <TENANT> <OWNER>.

KEYNOTES PER SHEET

1 - REMOVE WALLS AND ASSOCIATED DOOR, SALVAGE DOOR FOR RELOCATION 2- REMOVE FLOORING AND ASSOCIATED WALL BASE AS REQ'D
3- REMOVE TOILET PARTITIONS, PLUMBING FIXTURES, CASEWORK AND COUNTERTOPS, PREP FOR NEW 4- REMOVE WALL FINISHES & ANY ASSOCIATED WALL FIXTURES, PREP FOR NEW TILE FLOORS, BACKSPLASH, LIGHTING AND MIRRORS

5- REMOVE BASEBOARD HEATERS
6- REMOVE EXISTING PEWS PREP FOR NEW UPHOLSTERED PEWS 7- REMOVE DOORS, FRAMES TO REMAIN TO BE PAINTED 8- REMOVE EXISTING PEWS, TO BE REPLACED WITH MOVEABLE SEATING 9- REMOVE WALL AND RISERS FOR ORGAN ROOM ENLARGMENT, TBD BY OWNER

THE SUITES IV 11575 W. THEO TREKKER

PROJECT NAME

219 NORTH MILWAUKEE STREET

SUITE 630

MILWAUKEE WISCONSIN 53202

(414) 254-0498

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WEST ALLIS, WI

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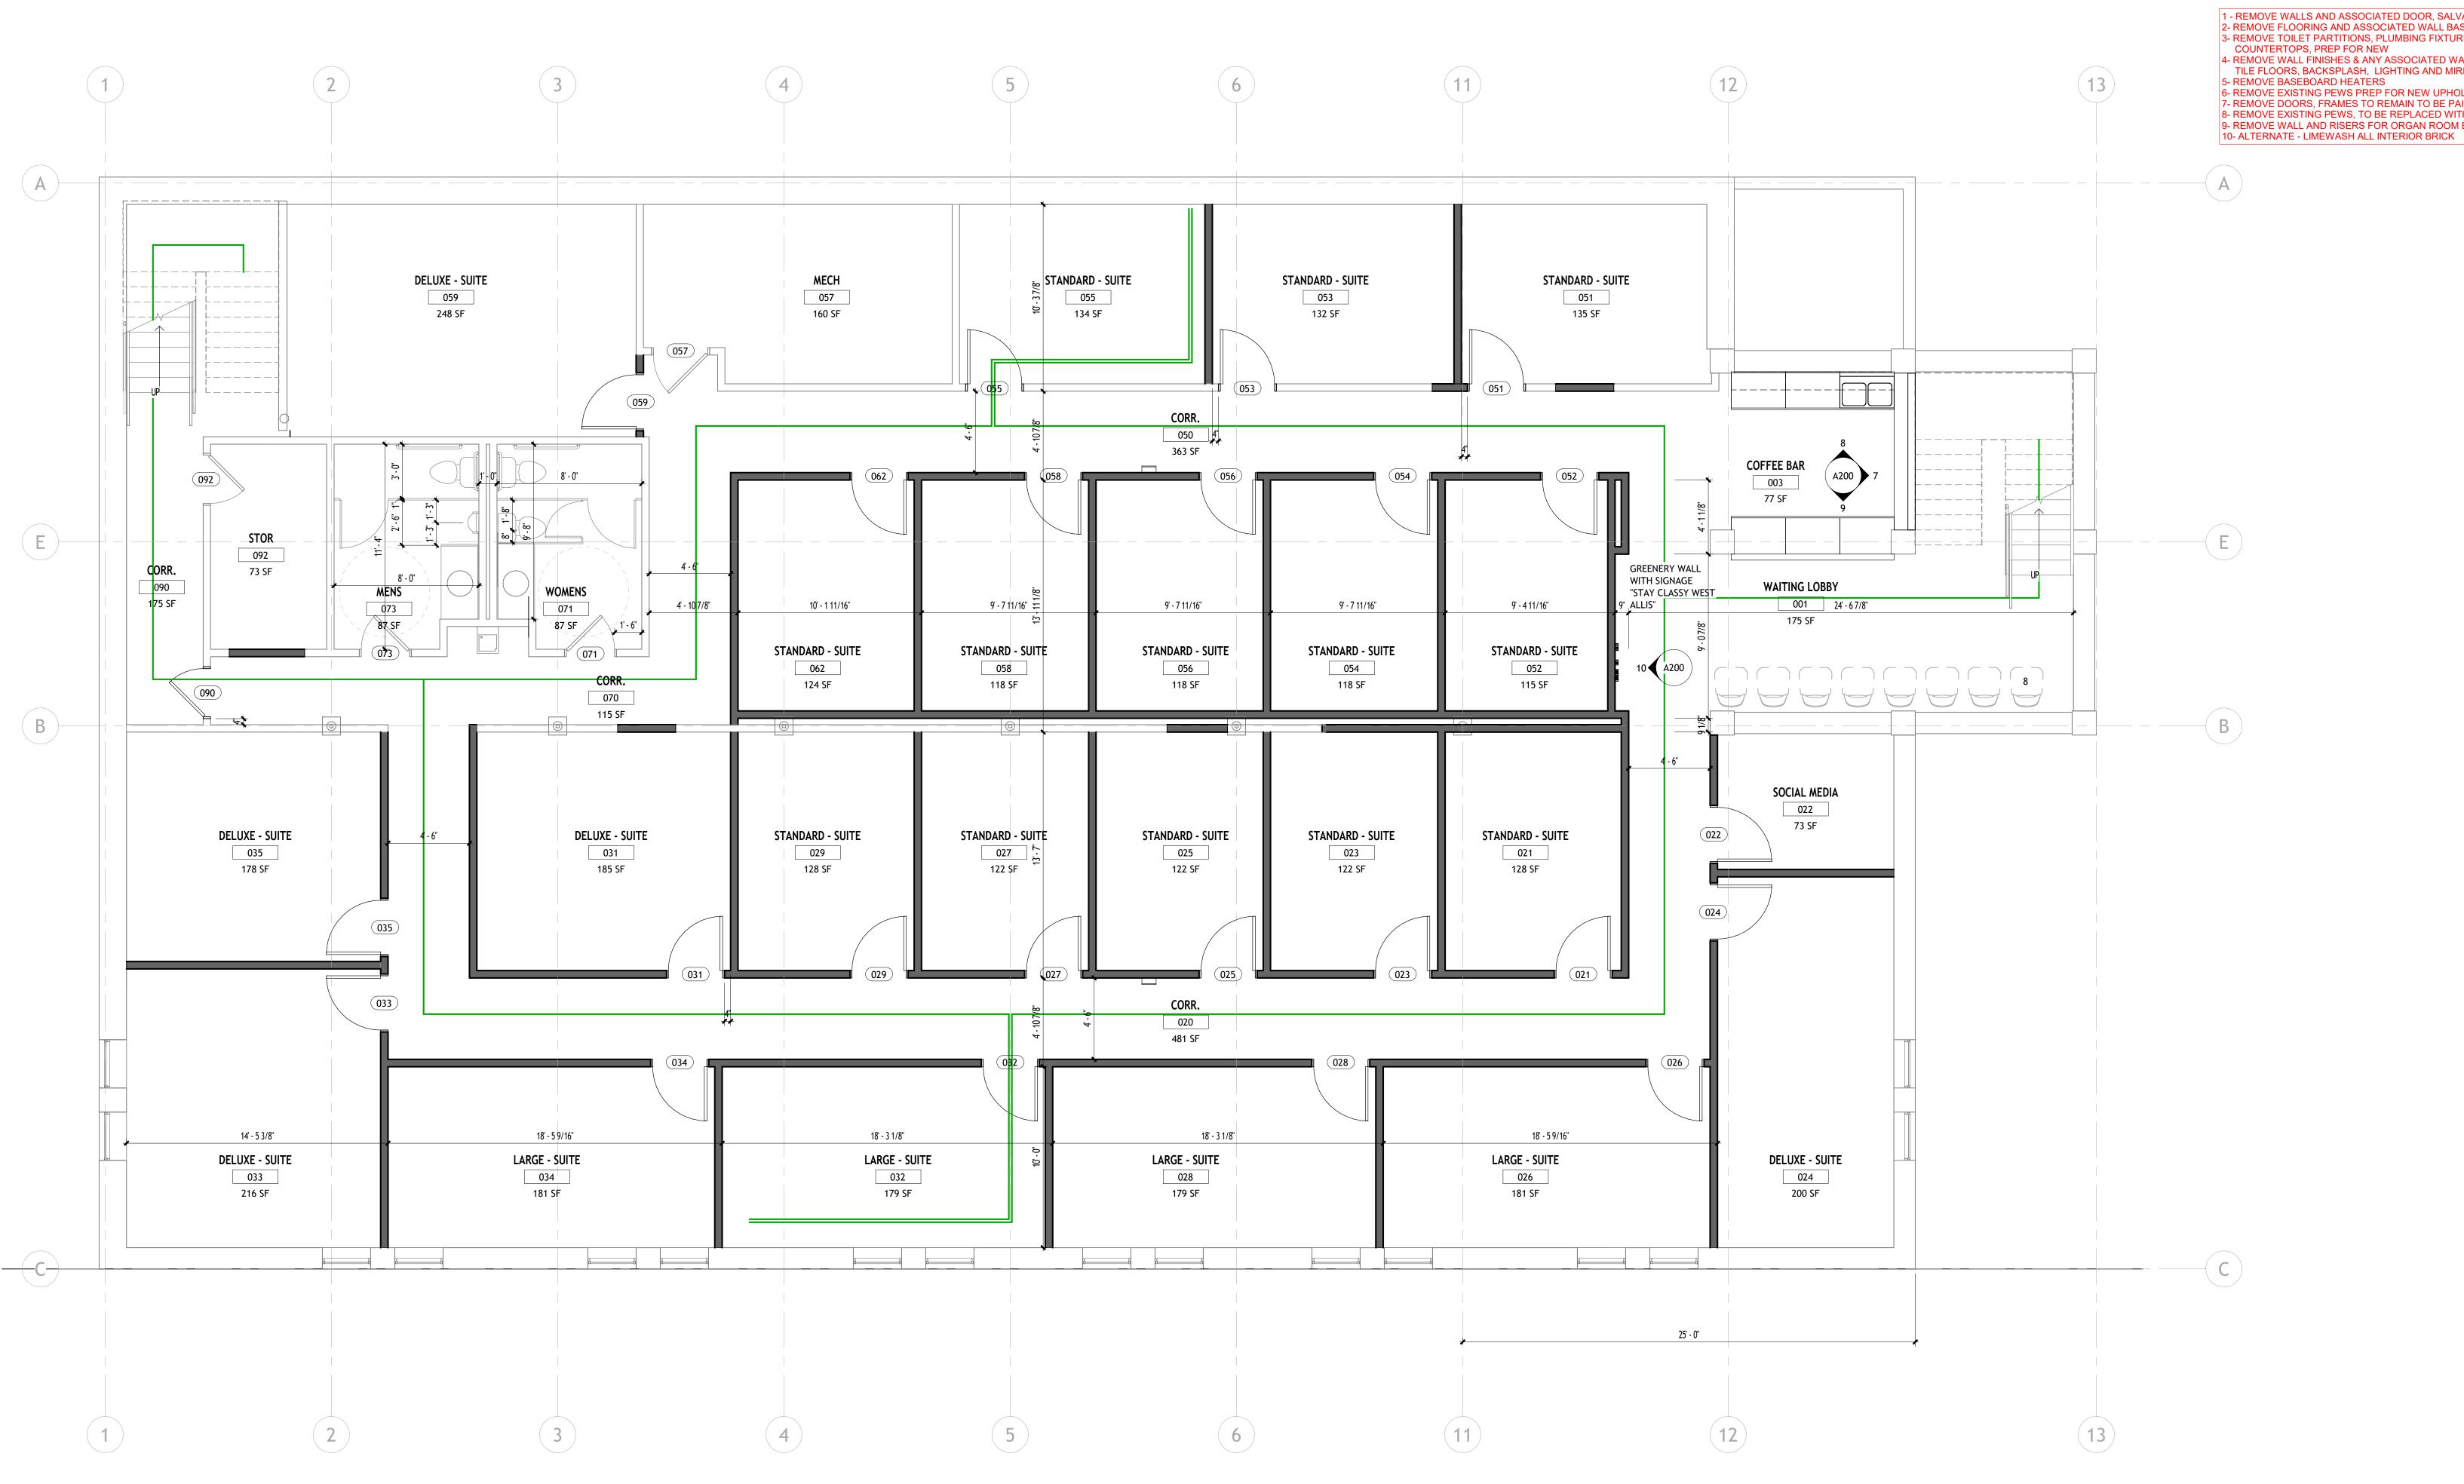
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LL FLR PLAN


SHEET TITLE

SHEET NUMBER

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1/4" = 1'-0"



SHEET NOTES - FLOOR PLAN

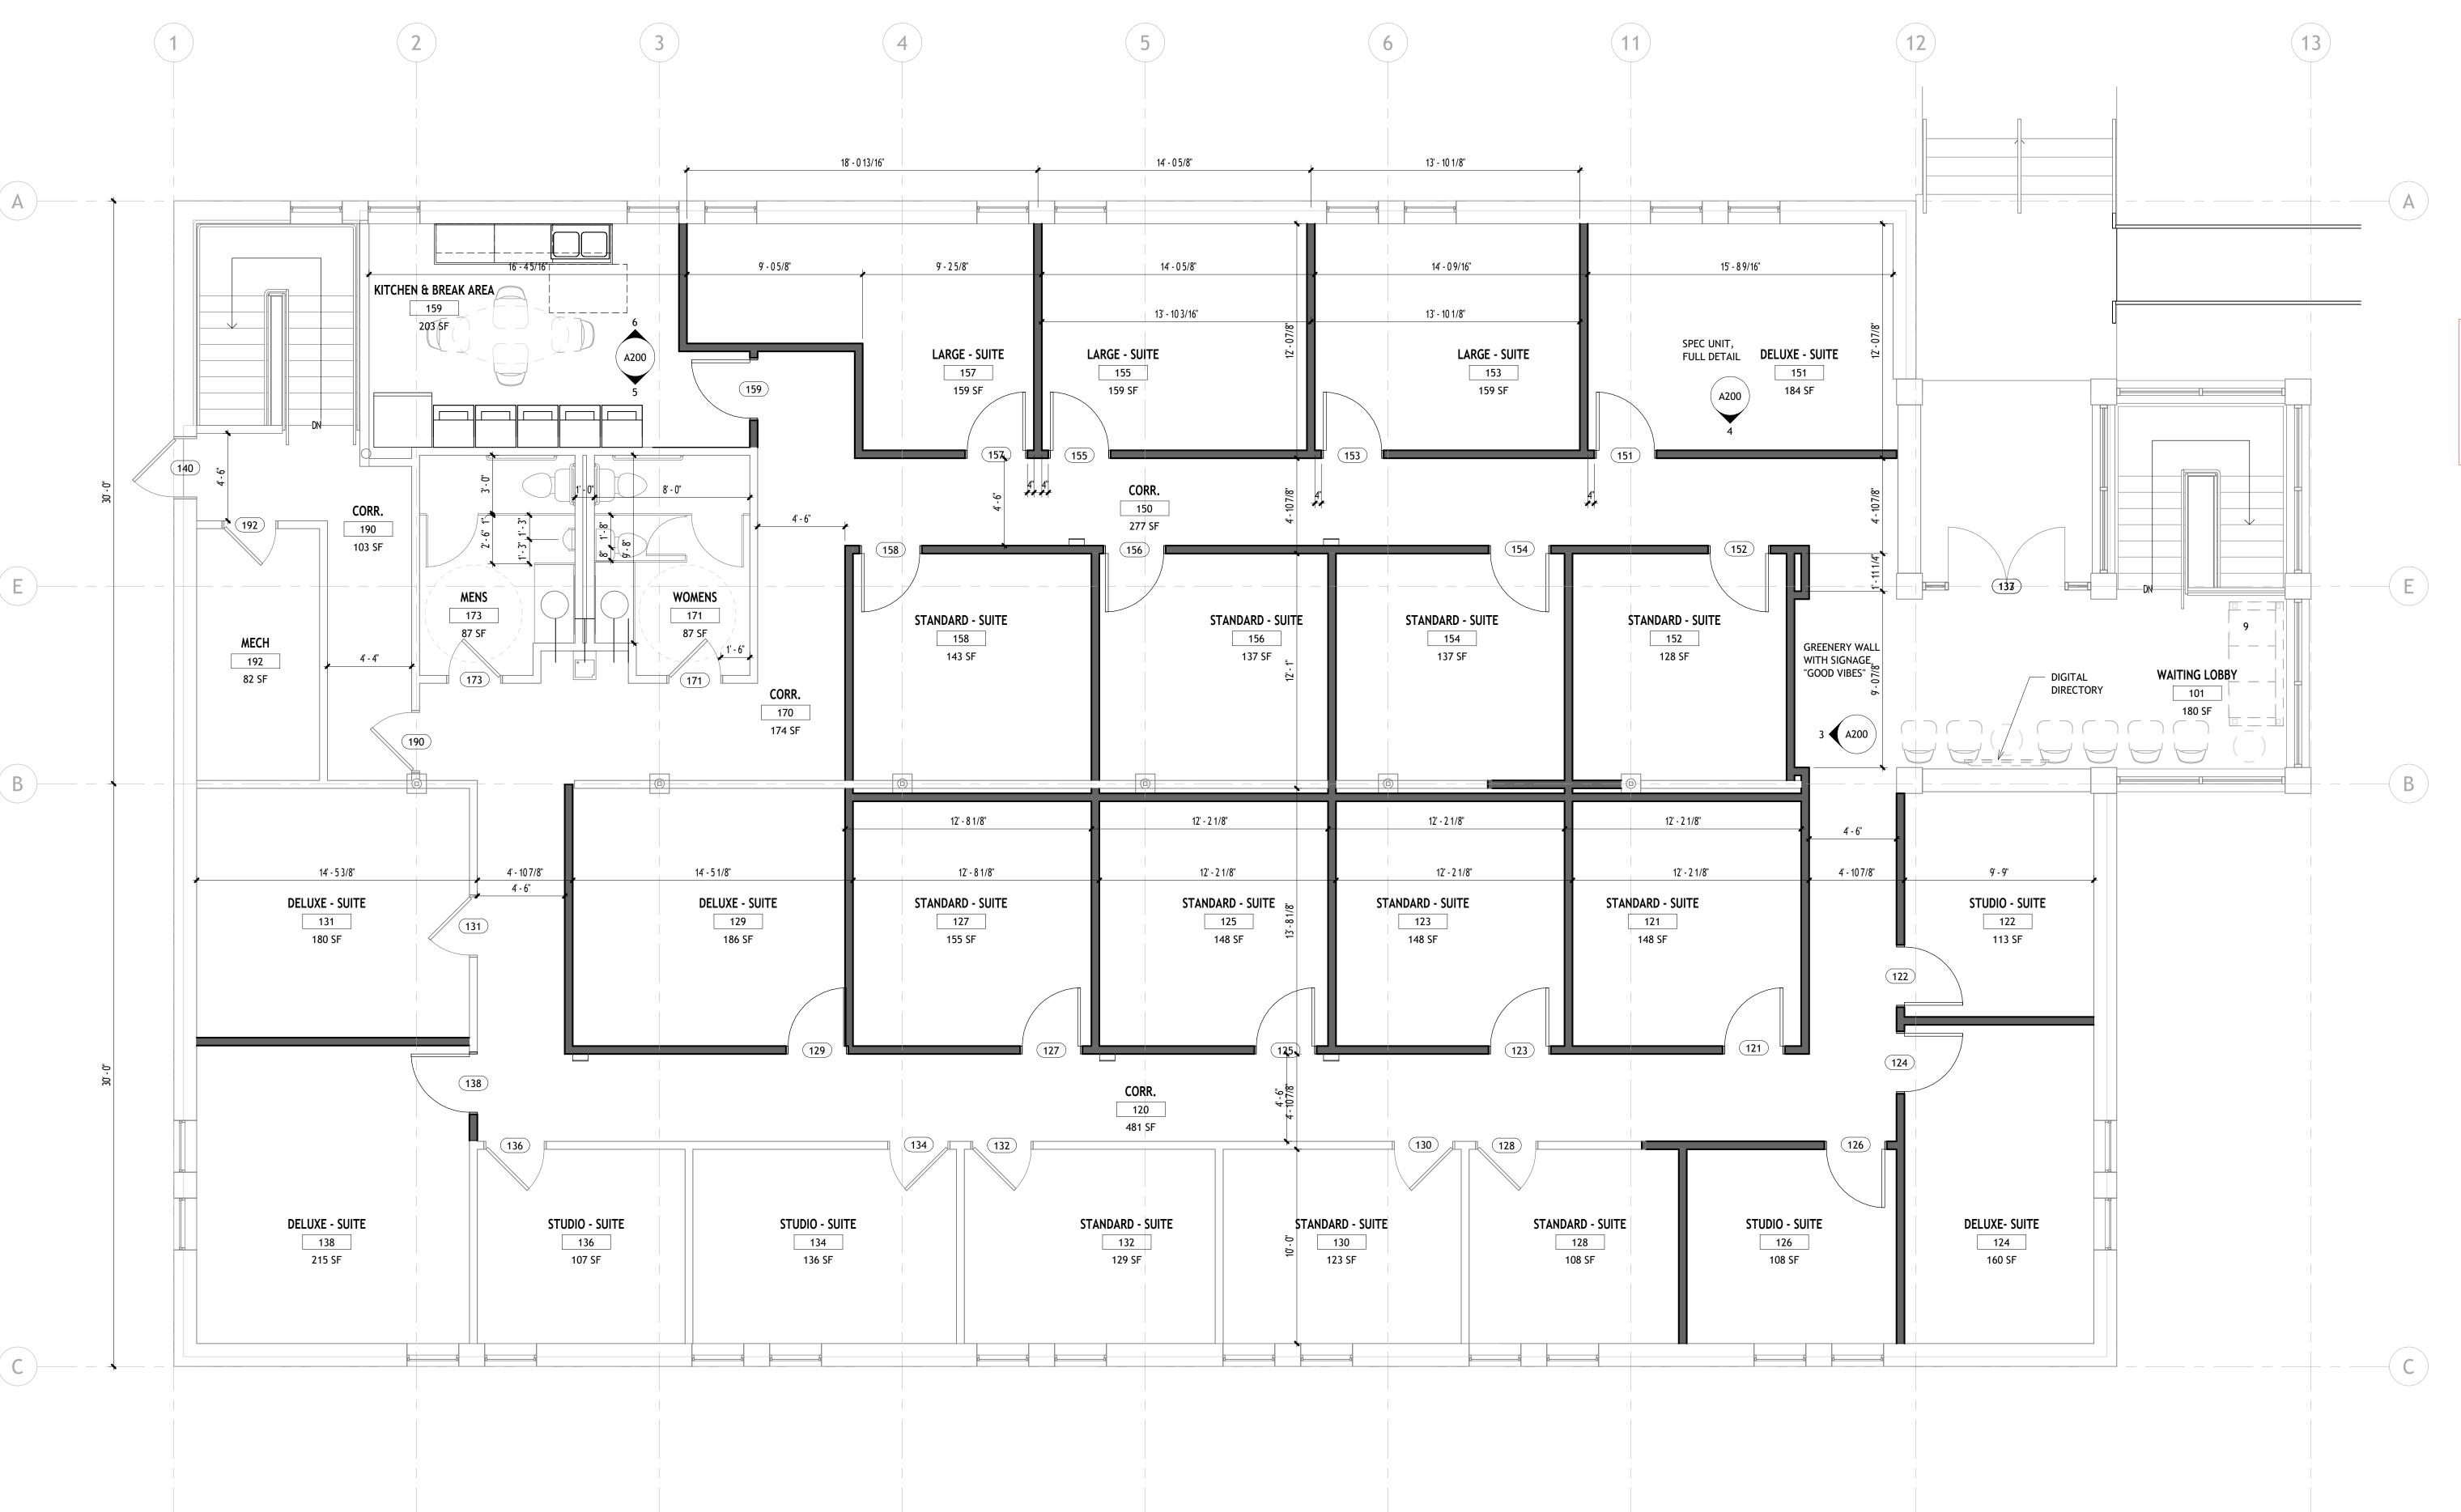- BEFORE BEGINNING WORK, INVESTIGATE AND VERIFY THE EXISTENCE AND LOCATION OF MECHANICAL AND ELECTRICAL SYSTEMS AND OTHER CONSTRUCTION AFFECTING THE WORK. IF DISCREPANCIES ARE DISCOVERED,
- 2. PROVIDE REQUIRED UTILITY SERVICES TO EQUIPMENT, FURNISHINGS AND APPLIANCES. COORDINATE REQUIREMENTS WITH < OWNER > < TENANT >.

NOTIFY ARCHITECT PROMPTLY.

TYPES <G000>.

- 3. DIMENSIONS ON FLOOR PLANS ARE TO FINISH FACE OF WALLS UNLESS NOTED OTHERWISE. 4. VERIFY STRUCTURAL ELEMENTS INCLUDING BUT NOT LIMITED TO POST TENSION
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 <OWNER REPRESENTATIVE> <BUILDING FACILITY MANAGER>.
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- 7. PROVIDE MOISTURE RESISTANT AND MOLD RESISTANT GYPSUM BOARD AT PLUMBING FIXTURE WALLS.
- 8. LOCATE ALL DOOR JAMBS 4" FROM ADJACENT PERPENDICULAR WALL UNLESS NOTED OTHERWISE.
- 9. PROVIDE BLOCKING AND FRAMING AS INDICATED AND AS REQUIRED TO SUPPORT FACING MATERIALS, FIXTURES, SPECIALTY ITEMS, MILLWORK AND TRIM.
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KEYNOTES PER SHEET

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6- REMOVE EXISTING PEWS PREP FOR NEW UPHOLSTERED PEWS
7- REMOVE DOORS, FRAMES TO REMAIN TO BE PAINTED
8- REMOVE EXISTING PEWS, TO BE REPLACED WITH MOVEABLE SEATING
9- REMOVE WALL AND RISERS FOR ORGAN ROOM ENLARGMENT, TBD BY OWNER
10- ALTERNATE - LIMEWASH ALL INTERIOR BRICK

PROJECT NAME

THE SUITES IV

11575 W. THEO TREKKER WEST ALLIS, WI

219 NORTH MILWAUKEE STREET SUITE 630

MILWAUKEE WISCONSIN 53202

(414) 254-0498

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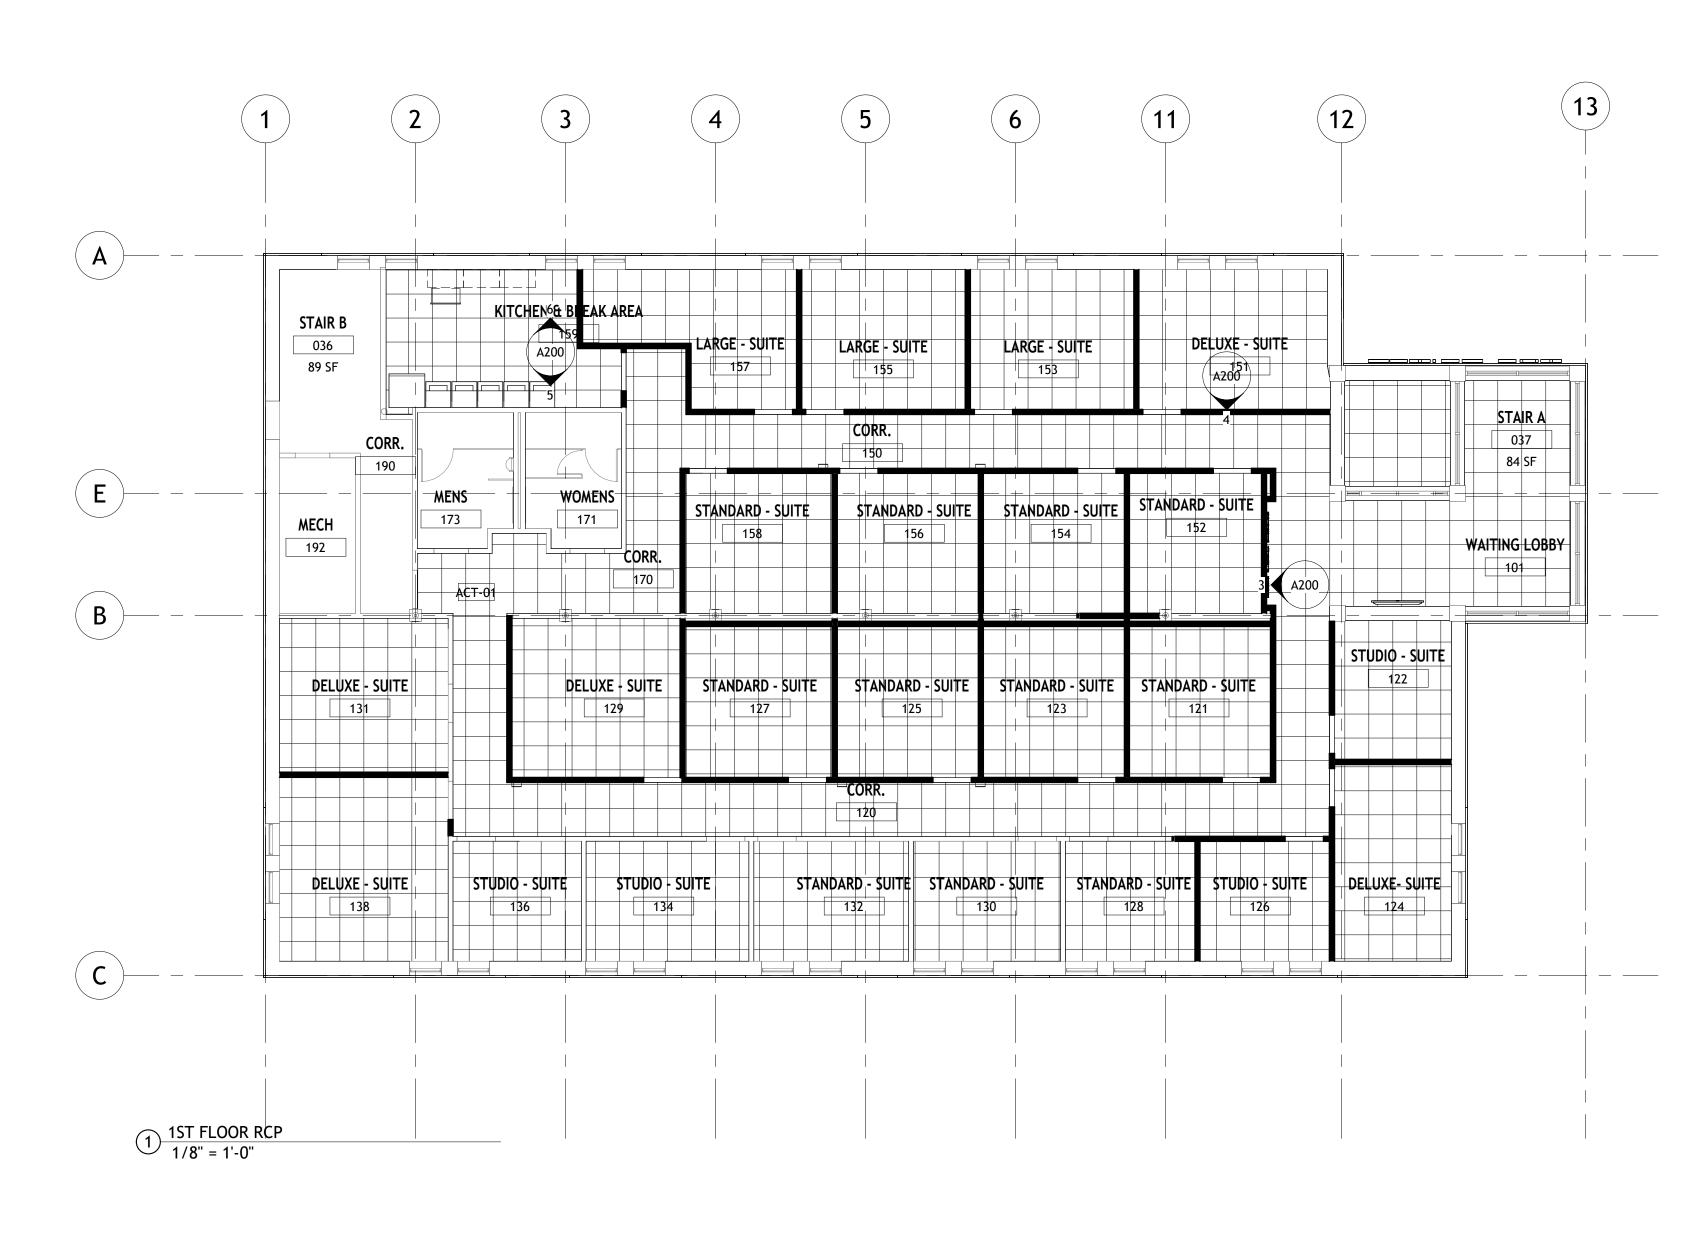
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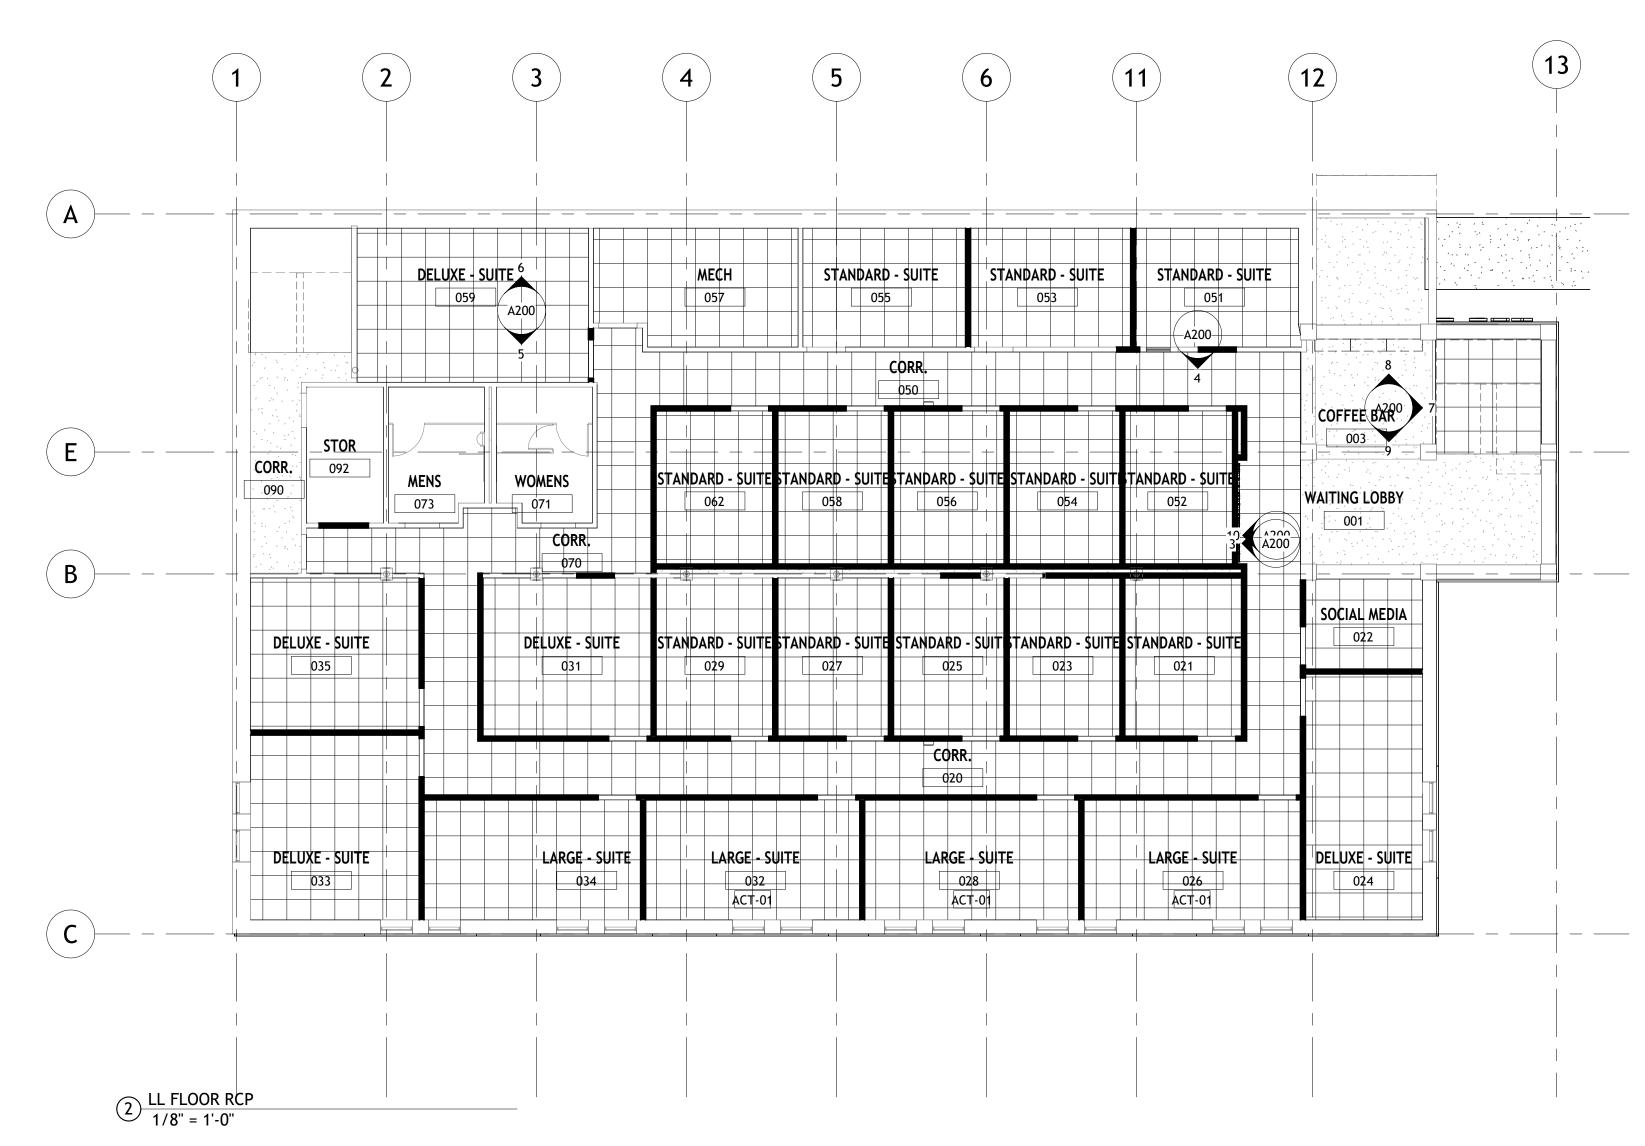
PROJECT NUMBER

DATE 03/12/2024

SHEET TITLE 1ST FLR PLAN

SHEET NUMBER







PROJECT NAME THE SUITES IV

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DATE

03/12/2024

SHEET TITLE LL FLR RCP

SHEET NUMBER

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	Door Schedule														
	Door							Fra	ame		T		Hardware		
		Size											Fire Rating		
Mark	Width	Height	Thickness	Material	Finish	Under Cut	Material	Туре	Finish	Head	Jamb	Sill	Label	Set No.	Comments
150	3' - 0"	7' - 0"	0' - 1 3/4"	WD											
158 156	3' - 0"	7 - 0"	0' - 1 3/4"	WD											
154	3' - 0"	7' - 0"	0' - 1 3/4"												
152	3' - 0"	7' - 0"	0' - 1 3/4"												
129	3' - 0"	7' - 0"	0' - 1 3/4"												
126	3' - 0"	7' - 0"	0' - 1 3/4"												
124	3' - 0"	7' - 0"	0' - 1 3/4"												
122	3' - 0"	7' - 0"	0' - 1 3/4"												
138	3' - 0"	7' - 0"	0' - 1 3/4"												
159	3' - 0"	7' - 0"	0' - 1 3/4"												
157	3' - 0"	7' - 0''	0' - 1 3/4"												
155	3' - 0"	7' - 0"	0' - 1 3/4"												
153	3' - 0"	7' - 0"	0' - 1 3/4"												
151	3' - 0"	7' - 0"	0' - 1 3/4"												
029	3' - 0"	7' - 0"	0' - 1 3/4"		STN-01		НМ	HM							
031	3' - 0"	7' - 0"	0' - 1 3/4"		STN-01		HM	HM							
027	3' - 0"	7' - 0''	0' - 1 3/4"		STN-01		HM	HM							
025	3' - 0"	7' - 0''	0' - 1 3/4"		STN-01		HM	HM							
023	3' - 0"	7' - 0"	0' - 1 3/4"		STN-01		НМ	HM							
021	3' - 0"	7' - 0"	0' - 1 3/4"		STN-01		HM	HM							
024	3' - 0"	7' - 0"	0' - 1 3/4"		STN-01		НМ	HM							
022	3' - 0"	7' - 0"	0' - 1 3/4"		STN-01		HM	HM							
033	3' - 0"	7' - 0"	0' - 1 3/4"		STN-01		HM	HM							
034	3' - 0"	7' - 0"	0' - 1 3/4"		STN-01		HM	HM							
028	3' - 0"	7' - 0"	0' - 1 3/4"		STN-01		НМ	HM							
032	3' - 0"	7' - 0"	0' - 1 3/4"		STN-01		HM	HM							
035	3' - 0"	7' - 0"	0' - 1 3/4"		STN-01		HM	HM							
062	3' - 0"	7' - 0"	0' - 1 3/4"		STN-01		HM	HM							
058 056	3' - 0"	7' - 0" 7' - 0"	0' - 1 3/4"		STN-01 STN-01		HM HM	HM							
054	3' - 0"	7 - 0"	0' - 1 3/4"		STN-01		HM	HM							
052	3' - 0"	7' - 0"	0' - 1 3/4"		STN-01		HM	HM							
052	3' - 0"	7' - 0"	0' - 1 3/4"		STN-01		HM	HM							
053	3' - 0"	7' - 0"	0' - 1 3/4"		STN-01		HM	HM							
055	3' - 0"	7' - 0"	0' - 1 3/4"		STN-01		HM	HM							
127	3' - 0"	7' - 0"	0' - 1 3/4"		3111 01										
125	3' - 0"	7' - 0"	0' - 1 3/4"												
123	3' - 0"	7' - 0"	0' - 1 3/4"												
121	3' - 0"	7' - 0"	0' - 1 3/4"												
026	3' - 0"	7' - 0"	0' - 1 3/4"		STN-01		НМ	HM							
090	2' - 8"	7' - 0"	0' - 1 3/4"												
059	3' - 0"	7' - 0"	0' - 1 3/4"		STN-01		НМ	НМ							

	Room Finish Schedule							
Room Number	Room Name	Floor Finish	Base Finish	Wall Finish	Ceiling Finish	Ceiling Height	Comments	
157	LARGE - SUITE							
155	LARGE - SUITE							
151	DELUXE - SUITE							
152 154	STANDARD - SUITE STANDARD - SUITE							
159	KITCHEN & BREAK AREA							
106	SHARED AMENITY							
153	LARGE - SUITE							
156	STANDARD - SUITE							
158	STANDARD - SUITE							
110 111	SUITE SUITE							
129	DELUXE - SUITE							
127	STANDARD - SUITE							
114	SUITE							
125	STANDARD - SUITE							
123	STANDARD - SUITE STANDARD - SUITE							
121 134	STUDIO - SUITE							
132	STANDARD - SUITE							
128	STANDARD - SUITE							
121	SUITE							
122	SUITE							
138	DELUXE - SUITE DELUXE - SUITE							
131 126	STUDIO - SUITE							
122	STUDIO - SUITE							
124	DELUXE- SUITE							
028	LARGE - SUITE							
026	LARGE - SUITE							
130	SUITE							
131 032	SUITE LARGE - SUITE							
034	LARGE - SUITE							
033	DELUXE - SUITE							
024	DELUXE - SUITE							
022	SOCIAL MEDIA							
031	DELUXE - SUITE							
029 062	STANDARD - SUITE STANDARD - SUITE							
058	STANDARD - SUITE							
027	STANDARD - SUITE							
025	STANDARD - SUITE							
056	STANDARD - SUITE							
054	STANDARD - SUITE							
023 021	STANDARD - SUITE STANDARD - SUITE							
052	STANDARD - SUITE							
057	MECH							
)55	STANDARD - SUITE							
053	STANDARD - SUITE							
051	STANDARD - SUITE							
152 035	SUITE DELUXE - SUITE							
)59	DELUXE - SUITE							
)92	STOR							
130	STANDARD - SUITE							
136	STUDIO - SUITE							
101	WAITING LOBBY							
100 192	VESTIBULE MECH							
173	MENS							
71	WOMENS							
003	COFFEE BAR							
073	MENS							
)71 70	WOMENS							
170 120	CORR.							
150	CORR.							
001	WAITING LOBBY							
140	CORR.							
190	CORR.							
050	CORR.							
020 070	CORR.							
090	CORR.							
036	STAIR B							
037	STAIR A							



PROJECT NAME
THE SUITES IV

11575 W. THEO TREKKER WAY WEST ALLIS, WI

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DATE DESCRIPTION

SET TYPE
PROGRESS SET

PROJECT NUMBER 24008

DATE 03/12/2024

SHEET TITLE
DOOR & ROOM FINISH
SCHEDULE

SHEET NUMBER





STAFF REPORT WEST ALLIS PLAN COMMISSION Wednesday, March 27, 2024 Common Council Chambers 6:00 PM

Watch: https://www.youtube.com/user/westalliscitychannel

5. Sale of an approximate 670-sf portion of land on property located at 62** W. National Ave (Tax key Parcel: 454-0073-001).

Overview and Zoning

Citlali and Nicolas of Antigua Restaurant at 6207 W. National Ave. have submitted an offer to purchase a small piece of city parking lot (a landscaping island) west of their restaurant. Refer to exhibit. Antigua would like to purchase the land from the city to add an outdoor patio for their customers. Their interest includes enhancing the curb appeal and dining experience... a welcome idea along W. National Ave.

Consideration of the sale of land requires the city to make the requested offer public. This means bringing the request/offer to purchase before Common Council for introduction to see if there is any interest in selling the land. If so, the Council refers the item to the Plan Commission for consideration of land use appropriateness. Plan Commissions role is to determine if the proposed sale of land, in this case to a commercial use for a commercial end use, if deemed compatible with the long-range Comprehensive Plan for the city (homework – refer to Ch 3 Land Use, recommendation 3, of the 2045 Comp Plan). If you agree, recommend approval. Plan Commission's recommendation is advisory and referred to the Common Council for a public hearing. The council will make the final decision on the disposition of land. The City is not required to sell the land.



Our City Assessor has valued the land at \$10/sf. If the Council accepts the idea of selling the land, Antigua will prepare a certified survey map, legal description of the area to be sold and combined with that of their restaurant property. Then the City would work to convey/sell the land area. Antigua would also prepare more detailed plans of the site changes needed to convert the landscaping island into a

restaurant patio (and subject to Plan Commission site/landscaping, architectural design approval at a future date).

Schedule we're following:

- 1) March 5 Council Board of Public Works (item 41) refer the matter to Plan Commission,
- 2) March 27 Plan Commission consideration (of surplus land area),
- 3) April TBD Council public hearing on the land sale.
- 4) Subsequent PC consideration of CSM, site & landscaping plan.

Of note on March 5th the Common Council unanimously recommended to forward Antigua's offer to purchase to the Planning Commission. Plan Commissions decision will be sent to Council for hearing in April.

Recommendation: Refer to Common Council. Recommend Common Council approval Sale of an approximate 670-sf portion of land on property located at 62** W. National Ave (Tax key Parcel: 454-0073-001), as the land sale would further redevelopment of underutilized land in accordance with the 2045 Comprehensive Plan.

If Council approves the land sale the following being submitted to Plan Commission for consideration:

- 1. A revised Site and Landscaping Plan being submitted to the Planning and Zoning Office. Contact Steve Schaer, Manager of Planning and Zoning at 414-302-8466.
- 2. Certified Survey Map to consolidate properties and being recorded with the Milwaukee Co. Register of Deeds.
- 3. Licensed extension of premise being applied for with the City Clerks Office.



STAFF REPORT WEST ALLIS PLAN COMMISSION Wednesday, March 27, 2024 Common Council Chambers 6:00 PM

Watch: https://www.youtube.com/user/westalliscitychannel

6. Ordinance to amend zoning code to prohibit the retail sale of dogs, cats, and rabbits.

In February the Common Council approved a zoning ordinance amendment related to certain animal services. That ordinance, O-2023-0088, allowed animal boarding with certain criteria to limit noise into residential areas, defined animal training, animal shelters, animal breeding and set certain limits and/or restrictions to these uses. Since this time, Ald. Grisham and Ald. Kuehn have sponsored an update that is sought to address the milling issue with cats, dogs, and rabbits.

The Humane Society and other animal control facilities like <u>Milwaukee MADACC</u> advocate against animal mills (where mass breeding operations designed for compensation with little regard for animal/public health, animal control, and humane treatment). Such places commonly sell through internet sales, online classified ads, flea markets and pet stores.

Plan Commission's role is to review the ordinance and refer their decision to the Common Council for consideration. A public hearing before the Common Council is required for passage of zoning ordinance amendments.



If passed, new businesses that sell dogs, cats, or rabbits would be prohibited. The zoning definition would exempt animal shelters.

	The retail sale of a dog, cat, or rabbit, except any sale by a person who is also using the same lot as an animal shelter
Animal Shelter	The use of a lot by a humane society, animal welfare society, animal rescue group, or other nonprofit group to shelter, feed, and care for animals in a manner that is not an animal boarding service

Retail	RA -1	RA -2	RA -3	RB	R C	C- 1	C- 2	C- 3	C- 4	I-1	I-2	P	SF
Animal Sales													

Existing businesses in operation would be considered legal-non-conforming and could continue.

Recommendation: Common Council approval of the Ordinance to amend zoning code to prohibit the retail sale of dogs, cats, and rabbits.



STAFF REPORT WEST ALLIS PLAN COMMISSION Wednesday, March 27, 2024 6:00 PM

Watch: https://www.youtube.com/user/westalliscitychannel

7. Certified Survey Map to combine the existing parcels at 55** W. Lincoln Ave. and 5520 W. Lincoln Ave. into 1 parcel. (Tax Key Nos. 474-0490-000 and 474-0491-000)

Overview and Zoning

The property owner at 55** W. Lincoln Ave. and 5520 W. Lincoln Ave. is proposing to consolidate the two parcels into one parcel. The property owner intends to combine this parcels to anticipate future development. The applicant has not provided details as to what type of development may occur.


Both properties are zoned C-2 and may support a variety of commercial uses. Future development of the site may require Plan Commission approvals. Staff will work with the property owner on any future development of the property.



The proposed CSM would combine the 2 existing parcels into 1 lot. There are no maximum or minimum lot width requirements in the C-2 district. The proposed survey complies with zoning requirements. Future development would comply with the zoning district and is subject to Design Review.

Recommendation: Approve the Certified Survey Map to combine the existing parcels at 55** W. Lincoln Ave. and 5520 W. Lincoln Ave. into 1 parcel. (Tax Key Nos Tax Key Nos. 474-0490-000 and 474-0491-000) subject to Common Council approval and a revised Certified Survey Map being submitted to the Planning office for minor technical corrections



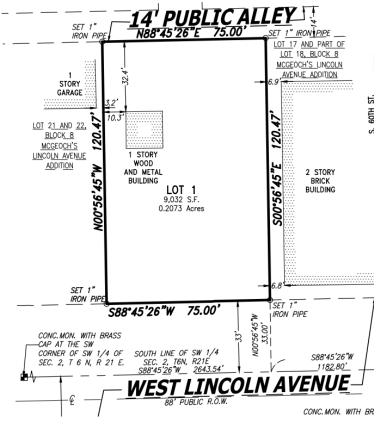



STAFF REPORT WEST ALLIS PLAN COMMISSION Wednesday, March 27, 2024 6:00 PM

8. Sign Appeal for Reunion, an existing Restaurant retail use at 6610 W. Greenfield Ave. (Tax Key No. 439-0001-032)

Overview

The Chris and Abby Paul, owners of Reunion Restaurant are seeking additional signage on the property. Situated at 6610 W. Greenfield Ave. Reunion is in the 6-Points Neighborhood on the cities fashionable east side. Historians will recognize it as the old Allis-Chalmers employment building. After an extensive renovation, the restaurant offers food and arcade lovers a full day or night of fun. The restaurant offers a spacious, yet cozy dining area on the first floor and a fully accessible arcade on the second floor. There's a nod to West Allis history on every wall – the family business honors the past while looking ahead to the city's future.

A sign plan has been provided by the applicant. Shown on the proposed sign plan is a wall sign and a projecting sign.

The projecting sign is 6' x 4'-8" (28 sq. ft). A maximum of 32 sq. ft. is permitted by the Sign Code. However, only a maximum projection of 4 ft is permitted. The sign projects greater than 4 ft to provide better clarity from a canopy addition on the first floor of the building. The wall sign is 5' x 2' (10 sq. ft.) and conforms with sign square footage permitted by the Sign Code. There is an existing wall sign that was approved by Plan Commission in 2021. The building is only permitted one wall sign which is the second reason for the appeal.

The request for additional signage comes due to the lack of a freestanding sign on the site along with the challenges presented by

W. Greenfield Ave.

the canopy addition. Additional signage will offer greater visibility for the business in the same manner a freestanding sign would.

Recommendation: Recommend approval of the Signage Plan for Reunion, an existing Restaurant use, at 7332 W. Becher St., (Tax Key No. 439-0001-032).



STAFF REPORT WEST ALLIS PLAN COMMISSION Wednesday, March 27, 2024 Common Council Chambers 6:00 PM

Watch: https://www.youtube.com/user/westalliscitychannel

9. Site, Landscaping, and Architectural Design Review for proposed improvements within City Pedestrian Plaza Right-of-Way Downtown West Allis in the 1300 block of S. 72 St.

Background

The WI State Statute Sec. 66.0905, grants municipalities the mechanism limit vehicular traffic/designate creating a pedestrian mall by ordinance after review bγ Plan Commission and a public hearing with Class 1 notice.



In 2022 the Common Council approved an ordinance to create a pedestrian mall on an approximate 60-ft x 120-ft portion of S. 72 St. (just north of W. Greenfield Ave.). The initial concept was also approved by Plan Commission in 2022 for discussion and approved by Plan Commission on December 7, 2022.

The objective of a pedestrian mall is to create a public space/amenity that is closed to motorists. The pedestrian mall concept is supportive of a thriving Main Street Community (that is Downtown West Allis).



2022 Rendering of a programmed pedestrian plaza - 1300 block S. 72 St. (north of W. Greenfield

Pedestrian Malls are not a street vacation/discontinuance. Unlike a street discontinuance/vacation process, a pedestrian mall closes a portion of the street, but the area remains public right-of-way (RoW) and does not become private property.

The Deco, an event space at 7140 W. GREENFIELD



Pedestrian plaza – 1300 block S. 72 St. (north of W. Greenfield Ave.)

Located at 7140 W. Greenfield Ave. is a newer event venue that was approved via conditional use permit in May of 2022. The property owner and proprietor is Walter Hotlz, who has invested over \$1MM in bringing the former department store building (Wedding Center and JC Penny) back to life as an event venue. The business opened its doors in 2023. The Deco property is located on the east side of S. 72 St. (abutting the subject pedestrian plaza).



2024-25, Update - The Deco is seeking a continuation of its privilege agreement within the Ped Plaza.

While some exclusive use is planned, the Deco will partner with the BID to share and help further activate the space. The public will not be excluded from the space during non-Deco events. The Deco would also be willing to host/partner community events. For instance, in 2023, the Deco hosted Wednesday Night Live events that attracted people to Downtown West Allis for live music events. The Deco has indicated they would pay for improvements and provide seating for the plaza.

- Walter Holtz, the owner of the property at 7140 W. Greenfield Ave., has submitted an
 updated vision and supporting documentation indicating he would like to use a portion of
 S. 72 St. abutting his property again (between W. Greenfield Ave. and the alley).
- The proposed concepts are more permanent in nature than the initial pilot year. The
 objective is to create a pleasant environment that incorporates movable structures,
 considering the various easements and utilities in the roadway. Mr. Holtz is aware that
 this carries some level of risk regarding the City's need to access the site, and a detailed
 privilege agreement, like last year's, but for a longer duration, would be necessary.
- The separate Privilege Agreement will be considered by the Common Council (by and between the city and the Deco/Walter Holtz) to specify and regulate terms on proposed improvements, special events, maintenance, insurance, termination clause.
- The terms under which Deco may serve alcohol (an extension of premise) will be handled by Council, but outside of the privilege agreement.
- Plan Commissions role is advisory, and should consider appropriateness within the goals
 of the 2045 Comprehensive Plan.

Public informational meeting

On November 10, 2022 the city hosted an informal gathering to share the pedestrian mall concept (closing a portion of S. 72 St. to motorists) in Downtown West Allis. About twenty (20) people attended the meeting (a few residents, some business owners, elected officials and staff in attendance). The informational meeting was shared with the Business Improvement District, and advertised via social media blasts and door hangers to neighbors along S. 72 St. north of W. Greenfield Ave.



Most of the feedback received was positive and supports a change to something less auto centric for Downtown West Allis.



2023- Wednesday Night Live event... A summer night in West Allis.

There have been some concerns with respect to closing the street to motorists. Specifically, concerns of reducing street parking (about 10 spaces), loss of S. 72 St. access for truck deliveries supportive of commercial business on the north side of W. Greenfield Ave. There have also been questions on programming space.

BID and Staff Comments


BID - The Business Improvement District has shared a communication with the Common Council and indicates that it would prefer the pedestrian plaza not be created in 2023, but instead wait until 2024. The BID's communication notes, "This allows the BID, the city and Mr. Holtz to get informed feedback from our businesses and residents to determine the impact of having 72nd Street closed so we can better determine the feasibility of closing it on a permanent basis. If everything is positive or if things need to be adjusted, they can be taken into consideration before moving forward."

Police and Fire Departments - The West Allis Police Department and Fire Department are supportive of the street closure with the understanding that barriers will be placed to prevent an errant motorist from turning into the area.

Engineering and Public Works - Engineering and PW have weighed in and are supportive of the project subject to Walter Holtz understanding that in case of water main break or gas leak or something along those lines that the City does not take liability to damaging any Holz/private the improvements that are in the right of way.

Furthermore, accessibility would be the key, to address any emergencies and general maintenance needs within that area. Existing infrastructure includes storm sewer on the north end, two water lines within the area on the east side, along with a hydrant and light pole that may require maintenance. West side is a traffic control cabinet. A procedure for scheduled maintenance issues within the plaza area would be developed.

Planning and Economic Development - The City's Planning and Economic Development teams support this effort. Adding public space in our downtown will encourage people to spend more time in the downtown, improves the pedestrian experience and traffic flow along Greenfield, provides opportunities for the BID and local businesses, and will help further West Allis as a destination. The Pedestrian Mall also is in alignment with the 2045 Comprehensive Plan, as a pedestrian plaza supports the goal to create vibrant spaces for community life. West Allis has few public spaces that center community life. To further solidify itself as a destination and foster a stronger sense of community, West Allis should create welcoming, unique, shared places for people.

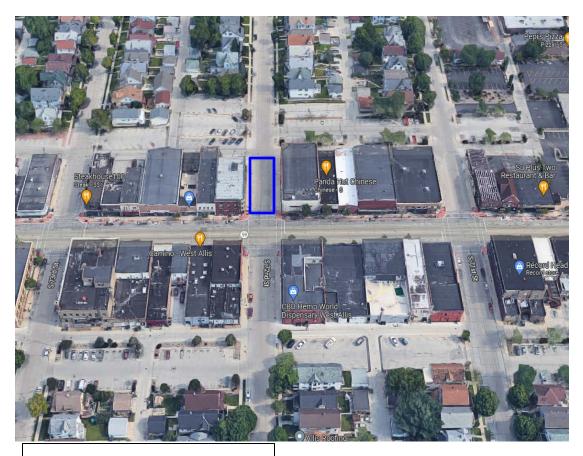

- 385 municipal parking spaces
- 161 street parking spaces

Recommendation: Referral to Common Council Board of Public Works for consideration of a privilege agreement and Site, Landscaping, and Architectural plans for proposed improvements within City Pedestrian Plaza Right-of-Way Downtown West Allis in the 1300 block of S. 72 St.

Plan Commission acknowledges that a pedestrian plaza supports the goal of the 2045 Comprehensive Plan to create vibrant spaces for community life. West Allis has few public spaces that center community life. To further solidify itself as a destination and foster a stronger sense of community, West Allis should create welcoming, unique, shared places for people.

2045 Comprehensive Plan (Big Ideas and Chapter 5, Transportation recommendations for reference)

Big Ideas

Through public engagement, hundreds of community members shared their thoughts on the most important issues and opportunities in West Allis.

5 big ideas emerged:

Grow West Allis

West Allis should strive to attract new residents - particularly young families and professionals. West Allis still has the infrastructure to support a larger population; welcoming more people to call West Allis home means more support for local businesses, more connections for residents, and more life in our community.

Safer streets for all users, especially people walking and biking West Allis' streets were historically designed to prioritize motor vehicles and speed above all else. People should be able to move safely and comfortably throughout the City's streets, no matter the method they use to get around. Streets should be redesigned as Complete Streets that design for safety, protect our most vulnerable road users, and encourage sustainable and healthy ways to get around.

New, quality housing that is affordable and offers a variety of choice West Allis' housing stock is aging and if neglected/not modernized, is a barrier towards growth. Additionally, there is more demand for housing than existing supply. New housing should be built that gives people of all income levels a desirable place to live.

Invest in parks and green space

West Allis' parks are beloved but need repairs, updates, and ongoing maintenance to thrive. Additionally, the built-out city has scarce land for green space. Better integrating parks and nature into the city's fabric will improve quality of life and make West Allis a more desirable place to live.

Vibrant spaces for community life

West Allis has few public spaces that center community life. To further solidify itself as a destination and foster a stronger sense of community, West Allis should create welcoming, unique, shared places for people.



Recommendation 12: Transform streets into more desirable places by capitalizing on their existing strengths and making them places people want to be

A: Prioritize designing streets as places for people, rather than places solely used for transportation. Incorporate gathering spaces, sidewalks, wider sidewalks, flexible curbside zones, and amenities such as benches into the design of streets.

B: Identify excess segments of right-of-way, particularly at complex intersections, and convert into public plazas.

C: Implement parking meter program in select commercial corridors to improve efficiency of parking assets and use revenue generated to pay for streetscaping enhancements.

D: Incorporate nature into the design of the public right-of-way by including trees, planting beds, and green infrastructure in streetscapes.

E: Update parklet and pedlet program for local businesses and advocate for WisDOT to allow these amenities in curbside zones along state highways.

F: Support efforts to temporarily change configurations or close streets temporarily to test different uses of public right-of-way.

PROJECT:

DECO EXTERIOR PLAZA

7140 W. GREENFIELD WEST ALLIS, WI ISSUED FOR PRICING/ PERMIT



GENERAL CONTRACTOR:
BY OWNER

MILWAUKEE, WISCONSIN



UTTECH DESIGN, LLC
MADISON / MILWAUKEE, WISCONSIN
T: 414.255.4600

PROJECT

DECO EXTERIOR PLAZA

OWNER

Wally Holtz 7140 W. Greenfield West Allis, Wisconsin

REVISIONS

INFORMATION

PROJECT DESIGNER: UTTECH	H DESIGN LLC
PROJECT MANAGER:	MJL
PROJECT NUMBER:	23_100
ISSUED FOR: PERMIT AND CO	DNSTRUCTION
DATE:	01.12.24

SHEET

TITLE SHEET

A0.0



MADISON / MILWAUKEE Tel: 414.255.4600

PROJECT

THE DECO EXTERIOR SPACE

7140 W. GREENFIELD WEST ALLIS, WISCONSIN

OWNER

WALLY HOLTZ

REVISIONS

NO. DESCRIPTION

INFORMATION


PROJECT DESIGNER:	UTTECH DESIGN LLC
PROJECT MANAGER:	MJU
PROJECT NUMBER:	23_1001
ISSUED FOR: PERMIT	AND CONSTRUCTION
DATE:	01.12.24

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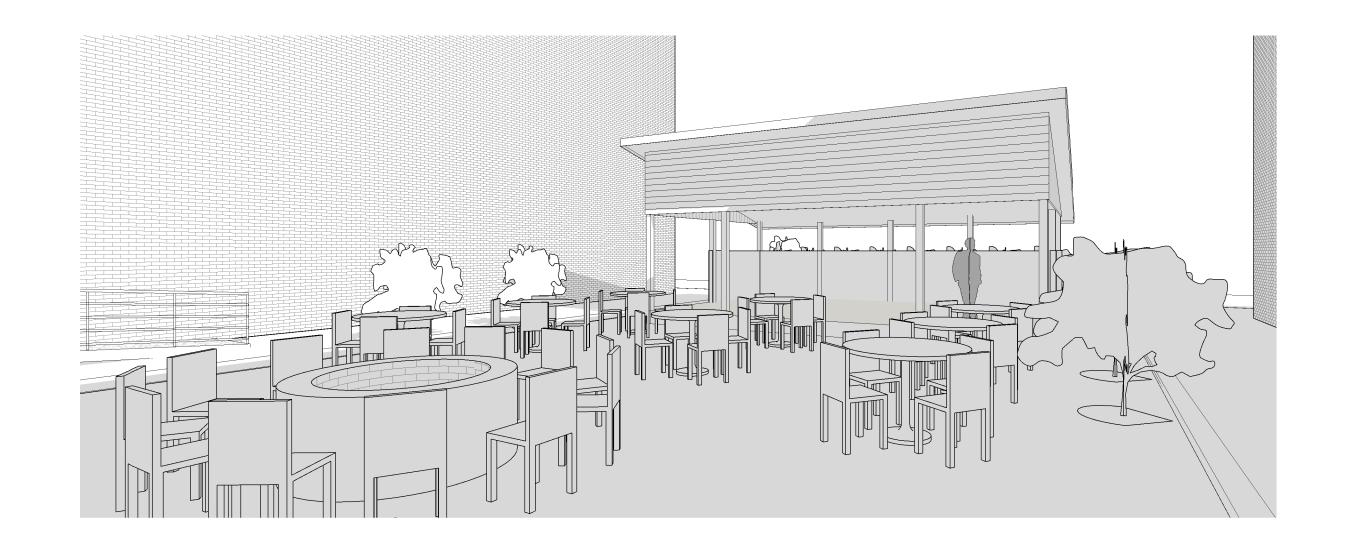
SHEET

SITE PLAN - EXTERIOR SPACE

A3.0

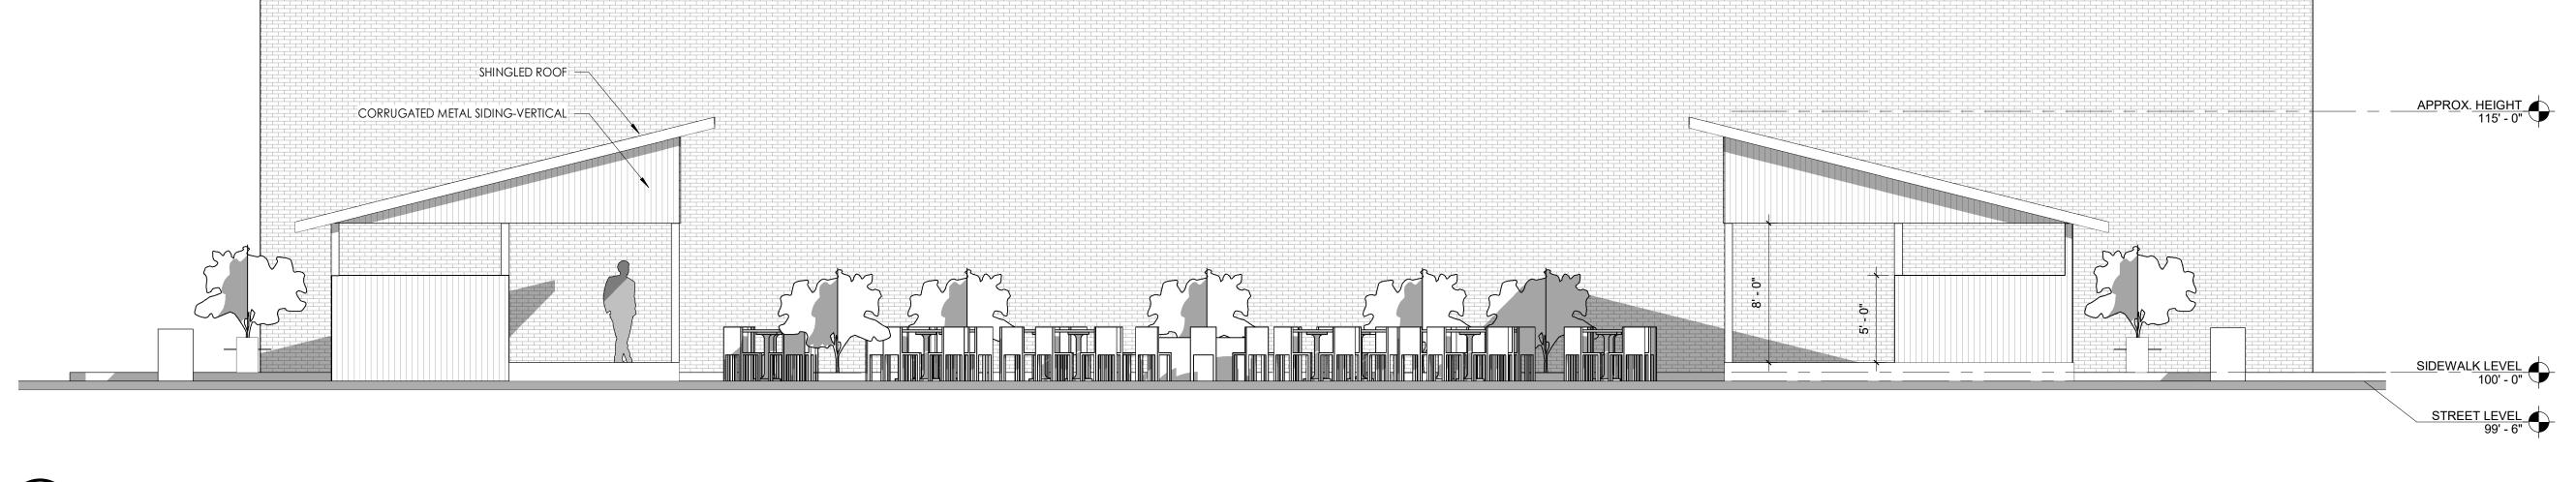

W. GREENFIELD




MADISON / MILWAUKEE Tel: 414.255.4600

PROJECT

THE DECO EXTERIOR SPACE

7140 W. GREENFIELD WEST ALLIS, WISCONSIN

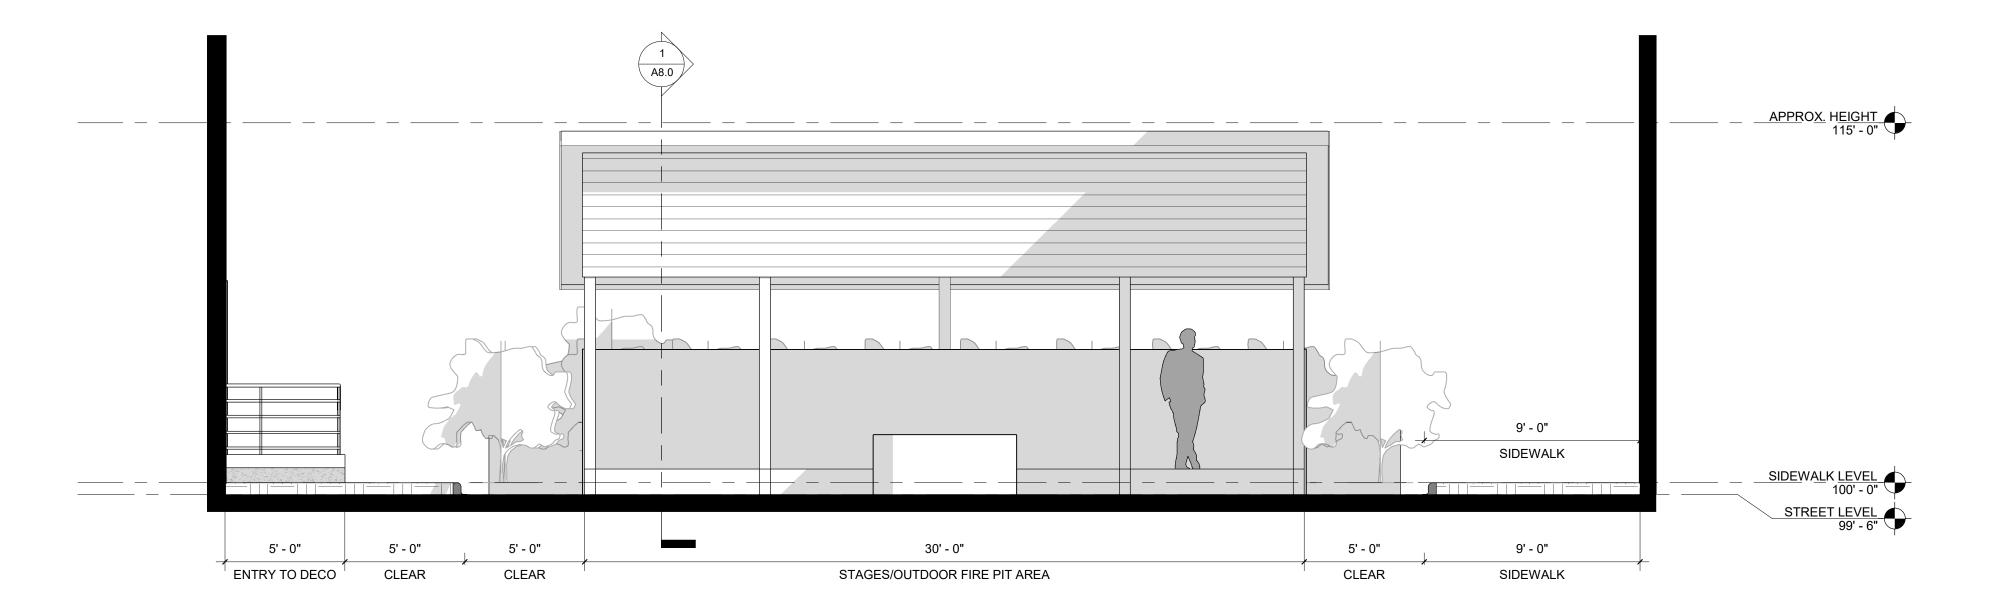


OWNER

WALLY HOLTZ

REVISIONS

DESCRIPTION DATE

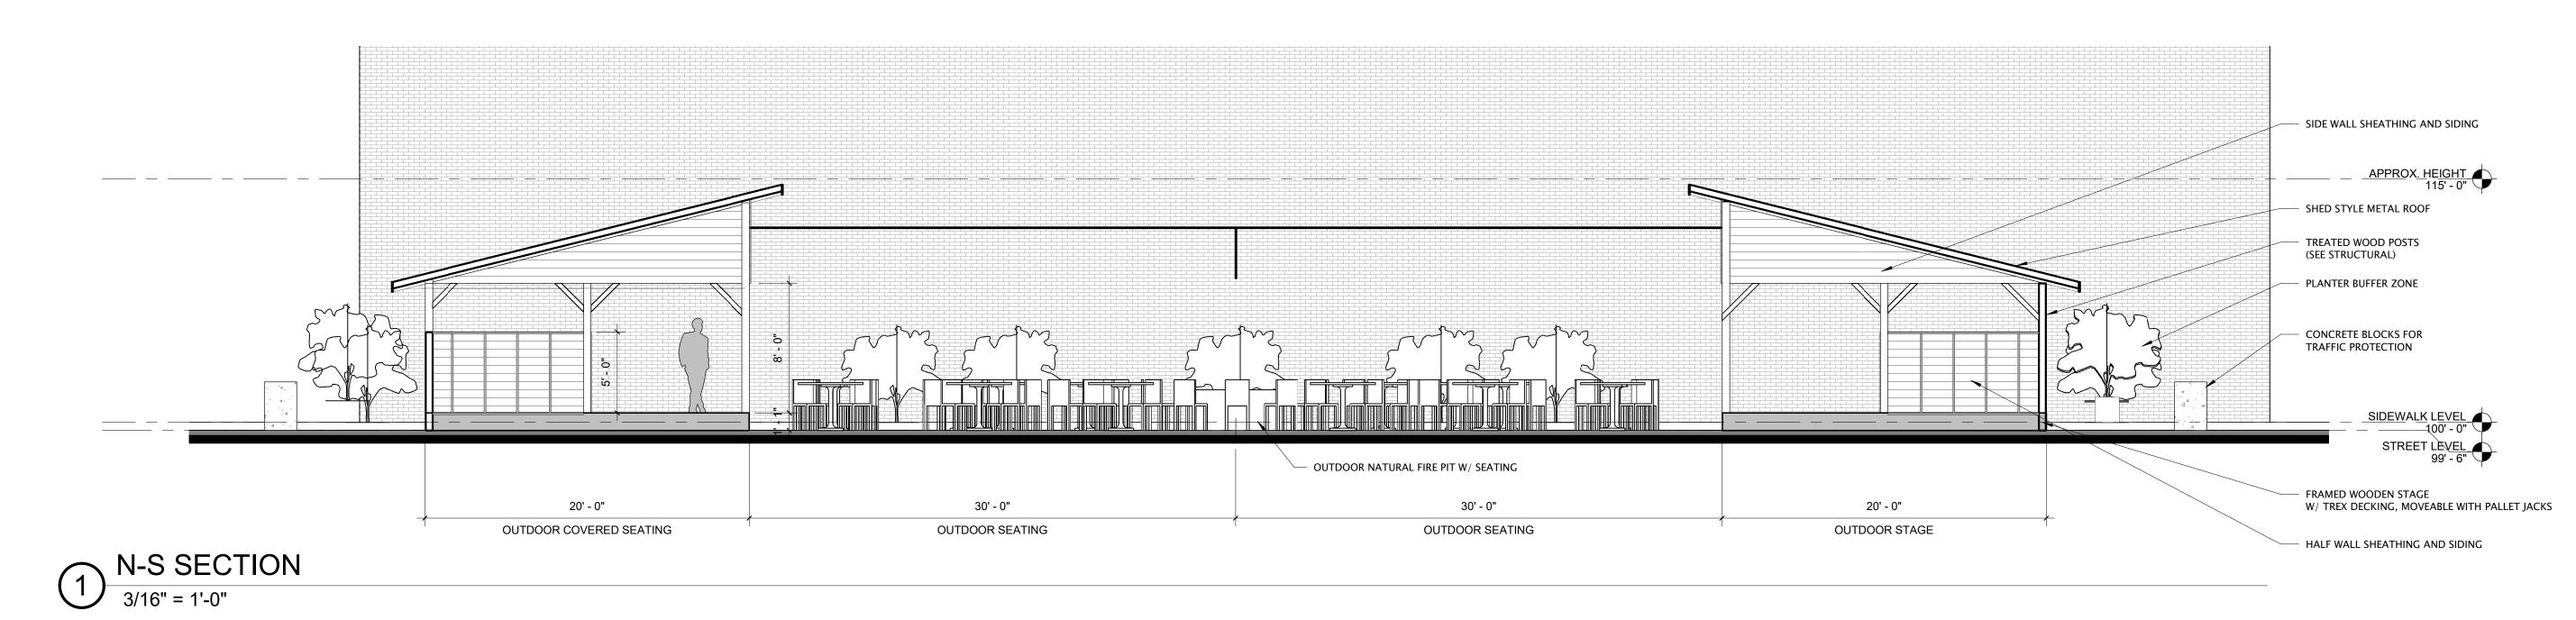

3 OUTDOOR BAR 3D

E-W SECTION

1/4" = 1'-0"

INFORMATION

PROJECT DESIGNER: UTTECH DESIGN LLC PROJECT MANAGER: 23_1001 PROJECT NUMBER: ISSUED FOR: PERMIT AND CONSTRUCTION 01.12.24 DATE:

SHEET

BUILDING SECTIONS

GENERAL	WOOD FRAMING
ALL MATERIALS, CONSTRUCTION, PLANS AND DETAILS SHALL CONFORM WITH THE APPLICABLE CODES AND STANDARDS AS SHOWN IN THESE DRAWINGS AS WELL AS THE PROJECT SPECIFICATIONS, FIRE UNDERWRITER RULES AND REGULATIONS AND ASTM STANDARDS RELATED TO EACH ELEMENT. 2. THE GENERAL CONTRACTOR AND ALL SUBCONTRACTORS SHALL BE FAMILIAR WITH THE ENTIRE SET OF CONSTRUCTION DOCUMENTS (NOT LIMITED TO CIVIL, ARCHTECTURAL, PLUMBING, ELECTRICAL, STRUCTURAL, AND MECHANICAL, ETC.) IN ORDER TO PROVIDE ALL CONSTRUCTION AND MATERIALS FOR THE PROJECT. 3. THE CONTRACTOR SHALL REFER TO ALL DRAWINGS OF THE CONSTRUCTION DOCUMENTS FOR ADDITIONAL SPECIFIED ITEMS SUCH AS MEMBERS, ELEVATIONS, BRICK LEDGES, DIMENSIONS, SLEEVES, PENETRATIONS, DEPRESSIONS, ETC. NOT SHOWN ON THE STRUCTURAL DRAWINGS THAT MAY BE REQUIRED FOR COMPLETION OF THE PROJECT. 4. CONTRACTOR SHALL VERIEY ALL DIMENSIONS AND ELEVATIONS PRIOR TO CONSTRUCTION. ANY DISCREPANCIES SHALL BE BROUGHT TO THE IMMEDIATE ATTENTION OF THE ARCHITECT AND STRUCTURAL ENGINEER. 5. DETAILS SHOWN ON THE STRUCTURAL DRAWINGS SHALL BE DUPLICATED IN SIMILAR PORTIONS OF THE BUILDING UNLESS NOTED OTHERWISE. 6. DRAWINGS REPRESENT THE FINSHED STRUCTURAL SYSTEM AND DO NOT INDICATE THE METHOD OF CONSTRUCTION. THE CONTRACTOR SHALL BE SOLELY RESPONSIBLE FOR CONSTRUCTION MEANS AND METHODS, TECHNIQUES, SEQUENCES, PROCEDURES, LAGGING, SHORING, BRACING, FORM WORK, ETC. AS REQUIRED FOR THE PROTECTION AND SAFETY OF LIFE AND PROPERTY DURING CONSTRUCTION. DISSERVATION VISITS TO THE SITE BY THE ARCHITECT OR STRUCTURAL ENGINEER WILL NOT INVOLVE REVIEW OF THESE ITEMS. 7. ALL INSPECTIONS REQUIRED BY THE BUILDING CODES, JURISDICTION OR THESE PLANS SHALL BE PROVIDED BY AN INDEPENDENT INSPECTION AGENCY OR THE BUILDING DEPARTMENT. SITE VISITS BY THE SITE BY THE ARCHITECT OR STRUCTURAL ENGINEER WILL NOT INVOLVE REVIEW OF THESE ITEMS. 7. ALL INSPECTION RECOURSE. SHALL SEPENDATION SCONGERMING THE HEALTH AND SAFETY OF WORKERS AND THE PUBLIC IN AND AROUND THE CONSTRUCTION SITE. 8. CONTRACTION DESERVATION VISITS TO THE SITE BY THE	1. DESIGN, FABRICATION AND CONSTRUCTION SHALL CONFORM TO THE "NATIONAL DESIGN SPECIFICATION (NDS) FOR WOOD CONSTRUCTION" BY THE AMERICAN WOOD COUNCIL. 2. ALL LUMBER SHALL BE PROPERLY IDENTIFIED WITH A GRADE MARK OF A LUMBER INSPECTION AGENCY COMPLYING WITH DOC PS20 "AMERICAN SOFTWOOD LUMBER STANDARD." 3. ALL SHEATHING SHALL CONFORM TO VOLUNTARY PRODUCT STANDARD PS 1 INITIATED BY APA — THE ENGINEERED WOOD ASSOCIATION AND DEVELOPED UNDER THE "PROCEDURES FOR THE DEVELOPMENT OF VOLUNTARY PRODUCT STANDARDS" OF THE US DEPARTMENT OF COMMERCE. SHEATHING SHALL BE APA RARED AND BEAR THE APA MARK OF OUALITY AS WELL AS GLUE TYPE. 4. ARCHITECT AND CONTRACTOR SHALL DETAIL AND CONSTRUCT BUILDING FINISHES TO ACCOMMODATE AN EXPECTED BUILDING SHRINKAGE OF UP TO 3/8" PER FLOOR OF WOOD FRAMED CONSTRUCTION. PROPER CARE SHALL BE TAKE TO PROTECT STORED AND CONSTRUCTED LUMBER FROM THE ELEMENTS. IN NO CASE SHALL LUMBER BE ALLOWED TO REST IN STANDING WATER. 5. ROOF AND FLOOR SHEATHING SHALL BE LAID WITH THE LONG DIMENSION PERPENDICULAR TO FRAMING MEMBERS. SHEATHING (WALL, ROOF AND FLOOR) SHALL BE ATTACHED TO FRAMING MEMBERS WITH 10d NAILS SPACED AT 6" 0/6 AT PANEL EDGES AND 12" 0/6 IN THE FIELD. 6. WOOD SHEATHED SHEAR WALLS REQUIRE PANEL EDGES TO BE BLOCKED FOR ATTACHED TO FRAMING MEMBERS WITH 10d NAILS SPACED AT 6" 0/6 AT PANEL EDGES AND 12" 0/6 IN THE FIELD. 7. SHEATHING PANEL EDGES SHALL BEAR ON FRAMING MEMBERS. FASTENERS SHALL BE PLACED NO CLOSER THAN 3/8" TO THE PANEL EDGE. 8. SHEATHING SUBJECTED TO EXTERIOR ELEMENTS OR OTHERWISE EXPOSED TO PERMANENT MOISTURE CONDITIONS SHALL BE PRESERVATIVE-TREATED. 9. WOOD MEMBERS DIRECTLY EXPOSED TO MOISTURE OR BEARING ON CONCRETE OR MASONRY THAT IS IN DIRECT CONTACT WITH EARTH SHALL BE PRESERVATIVE-TREATED. 10. LUMBER, TIMBER, PLYWOOD, PILES AND POLES SUPPORTING PERMANENT STRUCTURES REQUIRED TO BE PRESERVATIVE-TREATED SHALL CONFORM TO THE FASTENING SCHEDULE LISTED TO BE PRESERVATIVE-TREATED SHALL CONFORM TO THE FASTENING SCHEDULE LISTED IN 180 C HAPTER 23. 11. MAXIMUM MOISTURE CONTENT
SHOP DRAWINGS	LATERAL AND SEISMIC LOADS SHALL BE USED. TEMPORARY BRACING IS THE RESPONSIBILITY OF THE CONTRACTOR.

SHOP DRAWINGS SHALL BE SUBMITTED FOR ALL STRUCTURAL ITEMS IN ADDITION TO ITEMS REQUIRED BY PROJECT SPECIFICATIONS.

3. ANY CHANGES, SUBSTITUTIONS, OR DEVIATIONS FROM THE CONTRACT

2. THE CONTRACTOR SHALL REVIEW AND STAMP ALL SHOP DRAWINGS PRIOR TO SUBMITTING TO THE ARCHITECT. ITEMS NOT IN CONFORMANCE WITH THE CONTRACT DOCUMENTS SHALL BE NOTED UPON CONTRACTOR'S REVIEW.

DOCUMENTS SHALL BE CLOUDED BY THE MANUFACTURER OR FABRICATOR. ANY
OF THE AFOREMENTIONED ITEMS THAT ARE NOT CLOUDED OR NOTED BY SUBMITTING PARTIES, SHALL NOT BE CONSIDERED APPROVED AFTER ENGINEER'S REVIEW UNLESS NOTED ACCORDINGLY.

4. THE ENGINEER HAS THE RIGHT TO APPROVE OR DISAPPROVE ANY CHANGES TO CONTRACT DOCUMENTS AT ANYTIME BEFORE OR AFTER SHOP DRAWING REVIEW.

5. THE SHOP DRAWINGS DO NOT REPLACE THE CONTRACT DOCUMENTS. ITEMS OMITTED OR SHOWN INCORRECTLY AND ARE NOT FLAGGED BY THE STRUCTURAL OR ARCHITECT SHALL NOT BE CONSIDERED CHANGES TO THE CONTRACT DOCUMENTS. IT IS THE CONTRACTOR'S RESPONSIBILITY TO ENSURE THAT ITEMS ARE CONSTRUCTED IN ACCORDANCE WITH THE CONTRACT DOCUMENTS.

6. THE ADEQUACY OF ENGINEERING DESIGNS AND LAYOUT PERFORMED BY OTHERS RESTS WITH THE DESIGNING OR SUBMITTING AUTHORITY.

7. REVIEWING IS INTENDED ONLY AS AN AID TO THE CONTRACTOR IN OBTAINING CORRECT SHOP DRAWINGS. RESPONSIBILITY FOR THE CORRECTNESS SHALL REST WITH THE CONTRACTOR.

BUILDING CODE							
CODE INTERNATIONAL BUILDING CODE 2015							
GRAVITY SYSTEM							
ELEMENT ROOF	DEAD LOA	\D		LIVE LOAD TO SNOW LOAD			
FL00R	12 PSF		NEFEN	100 PSF			
SN	IOW CRITE	RIA					
CODE INFORMATION	DESIGN INFORMATION						
DESIGN SNOW LOAD FLAT ROOF SNOW LOAD	26 PSF PLUS DRIFT 25.2 PSF	WHERE INDIC	CATED				
SNOW EXPOSURE FACTOR	Ce = 1.0						
SNOW IMPORTANCE FACTOR	Is = 1.0						
THERMAL FACTOR GROUND SNOW	Ct = 1.2 Pg = 30 PSF						
RAIN ON SNOW SURCHAGE	0 PSF						
SLOPED ROOF FACTOR	Cs = 1.0						
WIND CRITERIA							
CODE INFORMATION	DESIGN INFORMATION						
BASIC WIND SPEED (3 SECOND GUST)	115 MPH (ULTIMATE	=)					
WIND DIRECTIONALITY FACTOR MEAN ROOF HEIGHT	Kd = 0.85						
WIND IMPORTANCE FACTOR	Iw=1.0						
WIND OCCUPANCY CATEGORY	II						
WIND EXPOSURE CATEGORY INTERNAL PRESSURE COEFFICIENT	B GCPI = +-0.00						
TOPOGRAPHIC FACTOR	Kzt = 1.0						
DESIGN PROCEDURE	SIMPLE DIAPHRAGM	1					
ROOF SURFACE V							
AREA NEGATIVE ZONE 1 & 2E	10 SF -40.3 PSF	-23.1		100 SF -16.0 PSF			
NEGATIVE ZONE 2N, 2R, & 3E	-60.5 PSF	-40.3		-31.6 PSF			
NEGATIVE ZONE 3R	-72.6 PSF	-47.2		-36.3 PSF			
POSTIIVE ALL ZONES OVERHANG ZONE 1 & 2E	16.0 PSF -50.4 PSF	16.0 -38.9		16.0 PSF -30.2 PSF			
OVERHANG ZONE 1 & 2E	-70.6 PSF	-55.4		-48.9 PSF			
OVERHANG ZONE 3E	-82.7 PSF	-56.5		-45.2 PSF			
OVERHANG ZONE 3R	-94.8 PSF	-60.9	PSF	-46.4 PSF			
WALL SURFACE V	WIND PRES	SSURE	S UL	TIMATE			
AREA	10 SF	100		500 SF			
NEGATIVE ZONE 4 NEGATIVE ZONE 5	-18.1PSF -36.3 PSF	-16.1 -28.2		-16.0 PSF -20.2 PSF			
POSTIVE ZONE 4 AND 5	18.1 PSF	16.0		16.0 PSF			
SEI	SMIC CRIT	ERIA					
CODE INFORMATION		DESIGN INF	ORMATION				
SEISMIC IMPORTANCE FACTOR		I - 1.0					
OCCUPANCY CATEGORY		II	.,				
MAPPED SPECTRAL RESPONSE ACCELERA MAPPED SPECTRAL RESPONSE ACCELERA		Ss = 8.809 S1 = 4.709					
SITE CLASS	THON (LUNG)	D D	νug				
SPECTRAL RESPONSE COEFFICIENT (SHOP	RT)	SDS = 0.0	94				
SPECTRAL RESPONSE COEFFICIENT (LONG	G)	SD1 = 0.0	75				
SEISMIC DESIGN CATEGORY BASIC SEISMIC FORCE RESISTING SYSTEM	1	B TIMBER FR	AMES				
DESIGN BASE SHEAR	•	0.031W	, IIVILU				
SEISMIC RESPONSE COEFFICIENT		Cs = 0.03	1				
RESPONSE MODIFICATION FACTOR		3	IT I ATES	FODOE ANALYSIS			
ANALYSIS PROCEDURE		EQUIVALEN	II LATÉRAL	FORCE ANALYSIS			

DESIGN INFORMATION

W	OOD DESIGN STRENGTHS	
ASDF	STRENGTH	
WOOD:		
DIMENSIONAL LUMBER:		
JOISTS/BEAMS/HEADERS	SPRUCE PINE FIR NO. 2 OR BETTER	
EXTERIOR LUMBER/MUDSILL	TREATED SOUTHERN PINE NO. 2 OR BETTER	
WALL STUDS/PLATES	SPRUCE PINE FIR NO. 2 OR BETTER	
LAMINATED VENEER LUMBER (LVL):		
FRAMING	2.0 E	
	2,600 psi Fb	
LAMINATED STRAND LUMBER (LSL):		
STUD	1.55 E	
	2,170 psi Fc PARALLEL	
PLATE	1.3 E	
	670 psi Fc PERPENDICULAR	
PARALLEL STRAND LUMBER (PSL):		
POST	1.8 E	
	2,500 psi Fc PARALLEL	
LUMBER POSTS:		
EXTERIOR	TREATED SOUTHERN PINE NO.1/NO.2 OR BETTER	
INTERIOR	SPRUCE PINE FIR NO.1/NO.2 OR BETTER	

WOOD POST SCHEDULE							
MARK	SIZE	MATERIAL	COMMENTS				
WP8	8"x8"	TREATED SOUTHERN PINE NO.1/NO.2 OR BETTER	REST ON BEAM BELOW. NO POST BASE				



MADISON / MILWAUKEE Tel: 414.255.4600



PROJECT

THE DECO EXTERIOR SPACE

7140 W. GREENFIELD WEST ALLIS, WISCONSIN

OWNER

WALLY HOLTZ

REVISIONS


DESCRIPTION

PROJECT DESIGNER: UTTECH DESIGN LLC PROJECT MANAGER: PROJECT NUMBER: ISSUED FOR: DATE: 01.12.24

SHEET

GENERAL STRUCTURAL NOTES


INIT	CODE	0005 0045	
INII	ERNATIONAL BUILDING	CODE 2015	
G	RAVITY SY	STEM	
ELEMENT	DEAD LO		LIVE LOAD
R00F	15 PS		REFER TO SNOW LOA
FLOOR	SNOW CRIT		100 PSF
CODE INFORMATION	DESIGN INFORMA		
DESIGN SNOW LOAD		TION T WHERE INDICATED	 D
FLAT ROOF SNOW LOAD	25.2 PSF		
SNOW EXPOSURE FACTOR	Ce = 1.0		
SNOW IMPORTANCE FACTOR	Is = 1.0		
THERMAL FACTOR GROUND SNOW	Ct = 1.2 Pg = 30 PSF		
RAIN ON SNOW SURCHAGE	0 PSF		
SLOPED ROOF FACTOR	Cs = 1.0		
\	WIND CRITI	ERIA	
CODE INFORMATION	DESIGN INFORMA	TION	
BASIC WIND SPEED (3 SECOND GUST)	115 MPH (ULTIMA	TE)	
WIND DIRECTIONALITY FACTOR	Kd = 0.85		
MEAN ROOF HEIGHT	11 FT		
WIND IMPORTANCE FACTOR WIND OCCUPANCY CATEGORY	Iw=1.0		
WIND EXPOSURE CATEGORY	В		
INTERNAL PRESSURE COEFFICIENT	GCPI = +-0.00		
TOPOGRAPHIC FACTOR	Kzt = 1.0		
DESIGN PROCEDURE	SIMPLE DIAPHRAC	GM	
ROOF SURFACE	WIND PRE	SSURES 50 SF	ULTIMATE 100 SF
			100 SF
AREA NEGATIVE ZONE 1 & 2E	10 SF	50 SF -23.1 PSF -40.3 PSF	100 SF -16.0 PS -31.6 PS
AREA NEGATIVE ZONE 1 & 2E NEGATIVE ZONE 2N, 2R, & 3E NEGATIVE ZONE 3R	10 SF -40.3 PSF -60.5 PSF -72.6 PSF	50 SF -23.1 PSF -40.3 PSF -47.2 PSF	100 SF -16.0 PS -31.6 PS -36.3 PS
AREA NEGATIVE ZONE 1 & 2E NEGATIVE ZONE 2N, 2R, & 3E NEGATIVE ZONE 3R POSTIIVE ALL ZONES	10 SF -40.3 PSF -60.5 PSF -72.6 PSF 16.0 PSF	50 SF -23.1 PSF -40.3 PSF -47.2 PSF 16.0 PSF	100 SF -16.0 PS -31.6 PS -36.3 PS 16.0 PSI
AREA NEGATIVE ZONE 1 & 2E NEGATIVE ZONE 2N, 2R, & 3E NEGATIVE ZONE 3R POSTIIVE ALL ZONES OVERHANG ZONE 1 & 2E	10 SF -40.3 PSF -60.5 PSF -72.6 PSF 16.0 PSF -50.4 PSF	50 SF -23.1 PSF -40.3 PSF -47.2 PSF 16.0 PSF -38.9 PSF	100 SF -16.0 PS -31.6 PS -36.3 PS 16.0 PSF -30.2 PS
AREA NEGATIVE ZONE 1 & 2E NEGATIVE ZONE 2N, 2R, & 3E NEGATIVE ZONE 3R POSTIIVE ALL ZONES OVERHANG ZONE 1 & 2E OVERHANG ZONE 2N & 2R	10 SF -40.3 PSF -60.5 PSF -72.6 PSF 16.0 PSF -50.4 PSF -70.6 PSF	50 SF -23.1 PSF -40.3 PSF -47.2 PSF 16.0 PSF -38.9 PSF -55.4 PSF	100 SF -16.0 PS -31.6 PS -36.3 PS 16.0 PSF -30.2 PS -48.9 PS
AREA NEGATIVE ZONE 1 & 2E NEGATIVE ZONE 2N, 2R, & 3E NEGATIVE ZONE 3R POSTIIVE ALL ZONES OVERHANG ZONE 1 & 2E	10 SF -40.3 PSF -60.5 PSF -72.6 PSF 16.0 PSF -50.4 PSF	50 SF -23.1 PSF -40.3 PSF -47.2 PSF 16.0 PSF -38.9 PSF	100 SF -16.0 PS -31.6 PS -36.3 PS 16.0 PSF -30.2 PS -48.9 PS
AREA NEGATIVE ZONE 1 & 2E NEGATIVE ZONE 2N, 2R, & 3E NEGATIVE ZONE 3R POSTIIVE ALL ZONES OVERHANG ZONE 1 & 2E OVERHANG ZONE 2N & 2R OVERHANG ZONE 3E OVERHANG ZONE 3R	10 SF -40.3 PSF -60.5 PSF -72.6 PSF 16.0 PSF -50.4 PSF -70.6 PSF -82.7 PSF -94.8 PSF	50 SF -23.1 PSF -40.3 PSF -47.2 PSF 16.0 PSF -38.9 PSF -55.4 PSF -56.5 PSF -60.9 PSF	100 SF -16.0 PS -31.6 PS -36.3 PS 16.0 PSF -30.2 PS -48.9 PS -45.2 PS -46.4 PS
AREA NEGATIVE ZONE 1 & 2E NEGATIVE ZONE 2N, 2R, & 3E NEGATIVE ZONE 3R POSTIIVE ALL ZONES OVERHANG ZONE 1 & 2E OVERHANG ZONE 2N & 2R OVERHANG ZONE 3E	10 SF -40.3 PSF -60.5 PSF -72.6 PSF 16.0 PSF -50.4 PSF -70.6 PSF -82.7 PSF -94.8 PSF	50 SF -23.1 PSF -40.3 PSF -47.2 PSF 16.0 PSF -38.9 PSF -55.4 PSF -56.5 PSF -60.9 PSF	100 SF -16.0 PS -31.6 PS -36.3 PS 16.0 PSF -30.2 PS -48.9 PS -45.2 PS -46.4 PS
AREA NEGATIVE ZONE 1 & 2E NEGATIVE ZONE 2N, 2R, & 3E NEGATIVE ZONE 2N, 2R, & 3E NEGATIVE ZONE 3R POSTIIVE ALL ZONES OVERHANG ZONE 1 & 2E OVERHANG ZONE 2N & 2R OVERHANG ZONE 3E OVERHANG ZONE 3R WALL SURFACE	10 SF -40.3 PSF -60.5 PSF -72.6 PSF 16.0 PSF -50.4 PSF -70.6 PSF -82.7 PSF -94.8 PSF	50 SF -23.1 PSF -40.3 PSF -47.2 PSF 16.0 PSF -38.9 PSF -55.4 PSF -56.5 PSF -60.9 PSF	100 SF -16.0 PSi -31.6 PSi -36.3 PSi 16.0 PSF -30.2 PSi -48.9 PSi -45.2 PSi -46.4 PSi
AREA NEGATIVE ZONE 1 & 2E NEGATIVE ZONE 2N, 2R, & 3E NEGATIVE ZONE 3R POSTIIVE ALL ZONES OVERHANG ZONE 1 & 2E OVERHANG ZONE 3E OVERHANG ZONE 3E OVERHANG ZONE 3R WALL SURFACE AREA NEGATIVE ZONE 4 NEGATIVE ZONE 5	10 SF -40.3 PSF -60.5 PSF -72.6 PSF 16.0 PSF -50.4 PSF -70.6 PSF -82.7 PSF -94.8 PSF WIND PRE 10 SF -18.1PSF -36.3 PSF	50 SF -23.1 PSF -40.3 PSF -47.2 PSF 16.0 PSF -38.9 PSF -55.4 PSF -56.5 PSF -60.9 PSF SSURES 100 SF -16.1 PSF -28.2 PSF	100 SF -16.0 PSi -31.6 PSi -36.3 PSi 16.0 PSF -30.2 PSi -48.9 PSi -45.2 PSi -46.4 PSi 500 SF -16.0 PSi -20.2 PSi
AREA NEGATIVE ZONE 1 & 2E NEGATIVE ZONE 2N, 2R, & 3E NEGATIVE ZONE 3R POSTIIVE ALL ZONES OVERHANG ZONE 1 & 2E OVERHANG ZONE 2N & 2R OVERHANG ZONE 3E OVERHANG ZONE 3R WALL SURFACE AREA NEGATIVE ZONE 4	10 SF -40.3 PSF -60.5 PSF -72.6 PSF 16.0 PSF -50.4 PSF -70.6 PSF -82.7 PSF -94.8 PSF WIND PRE	50 SF -23.1 PSF -40.3 PSF -47.2 PSF 16.0 PSF -38.9 PSF -56.5 PSF -60.9 PSF SSURES 100 SF -16.1 PSF	100 SF -16.0 PSi -31.6 PSi -36.3 PSi 16.0 PSi -30.2 PSi -48.9 PSi -45.2 PSi -46.4 PSi 500 SF -16.0 PSi
AREA NEGATIVE ZONE 1 & 2E NEGATIVE ZONE 2N, 2R, & 3E NEGATIVE ZONE 3R POSTIIVE ALL ZONES OVERHANG ZONE 1 & 2E OVERHANG ZONE 3E OVERHANG ZONE 3E OVERHANG ZONE 3R WALL SURFACE AREA NEGATIVE ZONE 4 NEGATIVE ZONE 5 POSTIVE ZONE 4 AND 5	10 SF -40.3 PSF -60.5 PSF -72.6 PSF 16.0 PSF -50.4 PSF -70.6 PSF -82.7 PSF -94.8 PSF WIND PRE 10 SF -18.1PSF -36.3 PSF	50 SF -23.1 PSF -40.3 PSF -47.2 PSF 16.0 PSF -38.9 PSF -56.5 PSF -60.9 PSF SSURES 100 SF -16.1 PSF -28.2 PSF 16.0 PSF	100 SF -16.0 PS -31.6 PS -36.3 PS 16.0 PSI -30.2 PS -48.9 PS -45.2 PS -46.4 PS ULTIMATI 500 SF -16.0 PSI -20.2 PS
AREA NEGATIVE ZONE 1 & 2E NEGATIVE ZONE 2N, 2R, & 3E NEGATIVE ZONE 3R POSTIIVE ALL ZONES OVERHANG ZONE 1 & 2E OVERHANG ZONE 2N & 2R OVERHANG ZONE 3E OVERHANG ZONE 3R WALL SURFACE AREA NEGATIVE ZONE 4 NEGATIVE ZONE 4 NEGATIVE ZONE 4 AND 5 CODE INFORMATION	10 SF -40.3 PSF -60.5 PSF -72.6 PSF 16.0 PSF -50.4 PSF -70.6 PSF -82.7 PSF -94.8 PSF WIND PRE 10 SF -18.1PSF -36.3 PSF 18.1 PSF	50 SF -23.1 PSF -40.3 PSF -47.2 PSF 16.0 PSF -38.9 PSF -55.4 PSF -56.5 PSF -60.9 PSF SSURES 100 SF -16.1 PSF -28.2 PSF 16.0 PSF TERIA	100 SF -16.0 PS -31.6 PS -36.3 PS 16.0 PSI -30.2 PS -48.9 PS -45.2 PS -46.4 PS ULTIMATI 500 SF -16.0 PSI -20.2 PS 16.0 PSI
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AREA NEGATIVE ZONE 1 & 2E NEGATIVE ZONE 2N, 2R, & 3E NEGATIVE ZONE 2N, 2R, & 3E NEGATIVE ZONE 3R POSTIIVE ALL ZONES OVERHANG ZONE 1 & 2E OVERHANG ZONE 2N & 2R OVERHANG ZONE 3E OVERHANG ZONE 3R WALL SURFACE AREA NEGATIVE ZONE 4 NEGATIVE ZONE 4 NEGATIVE ZONE 4 AND 5 CODE INFORMATION SEISMIC IMPORTANCE FACTOR OCCUPANCY CATEGORY	10 SF -40.3 PSF -60.5 PSF -72.6 PSF 16.0 PSF -50.4 PSF -70.6 PSF -82.7 PSF -94.8 PSF 10 SF -18.1 PSF -36.3 PSF 18.1 PSF	50 SF -23.1 PSF -40.3 PSF -47.2 PSF 16.0 PSF -38.9 PSF -56.5 PSF -60.9 PSF ESSURES 100 SF -16.1 PSF -28.2 PSF 16.0 PSF TERIA	100 SF -16.0 PSI -31.6 PS -36.3 PS 16.0 PSF -30.2 PS -48.9 PS -45.2 PS -46.4 PSI 500 SF -16.0 PSI -20.2 PSI 16.0 PSI
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AREA NEGATIVE ZONE 1 & 2E NEGATIVE ZONE 2N, 2R, & 3E NEGATIVE ZONE 3R POSTIIVE ALL ZONES OVERHANG ZONE 1 & 2E OVERHANG ZONE 1 & 2E OVERHANG ZONE 3E OVERHANG ZONE 3E OVERHANG ZONE 3R WALL SURFACE AREA NEGATIVE ZONE 4 NEGATIVE ZONE 5 POSTIVE ZONE 4 AND 5 CODE INFORMATION SEISMIC IMPORTANCE FACTOR OCCUPANCY CATEGORY MAPPED SPECTRAL RESPONSE ACCELI SITE CLASS	10 SF -40.3 PSF -60.5 PSF -72.6 PSF 16.0 PSF -50.4 PSF -70.6 PSF -82.7 PSF -94.8 PSF **** *****************************	50 SF -23.1 PSF -40.3 PSF -47.2 PSF 16.0 PSF -55.4 PSF -56.5 PSF -60.9 PSF ESSURES 100 SF -16.1 PSF -28.2 PSF 16.0 PSF TERIA DESIGN INFORM I - 1.0 II SS = 8.80%g S1 = 4.70%g	100 SF -16.0 PS -31.6 PS -36.3 PS 16.0 PSI -30.2 PS -48.9 PS -45.2 PS -46.4 PS ULTIMATI 500 SF -16.0 PSI -20.2 PS 16.0 PSI
AREA NEGATIVE ZONE 1 & 2E NEGATIVE ZONE 2N, 2R, & 3E NEGATIVE ZONE 3R POSTIIVE ALL ZONES OVERHANG ZONE 1 & 2E OVERHANG ZONE 1 & 2E OVERHANG ZONE 3E OVERHANG ZONE 3R WALL SURFACE AREA NEGATIVE ZONE 4 NEGATIVE ZONE 4 NEGATIVE ZONE 4 AND 5 CODE INFORMATION SEISMIC IMPORTANCE FACTOR OCCUPANCY CATEGORY MAPPED SPECTRAL RESPONSE ACCELIMAPPED SPECTRAL RESPONSE ACCELIMANCE PACCELIMA PLANCE PACCELIMA PACCELIMANCE PACCELIMA	10 SF -40.3 PSF -60.5 PSF -72.6 PSF 16.0 PSF -50.4 PSF -70.6 PSF -82.7 PSF -94.8 PSF ***CWIND PRE 10 SF -18.1 PSF -36.3 PSF 18.1 PSF ***EISMIC CRI ***EERATION (SHORT) ***ERATION (LONG)	50 SF -23.1 PSF -40.3 PSF -47.2 PSF 16.0 PSF -55.4 PSF -56.5 PSF -60.9 PSF ESSURES 100 SF -16.1 PSF -28.2 PSF 16.0 PSF TERIA DESIGN INFORM I - 1.0 II SS = 8.80%g S1 = 4.70%g D	100 SF -16.0 PS -31.6 PS -36.3 PS 16.0 PSI -30.2 PS -48.9 PS -45.2 PS -46.4 PS ULTIMATI 500 SF -16.0 PSI -20.2 PS 16.0 PSI
AREA NEGATIVE ZONE 1 & 2E NEGATIVE ZONE 2N, 2R, & 3E NEGATIVE ZONE 2N, 2R, & 3E NEGATIVE ZONE 3R POSTIIVE ALL ZONES OVERHANG ZONE 1 & 2E OVERHANG ZONE 3E OVERHANG ZONE 3E OVERHANG ZONE 3R WALL SURFACE AREA NEGATIVE ZONE 4 NEGATIVE ZONE 5 POSTIVE ZONE 4 AND 5 CODE INFORMATION SEISMIC IMPORTANCE FACTOR OCCUPANCY CATEGORY MAPPED SPECTRAL RESPONSE ACCELI MAPPED SPECTRAL RESPONSE ACCELI SITE CLASS SPECTRAL RESPONSE COEFFICIENT (SH	10 SF -40.3 PSF -60.5 PSF -72.6 PSF 16.0 PSF -50.4 PSF -70.6 PSF -82.7 PSF -94.8 PSF ***CWIND PRE 10 SF -18.1 PSF -36.3 PSF 18.1 PSF ***EISMIC CRI ***EERATION (SHORT) ***ERATION (LONG)	50 SF -23.1 PSF -40.3 PSF -47.2 PSF 16.0 PSF -55.4 PSF -56.5 PSF -60.9 PSF ESSURES 100 SF -16.1 PSF -28.2 PSF 16.0 PSF TERIA DESIGN INFORM I - 1.0 II SS = 8.80%g S1 = 4.70%g D SDS = 0.094	100 SF -16.0 PS -31.6 PS -36.3 PS 16.0 PSI -30.2 PS -48.9 PS -45.2 PS -46.4 PS ULTIMATI 500 SF -16.0 PSI -20.2 PS 16.0 PSI
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AREA NEGATIVE ZONE 1 & 2E NEGATIVE ZONE 2N, 2R, & 3E NEGATIVE ZONE 3R POSTIIVE ALL ZONES OVERHANG ZONE 1 & 2E OVERHANG ZONE 1 & 2E OVERHANG ZONE 3E OVERHANG ZONE 3R WALL SURFACE AREA NEGATIVE ZONE 4 NEGATIVE ZONE 5 POSTIVE ZONE 4 AND 5 CODE INFORMATION SEISMIC IMPORTANCE FACTOR OCCUPANCY CATEGORY MAPPED SPECTRAL RESPONSE ACCELI MAPPED SPECTRAL RESPONSE ACCELI SITE CLASS SPECTRAL RESPONSE COEFFICIENT (SE SPECTRAL RESPONSE COEFFICIENT (LC SEISMIC DESIGN CATEGORY BASIC SEISMIC FORCE RESISTING SYST DESIGN BASE SHEAR	10 SF -40.3 PSF -60.5 PSF -72.6 PSF 16.0 PSF -50.4 PSF -70.6 PSF -82.7 PSF -94.8 PSF **NOD PRE 10 SF -18.1 PSF -36.3 PSF 18.1 PSF **EISMIC CRI **EERATION (SHORT) **ERATION (LONG)** **HORT) **DNG)	50 SF -23.1 PSF -40.3 PSF -47.2 PSF 16.0 PSF -55.4 PSF -56.5 PSF -60.9 PSF SSURES 100 SF -16.1 PSF -28.2 PSF 16.0 PSF TERIA DESIGN INFORM I - 1.0 II SS = 8.80%g S1 = 4.70%g D SDS = 0.094 SD1 = 0.075 B TIMBER FRAME 0.031W	100 SF -16.0 PS -31.6 PS -36.3 PS 16.0 PSI -30.2 PS -48.9 PS -45.2 PS -46.4 PS ULTIMATI 500 SF -16.0 PSI -20.2 PS 16.0 PSI
AREA NEGATIVE ZONE 1 & 2E NEGATIVE ZONE 2N, 2R, & 3E NEGATIVE ZONE 3R POSTIIVE ALL ZONES OVERHANG ZONE 1 & 2E OVERHANG ZONE 1 & 2E OVERHANG ZONE 3E OVERHANG ZONE 3R WALL SURFACE AREA NEGATIVE ZONE 4 NEGATIVE ZONE 5 POSTIVE ZONE 4 AND 5 CODE INFORMATION SEISMIC IMPORTANCE FACTOR OCCUPANCY CATEGORY MAPPED SPECTRAL RESPONSE ACCELI MAPPED SPECTRAL RESPONSE ACCELI SITE CLASS SPECTRAL RESPONSE COEFFICIENT (LC SEISMIC DESIGN CATEGORY BASIC SEISMIC FORCE RESISTING SYST DESIGN BASE SHEAR SEISMIC RESPONSE COEFFICIENT	10 SF -40.3 PSF -60.5 PSF -72.6 PSF 16.0 PSF -50.4 PSF -70.6 PSF -82.7 PSF -94.8 PSF **NOD PRE 10 SF -18.1 PSF -36.3 PSF 18.1 PSF **EISMIC CRI **EERATION (SHORT) **ERATION (LONG)** **HORT) **DNG)	50 SF -23.1 PSF -40.3 PSF -47.2 PSF 16.0 PSF -55.4 PSF -56.5 PSF -60.9 PSF SSURES 100 SF -16.1 PSF -28.2 PSF 16.0 PSF TERIA DESIGN INFORM I - 1.0 II SS = 8.80%g S1 = 4.70%g D SDS = 0.094 SD1 = 0.075 B TIMBER FRAME 0.031W Cs = 0.031	100 SF -16.0 PS -31.6 PS -36.3 PS 16.0 PSI -30.2 PS -48.9 PS -45.2 PS -46.4 PS ULTIMATI 500 SF -16.0 PSI -20.2 PS 16.0 PSI
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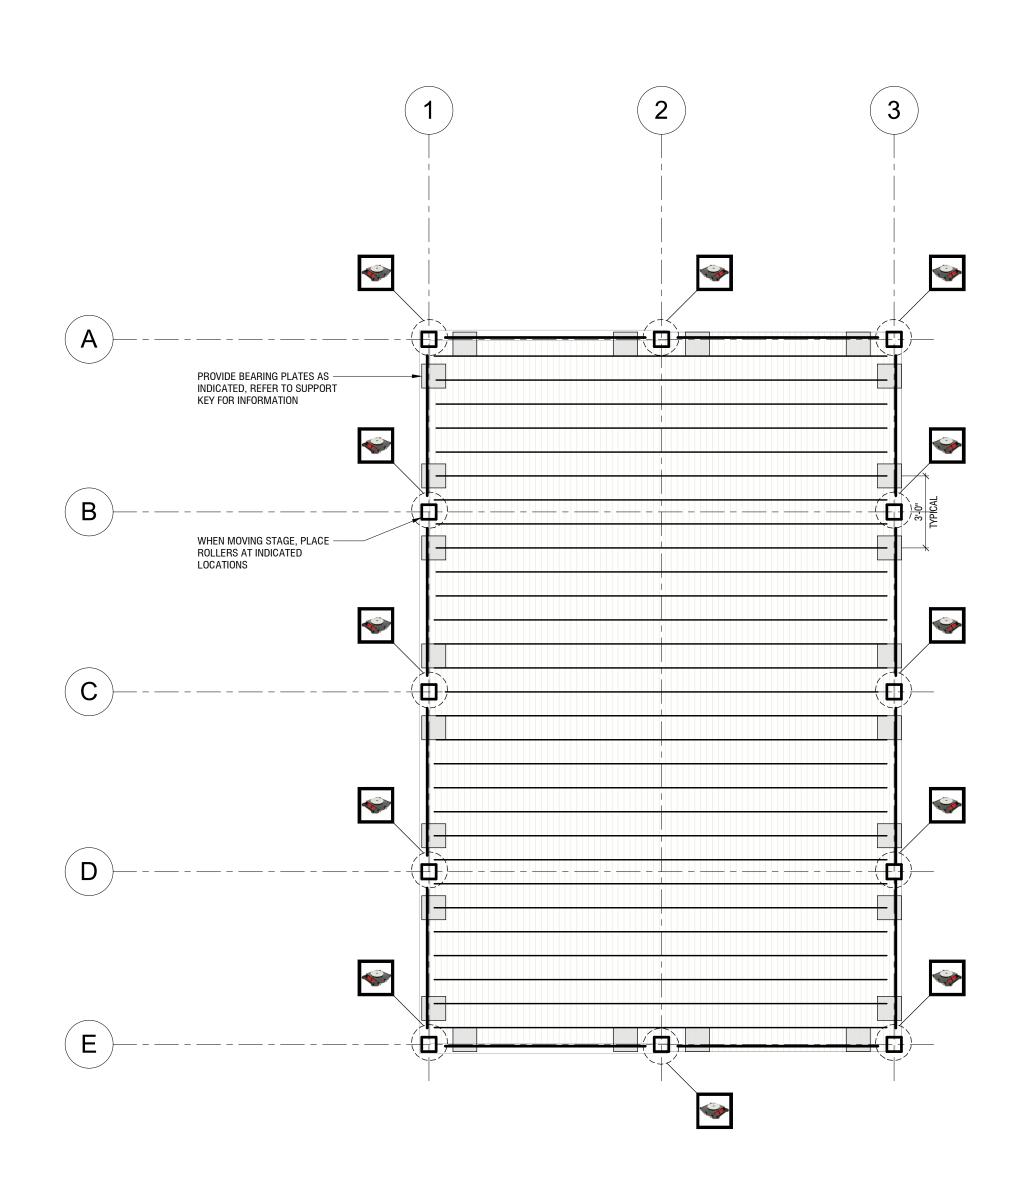


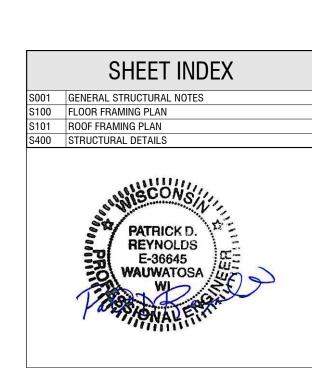
INFORMATION

MJU 23_1001 SCHEMATIC DESIGN


DATE



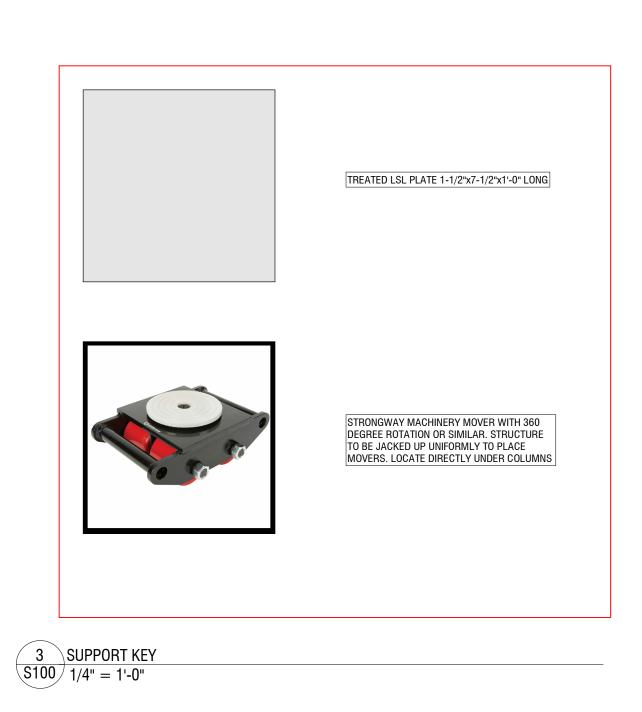

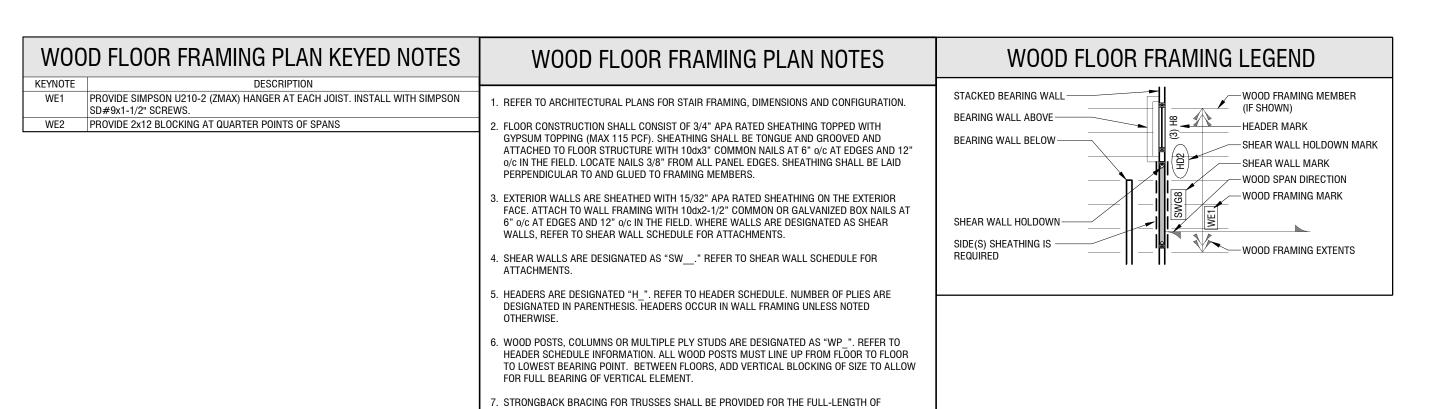

BUILDING. REFER TO TRUSS ERECTION DRAWINGS.

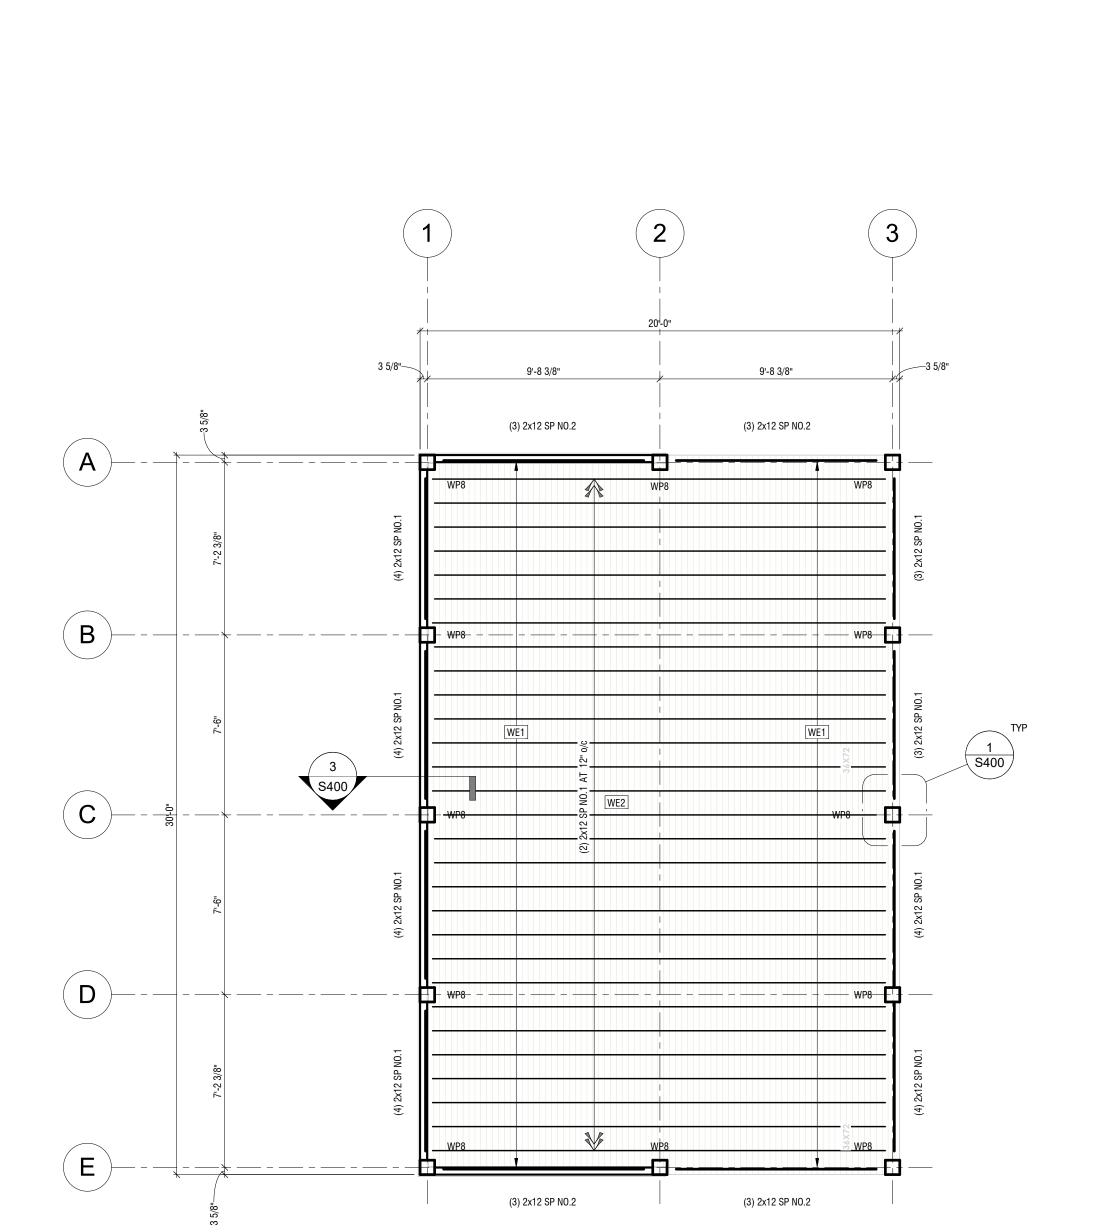



MADISON / MILWAUKEE Tel: 414.255.4600



PROJECT

THE DECO EXTERIOR SPACE

7140 W. GREENFIELD WEST ALLIS, WISCONSIN

OWNER

WALLY HOLTZ

REVISIONS

O. DESCRIPTION

INFORMATION

PROJECT DESIGNER:	UTTECH DESIGN LLC
PROJECT MANAGER:	Autho
PROJECT NUMBER:	23_1001
ISSUED FOR:	SCHEMATIC DESIGN
DATE:	01.12.24

SHEET

FLOOR FRAMING PLAN

S100

DATE

WOOD ROOF FRAMING PLAN KEYED NOTES WOOD ROOF FRAMING PLAN NOTES WOOD ROOF FRAMING LEGEND KEYNOTE DESCRIPTION

WR3 PROVIDE SIMPSON CCQ5-8SDS POST CAP USING (16) 1/4"x2-1/2" SDS SCREWS INTO BEAM AND (14) 1/4"x2-1/2" SDS SCREWS INTO THE POST. TYP. BEARING WALL BELOW--WOOD FRAMING MEMBER I. REFER TO ARCHITECTURAL PLANS FOR ROOF TRUSS BEARING LOCATION. (IF SHOWN) HEADER MARK 2. PROVIDE 3/4" APA RATED ROOF SHEATHING ATTACHED TO EACH FRAMING MEMBER WITH 2. PROVIDE 3/4" APA RATED ROOF SHEATHING ATTACHED TO EACH FRAMING MEMBER WITH 10dx3" COMMON NAILS AT 6" o/c AT EDGES AND 12" o/c IN THE FIELD. LOCATE NAILS 3/8" FROM ALL PANEL EDGES. SHEETS ARE TO BE LAID PERPENDICULAR TO ALL FRAMING MEMBERS. PROVIDE SIMPSON PCSA SHEATHING CLIPS AT UNSUPPORTED PANEL EDGES. -SHEAR WALL MARK SHEATHING SHALL BE STAGGERED 4'-0". —WOOD SPAN DIRECTION -WOOD FRAMING MARK 3. EXTERIOR WALLS ARE SHEATHED WITH 15/32" APA RATED SHEATHING ON THE EXTERIOR FACE. ATTACH TO WALL FRAMING WITH 10dx2-1/2" COMMON OR GALVANIZED BOX NAILS AT 6" o/c AT EDGES AND 12" o/c in the field. Where Walls are designated as shear WALLS, REFER TO SHEAR WALL SCHEDULE FOR ATTACHMENTS. SIDE(S) SHEATHING IS 4. REFER TO GENERAL NOTES AND SNOW DRIFT PLANS FOR ROOF LOADS. 5. REFER TO TYPICAL DETAILS FOR GABLE END WALL BRACING. 6. A MINIMUM 2x8 CONTINUOUS FASCIA SHALL BE ATTACHED TO THE ENDS OF ALL ROOF TRUSSES THAT OVERHANG WALLS. 7. CONTRACTOR IS RESPONSIBLE FOR COORDINATING SIZE OF OPENINGS WITH TRUSS FABRICATOR IF THEY DO NOT FIT BETWEEN TRUSSES. 8. ALL ROOF TOP EQUIPMENT (SIZE, LOCATION, ETC) SHALL BE VERIFIED WITH MECHANICAL AND ARCHITECT PRIOR TO PREPARATION OF SHOP DRAWINGS AND FABRICATION OF MATERIALS. CONTRACTOR SHALL COORDINATE CHANGES WITH SUPPLIER AND STRUCTURAL ENGINEER. MECHANICAL EQUIPMENT SHALL BEAR ON AT LEAST (2) FRAMING MEMBERS. 9. SHEAR WALLS ARE DESIGNATED AS "SW_" REFER TO SHEAR WALL SCHEDULE FOR ATTACHMENTS.

10. HEADERS ARE DESIGNATED "H_". REFER TO HEADER SCHEDULE. NUMBER OF PLIES ARE DESIGNATED IN PARENTHESIS. HEADERS OCCUR IN WALL FRAMING UNLESS NOTED

11. WOOD POSTS, COLUMNS OR MULTIPLE PLY STUDS ARE DESIGNATED AS "WP_". REFER TO HEADER SCHEDULE. ALL WOOD POSTS MUST LINE UP FROM FLOOR TO FLOOR TO LOWEST BEARING POINT. BETWEEN FLOORS, ADD VERTICAL BLOCKING OF SIZE TO ALLOW FOR FULL

2. STRONGBACK BRACING FOR TRUSSES SHALL BE PROVIDED FOR THE FULL-LENGTH OF

OTHERWISE.

BEARING OF VERTICAL ELEMENT.

BUILDING. REFER TO TRUSS ERECTION DRAWINGS.




MADISON / MILWAUKEE Tel: 414.255.4600



PROJECT

THE DECO EXTERIOR SPACE

7140 W. GREENFIELD WEST ALLIS, WISCONSIN

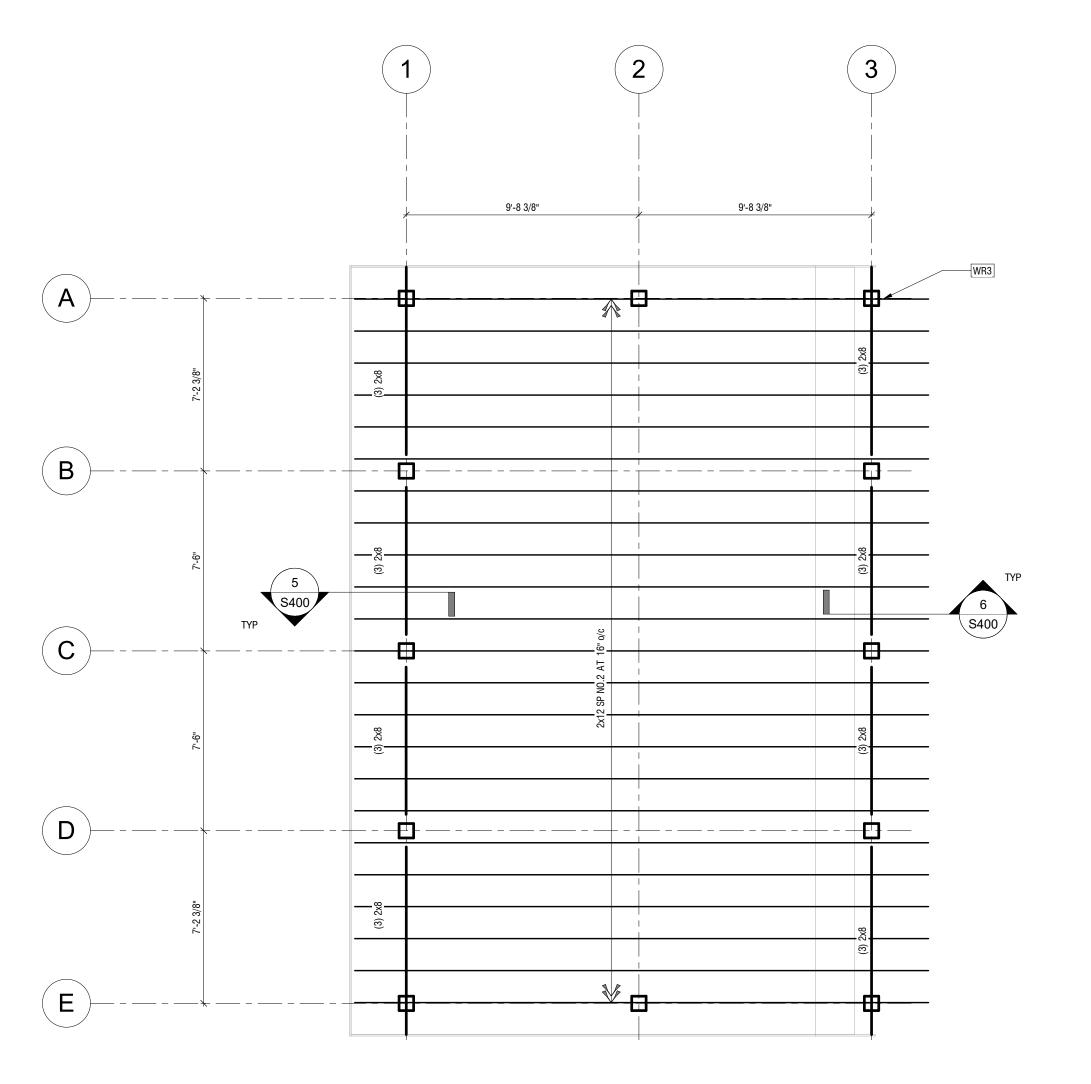

OWNER

WALLY HOLTZ


REVISIONS DESCRIPTION DATE

INFORMATION

PROJECT DESIGNER:	UTTECH DESIGN LL
PROJECT MANAGER:	Auth
PROJECT NUMBER:	23_100
ISSUED FOR:	SCHEMATIC DESIG
DATE:	01.12.2

SHEET

ROOF FRAMING PLAN

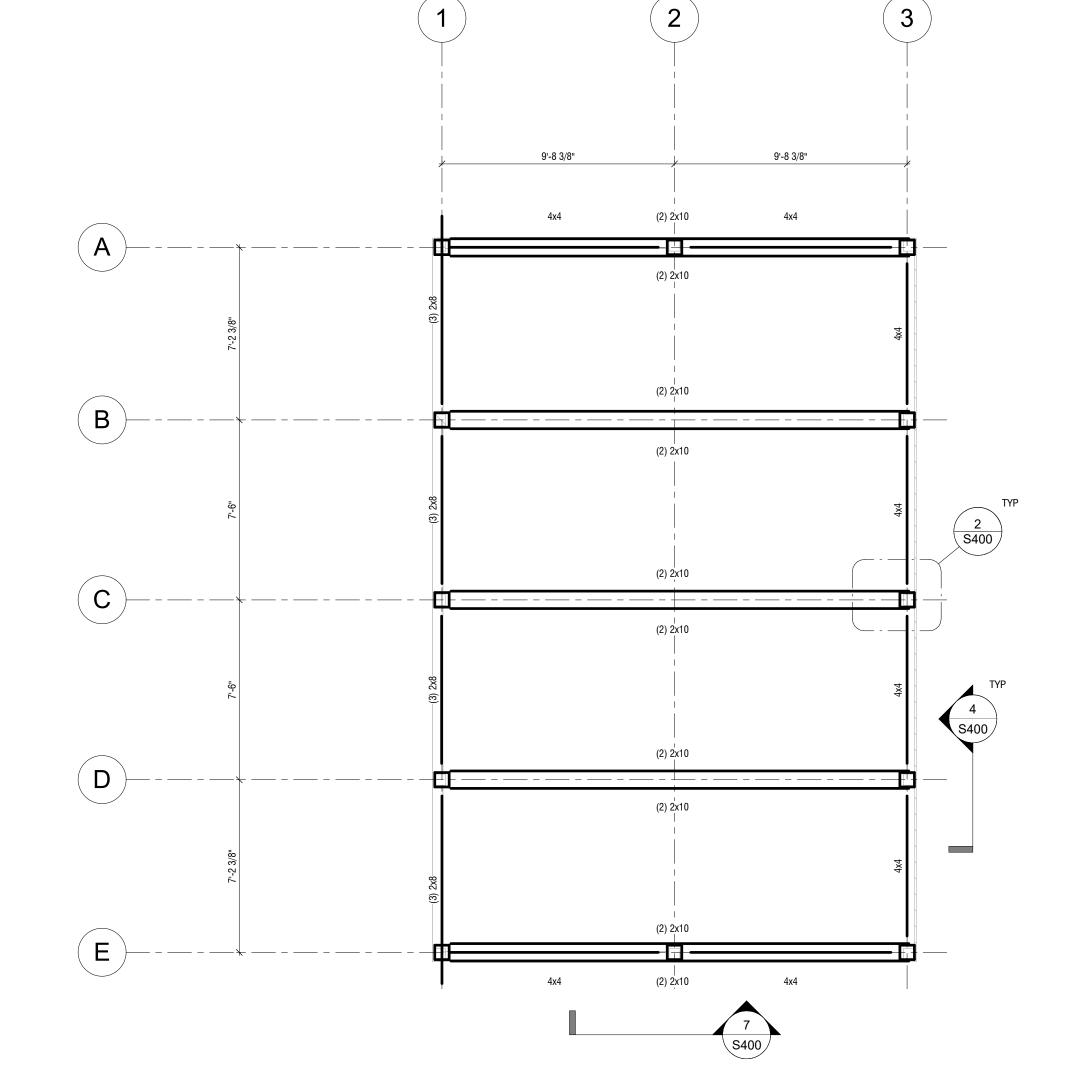

1 03-LOW ROOF BEARING PLAN S101 1/4" = 1'-0"






MADISON / MILWAUKEE Tel: 414.255.4600



PROJECT

THE DECO EXTERIOR SPACE

7140 W. GREENFIELD WEST ALLIS, WISCONSIN

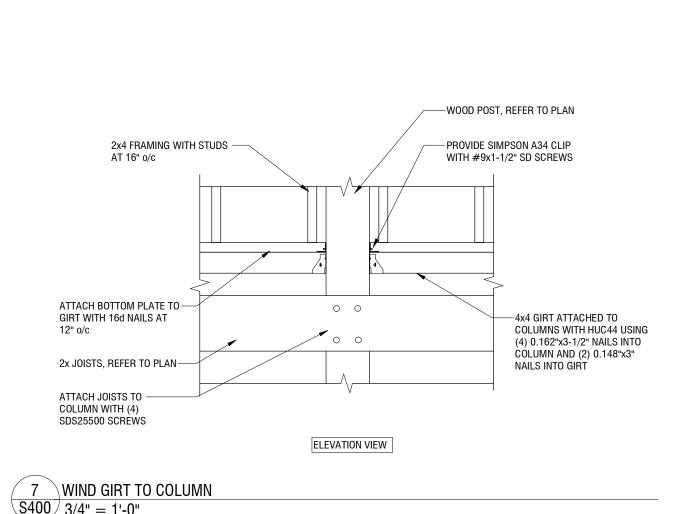

-4x4 GIRT ATTACHED TO COLUMNS WITH HUC44 USING

(4) 0.162"x3-1/2" NAILS INTO

-DOUBLE TOP PLATE. ATTACH

TO GIRT WITH (1) SDS25500

SCREWS AT 16" o/c

-DECKING, REFER TO

ARCHITECTURAL

-SIDING, REFER TO


ARCHITECTURAL


12" o/c.


-ATTACH BOTTOM PLATE TO HEADER WITH 16d NAILS AT

-HEADER, REFER TO PLAN

COLUMN AND (2) 0.148"x3" NAILS INTO GIRT. AT ENDS PROVIDE SIMPSON A34 CLIP WITH #9x1-1/2" SD SCREWS

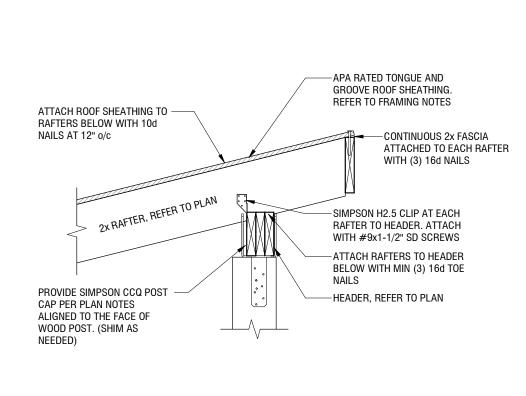

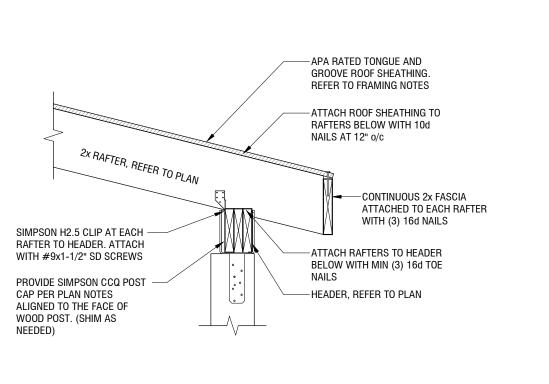

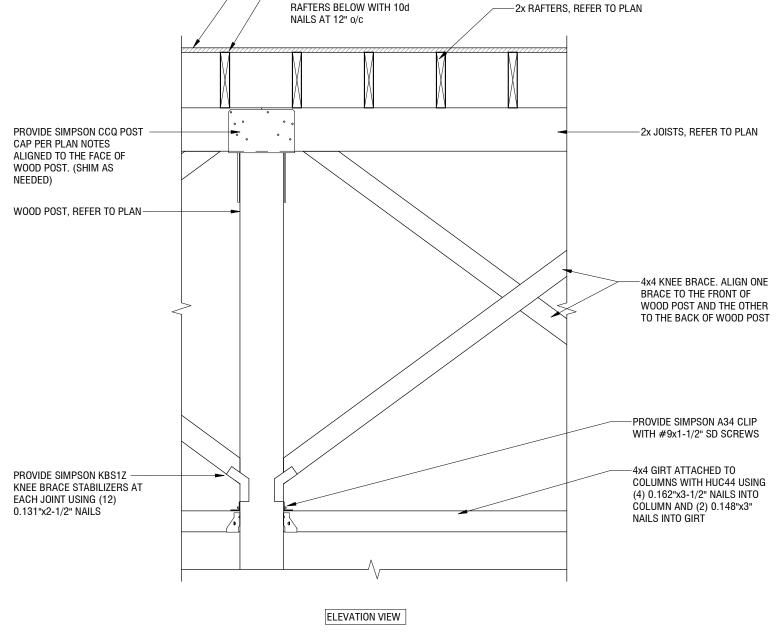

SOUTH POSTS

— APA RATED TONGUE AND GROOVE ROOF SHEATHING. REFER TO FRAMING NOTES —ATTACH ROOF SHEATHING TO




OWNER

WALLY HOLTZ

REVISIONS DESCRIPTION DATE





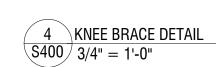



INFORMATION


PROJECT DESIGNER:	UTTECH DESIGN LLC
PROJECT MANAGER:	Autho
PROJECT NUMBER:	23_100
ISSUED FOR:	SCHEMATIC DESIGN
DATE:	01.12.2




STRUCTURAL DETAILS

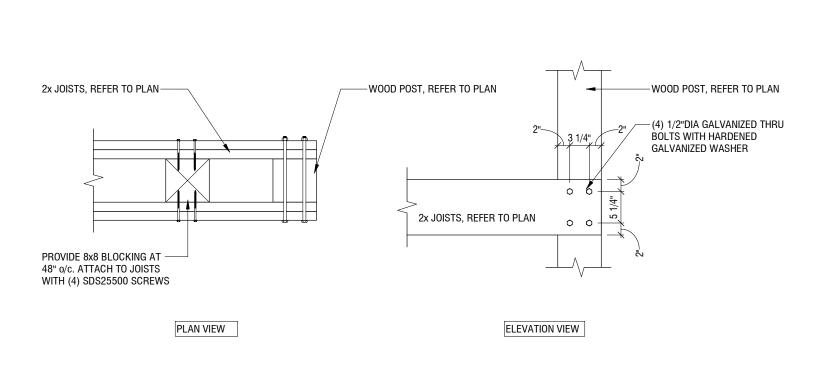

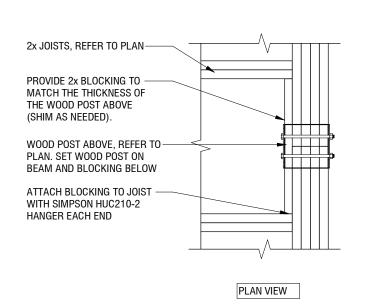

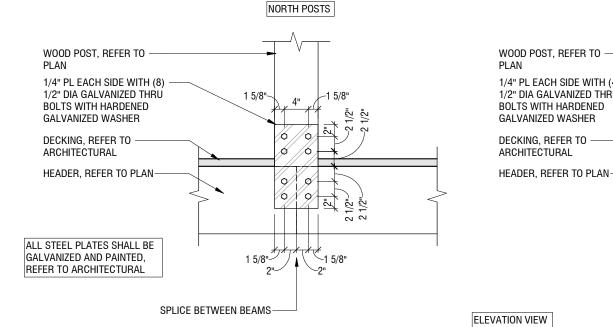

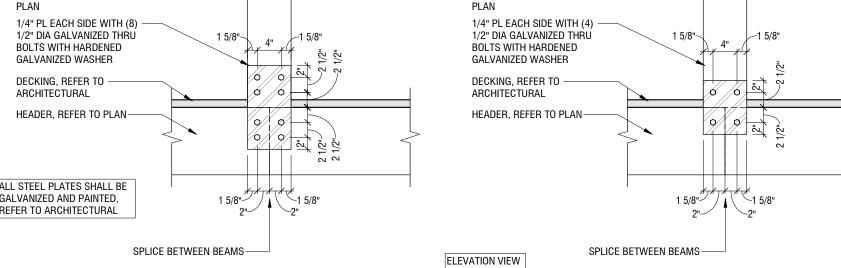

 $\begin{array}{c} 3 \\ \text{S400} \end{array} \begin{array}{c} \text{SECTION AT HALF WALL} \\ 3/4" = 1'\text{-}0" \end{array}$

105'-7"

2x4 FRAMING WITH STUDS AT 16" -

2x JOISTS, REFER TO PLAN

SIMPSON U210-2 (ZMAX) HANGER

AT EACH JOIST. INSTALL WITH

SIMPSON SD#9x1-1/2" SCREWS.

2 BEAM TO WOOD POST MOMENT FRAME CONNECTION

1 WOOD POST TO BEAM MOMENT CONNECTION S400 3/4" = 1'-0"



STAFF REPORT WEST ALLIS PLAN COMMISSION Wednesday, March 27, 2024 Common Council Chambers 6:00 PM

Watch: https://www.youtube.com/user/westalliscitychannel

10. Vacation and discontinuance of an improved alley between W. Lincoln Ave. and W. Grant St. and within the 2200 block of S. 108 St. and S. 109 St.

City Engineering has prepared a diagram requesting Common Council consideration to vacate a portion public alley Right of Way (RoW) between W. Lincoln Ave. and W. Grant St. and within the 2200 block of S. 108 St. and S. 109 St. The area is shown and legally described and identified as a map exhibit of the City of West Allis Engineering Department file no. Y-1205.

A resolution will introduce said request to the Common Council of the City of West Allis on April 16, 2024.

State Statutes require publishing a class 3 notice and personal service on abutting landowners at least 30 days before a public hearing or, if they can't be personally served, the notice needs to be mailed to them at least 30 days ahead of time. PUBLISH dates: April 19, 26, and May 3, 2024

Any abutting owner can object to discontinuance by filing a written objection; it would then take a 2/3 vote by the council to override that objection. Should the Council decide to vacate this portion of public right-of-way, the abutting property owners would receive an abutting portion of land, and that land would be taxable.

Purpose: The alley was recently improved with a Green Solutions grant via MMSD, and staff has sought sponsorship to vacate the alley way as it's in the public interest. A dead end alley that the city currently maintains, services (sanitation), and only one property owner directly uses for access to their garage. Other abutting properties include a gas station at 2208 S. 108 St. and residential property that has access off of W. Grant St. The introductory resolution is just Council authorizing us to conduct a public hearing, publish notice, and sharing the project for further consideration (the 3-page attachment shares the exhibit, proposed schedule, and area map).

Half of the alley width (10-ft) would be dedicated to abutters. The abutter benefiting the most would be the property located at 2208 S. 109 St. For years, this alley has served as the only means of accessing the detached garage behind their home. Once vacated, their half of the now improved alley would continue to serve their access needs. Abutters benefit with more land area, continued access on an improved surface, and the city benefits by vacating and thereby reducing its maintenance expense and gains some taxable value.

Engineering has reached out to abutters last year in advance of the alley improvement. All abutters will be notified of the vacation process and may object if they choose. One property owner has been non-responsive (2208 S 109 St.).

If the Common Council decides to vacate the right of way the city will record the document with the Milwaukee County register of deeds as part of the process. The lands if vacated will become taxable property.

Recommendation: Common Council approval of the vacation and discontinuance of an improved alley between W. Lincoln Ave. and W. Grant St. and within the 2200 block of S. 108 St. and S. 109 St.