

Staff Report West Allis Plan Commission Wednesday, June 26, 2024 6:00 PM

Room 128 - City Hall - 7525 W. Greenfield Ave.

Watch: https://www.youtube.com/user/westalliscitychannel

4. Revised Site, Landscaping, and Architectural Design Review for an accessory parking facility, at 9422-30 W. National Ave. submitted by John Fuchs and Nick Fuchs on behalf of Source One Enterprise LLC (Tax Key No. 479-0674-003).

Overview and Zoning


The property at 9422-30 W. National Avenue is currently an undeveloped 0.2-acre parcel (formerly a vacant multi-tenant commercial building) with W. National Ave. street frontage and access. The former 7,000-sf building was neglected and has since been removed (the applicant received site plan approval as part of their initial demolition plan). In February Plan Commission granted conditional approval to construct an accessory parking lot for the Heartbreakers bar & entertainment club. Estimated project cost is around \$200,000. This property is zoned a C-2 and accessory parking lots are allowed in the C-2 district (per sec. 19.33/accessory use table of the zoning ordinance). A certified Survey Map was subsequently approved in May by the Common Council as one of the pre-requisites to constructing a new parking lot. Tax Key 479-0676-004 at 9440 W National Ave., is owned by Source One Enterprise LLC, and tax key 479-0674-003, 9422-30 W. National Ave., is owned by the same (Source One Enterprises, LLC). Common ownership is necessary - Combining the lots would consolidate the two properties into one lot.

Revised Plans –The two lots will be combined via CSM once recorded with MKE Co. The revised plan still shows cross-access between the 9440 and 9422 site. Since changes are intended from what was approved by Plan Commission previously, the new plan is before Plan Commission for consideration.


City Engineering, Code Enforcement, and Planning staff met with the applicant's agent on site earlier this month to discuss a revised plan. The Plan revisions include changing the gradient of the property to match the east to the west. In other words, base material fill/soil will be added to increase the new



parking area pavement surface to match the existing level of pavement at the west side of the site

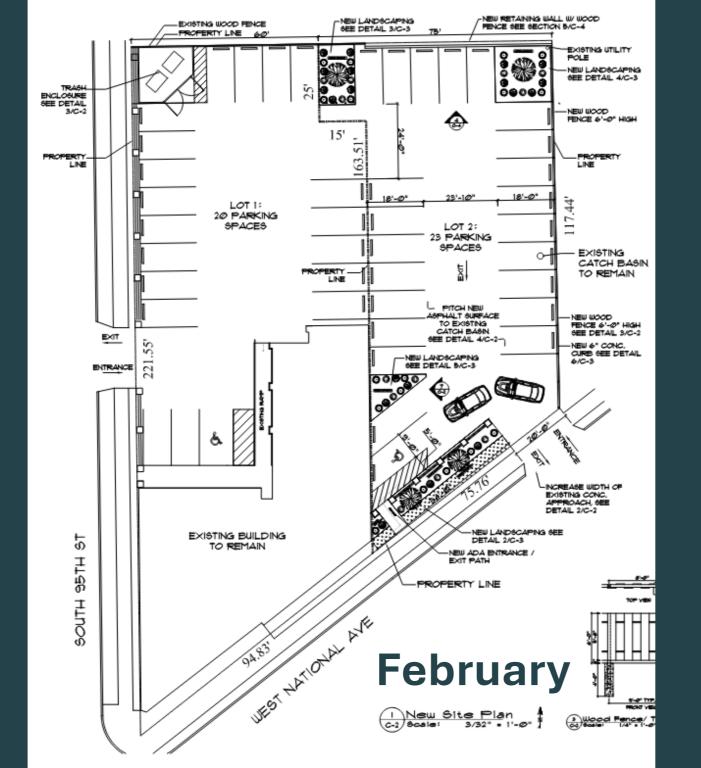



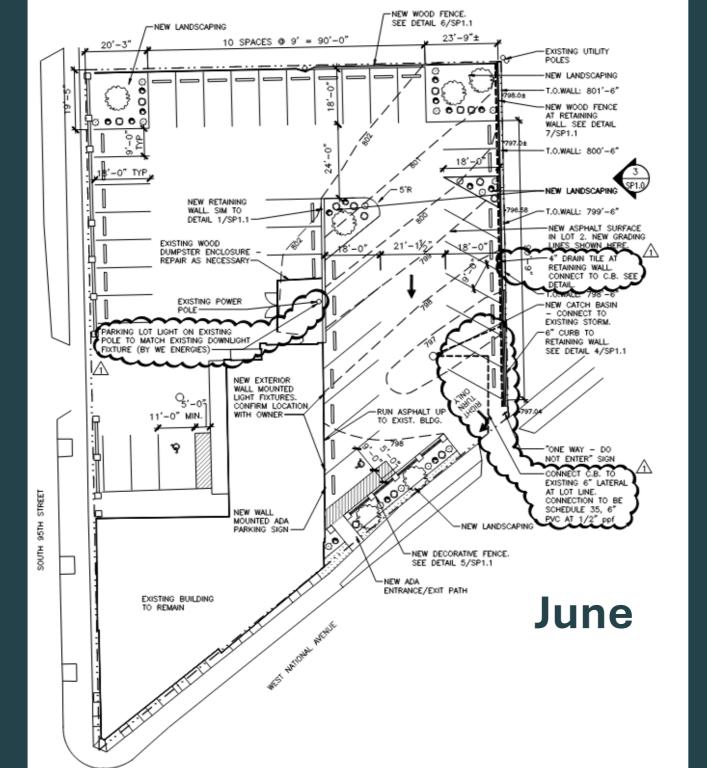



(9440 W. National Ave.). The fill will be graded to slope/drain from north to south. The added fill will eliminate the need for a retaining wall along the north property line as previously proposed.

A new retaining wall would instead be installed on the east side of the site along the abutting frontage with another commercial property owner. All stormwater runoff being captured on the south end of the site within a new catch basin.

Another change includes a revision to fencing/screening – New metal ornamental fencing with masonry piers would be installed along the W. National Ave. street frontage (south side of the site). Landscaping areas would also be installed in front of the new fence area as previously planned.

Along the north side of the property a new board on board wood fence would be installed to match the height of existing north fence (blending existing with new along the north side of the site).



On the east side of the site a new board on board wood fence would be installed along the top of the retaining wall, and gradually taper when nearing W. National Ave. maintaining vision angles for traffic exiting from the new parking area.



Recommendation: Approval of the revised Site, Landscaping, and Architectural plans are being prepared for an accessory parking facility, at 9422-30 W. National Ave. submitted by John

Fuchs and Nick Fuchs on behalf of Source One Enterprise LLC (Tax Key No. 479-0674-003), and subject to the following:

(Items to be completed prior to issuance of any building permits to construct a parking lot).

- 1. A revised Site and Architectural Plan being submitted to the Department of Development to show the following: (a) traffic pattern to be right out at National Avenue driveway. Driveway modifications and directional signage per City Engineer (no left turns in/out); (b) exterior building wall details (Heartbreakers bldg); (c) retaining wall and drainage plan being review by Engineering Department (d) eliminate the last parking stall near W. National Ave. on SE corner of property. Contact Steve Schaer, Manager of Planning and Zoning at 414-302-8466.
- 2. Exterior lighting plan (location and fixture type).
- 3. Exterior brick details being (samples) submitted for consideration to repair the east wall of the building. Contact Steve Schaer, Manager of Planning and Zoning at 414-302-8466.
- 4. A <u>Street excavation permit</u> being applied for in OpenGov prior to work beginning. Any concrete work in the street right of way needs to be completed by a licensed and pre-qualified contractor within the City of West Allis. Contact Greg Bartelme at (414) 302-8367.

NEW PARKING LOT - SITE

9440 W. NATIONAL AVE. | WEST ALLIS, WI 53227

SHEET INDEX					
SHEET	DESCRIPTION				
T1.0	TITLE AND CODE SHEET				
	ARCHITECTURAL				
SP1.0	DEMO SITE PLAN, SITE PLAN				
SP1.1	SITE DETAILS				
	PLUMBING, MECHANICAL AND ELECTRICAL PLANS TO BE A DEFERRED REVIEW AND SUBMITTAL BY DESIGN-BUILD CONTRACTOR.				
PROJECT NOTES					
ELECTRICAL NOTES: 1) ALL WORK TO BE BY DESIGN-BUILD ELECTRICAL CONTRACTOR. HVAC NOTES: 1) ALL WORK TO BE BY DESIGN-BUILD HVAC CONTRACTOR. PLUMBING NOTES: 1) ALL WORK TO BE BY DESIGN-BUILD PLUMBING CONTRACTOR.					

BUILD	ING CODE SUMMARY
BASED ON THE:	WISCONSIN COMMERCIAL BUILDING CODE (2015 INTERNATIONAL BUILDING CODE w/WI AMENDMENTS)
	2009 ANSI A117.1 ACCESSIBILITY CODE
	ALL OTHER CODES AND ORDINANCES AS REFERENCED BY THE ABOVE CODES.
AREA OF ALTERATION:	
FIRE ALARM:	
OCCUPANCY:	
OCCUPANCY SEPARATION:	
CONSTRUCTION TYPE:	
SPRINKLER SYSTEM:	
NUMBER OF STORIES:	
ALTERATION LEVEL:	
FLAME SPREAD & SMOKE INDEX:	
CODE EXCEPTION:	NONE

PROJE	ECT CONTACT INFO
OWNER: MILWAUKEE ENTERTAINMENT LLC 13500 WATERTOWN PLANK RD, STE 100 ELM GROVE, WI 53122 P: ###-#################################	ARCHITECT: THRIVE ARCHITECTS 259 SOUTH STREET, SUITE A WAUKESHA, WI 53186 P: 833-380-6180 PROJECT MANAGER: JEFF STOWE
	ATTN: JEREMY BARTLETT, ARCHITECT OF RECORD

ICC A117.1-2009 - CHAPTER 5, GENERAL SITE & BUILDING ELEMENTS

502.2, ACCESSIBLE PARKING SPACES FOR CARS SHALL BE 96" WIDE MINIMUM, VAN PARKING SPACES SHALL BE 132" WIDE MINIMUM 502.4, ACCESS AISLE TO BE ADJACENT TO CAR AND VAN PARKING SPACES

502.4.2, ACCESS AISLES SERVING CAR AND VAN PARKING SPACES SHALL BE 60" WIDE MINIMUM.


502.4.4, ACCESS AISLES SHALL BE MARKED TO DISCOURAGE PARKING IN THEM.

GENERAL NOTES


- CONSTRUCTION IS TO BE IN COMPLIANCE WITH ALL GOVERNING CODES, ORDINANCES & STANDARDS. THE CONTRACTOR(S) SHALL BE RESPONSIBLE FOR INITIATING, MAINTAINING, & SUPERVISING ALL SAFETY PRECAUTIONS & PROGRAMS IN CONNECTION WITH THE PERFORMANCE OF THIS PROJECT. ARCHITECT/DESIGNER SHALL NOT BE RESPONSIBLE FOR ANY COST, SCHEDULE OR CONSTRUCTION ISSUES ARISING
- DUE GC/OWNERS FAILURE TO DISTRIBUTE ALL DOCS. SUBCONTRACTORS & SUPPLIERS SHOULD ENDEAVOR TO REVIEW A COMPLETE SET OF DOCS BEFORE BIDDING, FABRICATING & INSTALL. GC, SUBCONTRACTORS, MATERIAL SUPPLIERS, OWNER, ETC. MUST NOTIFY ARCHITECT OF ANY ERRORS, OMISSIONS, OF DEFECTS IN THE CONSTRUCTION DOCUMENTS PRIOR TO BIDDING, FABRICATING OR INSTALLING WORK.
- SITE DIMENSIONS ARE TO BE FIELD VERIFIED AND ADJUSTED ACCORDINGLY. THE ARCHITECT/DESIGNER SHALL BE NOTIFIED OF ANY VARIANCES BEFORE CONTRACTOR BEGINS OR PROCEEDS WORK. MECH, ELEC, PLUMB & FIRE PROTECTION ARE TO BE DESIGN BUILT, COMPLYING WITH ALL GOVERNING CODES,
- STANDARDS, WHICH WILL BE THE FULL RESPONSIBILITY OF THE CONTRACTOR; THE ARCHITECT ALL MECH, ELEC, PLUMB & FIRE PROTECTION SYSTEMS/EQUIP. SHALL BE MAINTAINED ACCORDING TO
- MANUFACTURER'S STANDARDS. BLDG. OWNER SHALL ASSUME FULL RESPONSIBILITY FOR MAINTANANCE/OPPERATION THE INSTALLATION AND EXECUTION OF ALL MATERIALS SHALL BE IN ACCORDANCE WITH THE MANUFACTURER'S

STANDARDS AND SPECIFICATIONS. ALL MEANS & METHODS OF CONSTRUCTION TO BE THE SOLE RESPONSIBILITY OF

- PORTABLE FIRE EXTINGUISHERS SHALL BE PROVIDED IN OCCUPANCIES AND LOCATIONS AS REQUIRED BY THE INTERNATIONAL FIRE CODE. INSTALLATION LOCATIONS SHALL HAVE A MAXIMUM TRAVEL DISTANCE OF 75' TO ANY EXTINGUISHER. EXTINGUISHERS SHALL BE LOCATED IN CONSPICUOUS LOCATIONS WERE THEY WILL BE READILY ACCESSIBLE AND IMMEDIATELY AVAILABLE FOR USE, TYPICALLY ALONG PATHS OF TRAVEL. EXTINGUISHERS SHALL NOT BE OBSTRUCTED FROM VIEW, IF VISUAL OBSTRUCTION CAN NOT BE AVOIDED ANOTHER MEANS SHALL BE PROVIDED TO INDICATE THE EXTINGUISHER LOCATIONS. EXTINGUISHERS NOT EXCEEDING 40" SHALL BE INSTALLED SO THAT ITS TOP IS NOT MORE THAT 5'-0" ABOVE THE FLOOR, EXTINGUISHERS EXCEEDING 40" SHALL BE INSTALLED SO THAT ITS TOP IS NOT MORE THAN 3'-6" ABOVE THE FLOOR. THE CLEARANCE BETWEEN THE FLOOR AND BOTTOM OF HAND HELD UNITS SHALL NOT BE LESS THAN 4". VERIFY EXTINGUISHER LOCATIONS W/ LOCAL FIRE DEPT. & OWNER PRIOR TO INSTALLATION.
- ALL CONCRETE FLAT WORK MUST BE WET CURED PER ACI REQUIREMENTS AND/OR CURED USING A CURING COMPOUND. REFER TO STRUCTURAL NOTES FOR CURING COMPOUND SPECS. CONTRACTOR IS RESPONSIBLE FOR APPLYING CURING COMPOUNDS PER THE MANUFACTURER'S REQUIREMENTS.

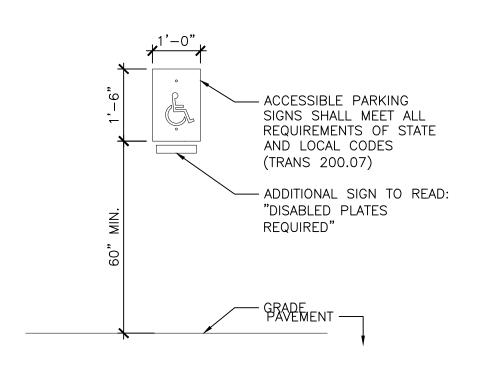


ACCESSIBLE PARKING SIGN SCALE: 1/2"=1'-0" (22x34); 1/4"=1'-0" (11x17

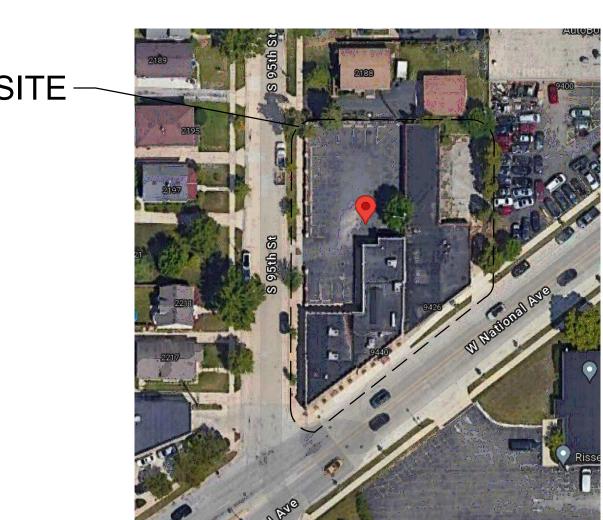

VICINITY MAP SCALE: N.T.S.



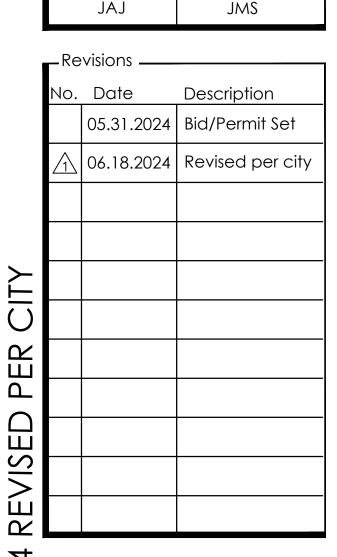

Drawn by

JAJ

Checked by

259 South Street, Suite A WAUKESHA, WI 53186

Project Info. — 24066 -

New Parking Lot

9440 W National Ave

−Sheet Title −−−−

West Allis, WI

p: 833-380-6180

TYPICAL	ABBREVIATIONS

ABV: Above	B/O: By Others	DW: Dishwasher
ACOUS: Acoustical	BO: Bottom Of	DIV: Division
ADDL: Additional	BR: Bedroom	DR: Door
ADH: Adhesive	2 235.35	DH: Double Hung
ADJ: Adjustable	CAB: Cabinet	DS: Downspout
AFF: Above Finish Floor	CALC: Calculation	DRWR: Drawer
AGG: Aggregate	CD: Cabinet Door	DT: Drain Tile
AHJ: Authority Having	CG: Corner Guard	DWG: Drawing
Jurisdiction	CIP: Cast-In-Place	D: Nail Size
A/C: Air Conditioning	(Concrete)	
ALT: Alternate	CL: Centerline	EW: Each Way
ALUM: Aluminum	CO: Clean Out	E: East
ANC: Anchor, Anchorage	CONTR: Contract (or)	EL: Elevation
AB: Anchor Bolt	COORD: Coordinate	ELEV: Elevation
ANOD: Anodized	CRPT: Carpet	EQ: Equal
APX: Approximate	CIP: cast—in—place	EQP: Equipment
APT: Apartment	CLK: Caulking	EXCV: Excavate
ARCH: Architect	CAS: Casement	EXH: Exhaust
(architectural)	CB: Catch Basin	EXIST: Existing
ASPH: Asphalt	CLG: Ceiling	EXT: Exterior
AUTO: Automatic	CT: Ceramic Tile	
AVE: Avenue	CIR: Circle	FOC: Face of Concrete
AVR: Average	CLR: Clear	FOF: Face of Finish
AWN: Awning	COL: Column	FOM: Face of Masonry
7g	CONC: Concrete	FOS: Face of Studs
BSMT: Basement	CMU: Concrete Masonry	FOW: Face of Wall
BM: Beam	Unit	FBD: Fiberboard
BVL: Beveled	CONST: CONSTruction	FCB: Fiber Cement Board
BITUM: Bituminous	CONT: Continuous	FGL: Fiberglass
BLK: Block	CJT: Control Joint	FIN: Finish
BLKG: Blocking	CORR: Corrugated	FFE: Finished Floor Elevation
BLW: Below	CUFT: Cubic Foot	FA: Fire Alarm
BLDV: Boulevard	CUYD: Cubic Yard	FE: Fire Extinguisher
BTW: Between	COTD. Cubic Turu	FPL: Fireplace
BD: Board	DP: Dampproofing	FLSH: Flashing
BOT: Bottom	DTL: Detail	FLR: Floor
BLDG: Building	DIA: Diameter	FLOR: Fluorescent
BUR: Built Up Roofing	DIM: Diameter	FT: Foot, Feet
Dank op Rooming	DIM: DILIGISION	•

FND: Foundation FRM: Fram(d), (ing) FBO: Furnished by Others FUR: Furred GL: Glass, Glazing GI: Galvanized Iron GLBK: Glass Block GLB: Glue Laminated Bea GT: Grout GRD: Grade, Grading GWB: Gypsum Wall Board HWD: Hardware HDR: Header HTG: Heating HVAC: Heating, Ventilation-Air Conditioning

HT: Height

HC: Hollow Core

HOR: Horizontal

HB: Hose Bib

INCL: Include

INS: Insulate

INV: Invert

KD: Kiln Dried

KIT: Kitchen

ID: Inside Diameter

LOA: Length Overall LF: Lineal Feet LL: Live Load LVL: Laminated Veneer MFR: Manufacturer MO: Masonry Opening MAX: Maximum MAS: Masonry MECH: Mechanic(al) MC: Medicine Cabinet MDF: Medium Density Fiberboard MDO: Medium Density Overlay MTL: Metal MWK: Millwork MISC: Miscellaneous MOD: Module MLD: Moulding NOM: Nominal

NIC: Not in Contract

NTS: Not To Scale

LB: Pound

LAM: Laminate(d)

LH: Left Hand

NO, #: Number O: Non-Operable Window OBS: Obscure DC: On Center DP: Opaque OSB: Orientated Strand Board OD: Outside Diameter PBD: Particle Board PRT: partition PVMT: Pavement

PH: Toilet Paper Hanger

RFL: Reflect(ed),(ive),(or)

QT: Quarry Tile

REF: Reference

RAD: Radius

RE: Reinforced REQ'D: Required RA: Return Air REV: Revision RD: Rod R&S: Rod and Shelf RM: Room RO: Rough Opening SCH: Schedule SCN: Screen SECT: Section PERF: Perforate(d) SGD: Sliding Glass Door PLAS: Plaster SHTH: Sheathing PLAM: Plastic Laminate SHT: Sheet PLT: Plate SH: Shelf, Shelving PLYWD: Plywood PCC: Precast Concrete SKL: Skylight PCF: Pounds Per Cubic Foot PLF: Pounds Per Linear Foot SLB: Slab PSF: Pounds Per Square SLD: Slider(ing) SPEC: Specification PSI: Pounds Per Square Inch PBF: Prefabricated STD: Standard PRF: Preformed STV: Stove PT: Pressure Treated

STL: Steel SA: Supply Air SC: Solid Core SW: Shear Wall SS: Stainless Steel SYS: System TEL: Telephone

REG: Register


T/0: Top of TOC: Top of Concrete TOW: Top of Wall TS: Tubular Steel TYP: Typical UL: Underwriters Laboratory UNF: Unfinished UNO: Unless Noted Otherwise VB: Vapor Barrier VAR: Varnish VIF: Verify In Field VRN: Veneer VERT: Vertical VG: Vertical Grain VIN: Vinyl Sheet WL: Wall WC: Water Closet WH: Water Heater

TEMP: Tempered

T&G: Tongue and Groove

WR: Weather Resistant WRB: Weather Resistive WWF: Welded Wire Fabric WWM: Welded Wire Mesh W: West WIN: Window W/O: Without W/: With

WD: Wood X: Operable Window Section

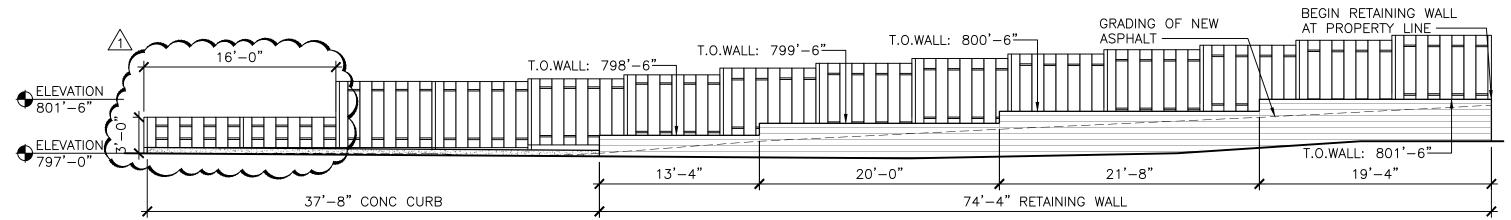

LANDSCAPE LEGEND				
SYMBOL	QTY	BOTANIC NAME	COMMON NAME	SIZE
ΑО	15	BERBERIS THUNBERGII 'ATROPURPUREA'	RED BARBERRY	24"
в 🌣	15	SPIRAEA JAPONICA	GOLDFLAME SPIREA	24"
СО	13	BERBERIS THUNBERGII 'AUREA'	GOLDEN BARBERRY	24"
D	6	GINKO BILOBA	GINKGO	8 FT.
Janes S.				

-NEW LANDSCAPING

NEW RETAINING WALL. SIM TO DETAIL 1/SP1.1

EXISTING WOOD DUMPSTER ENCLOSURE — REPAIR AS NECESSARY—

EXISTING POWER POLE

NEW EXTERIOR
WALL MOUNTED
LIGHT FIXTURES.
CONFIRM LOCATION
WITH OWNER

NEW WALL
MOUNTED ADA
PARKING SIGN

PARKING LOT LIGHT ON EXISTING
POLE TO MATCH EXISTING DOWNLIGHT

FIXTURE (BY WE ENERGIES)

11'-0" MIN.

EXISTING BUILDING TO REMAIN

20'-3"

10 SPACES @ 9' = 90'-0"

ZONED C-2 SITE SF: 22,379 SF
GREEN SPACE CALCULATIONS GREEN SPACE PROVIDED: 1,534 SF
6.85% OF SITE IS GREEN SPACE
PARKING CALCULATIONS 38 PARKING STALLS PROVIDED, INCLUDING (2) ADA STALLS

NEW WOOD FENCE.
SEE DETAIL 6/SP1.1

RUN ASPHALT UP TO EXIST. BLDG.

─NEW ADA

ENTRANCE/EXIT PATH

NEW DECORATIVE FENCE. SEE DETAIL 5/SP1.1

23'-9"±

-EXISTING UTILITY POLES

NEW LANDSCAPINGT.O.WALL: 801'-6"

- NEW WOOD FENCE AT RETAINING

WALL. SEE DETAIL

— T.O.WALL: 800'-6"

- NEW LANDSCAPING

NEW ASPHALT SURFACE
IN LOT 2. NEW GRADING
LINES SHOWN HERE.

4" DRAIN TILE AT

-NEW CATCH BASIN

RETAINING WALL. SEE DETAIL 4/SP1.1

"ONE WAY - DO
NOT ENTER" SIGN

CONNECT C.B. TO
EXISTING 6" LATERAL
AT LOT LINE.
CONNECTION TO BE
SCHEDULE 35, 6"
PVC AT 1/2" ppf

- CONNECT TO EXISTING STORM.


∕-6" CURB TO

RETAINING WALL. CONNECT TO C.B. SEE

796.<mark>58 T.O.WALL: 799'-6"</mark>

7/SP1.1

RETAINING WALL/FENCE ELEVATION	7
SCALE: 1/8"=1'-0" (22x34); 1/16"=1'-0" (11x17)	$\bigcup_{i=1}^{n}$

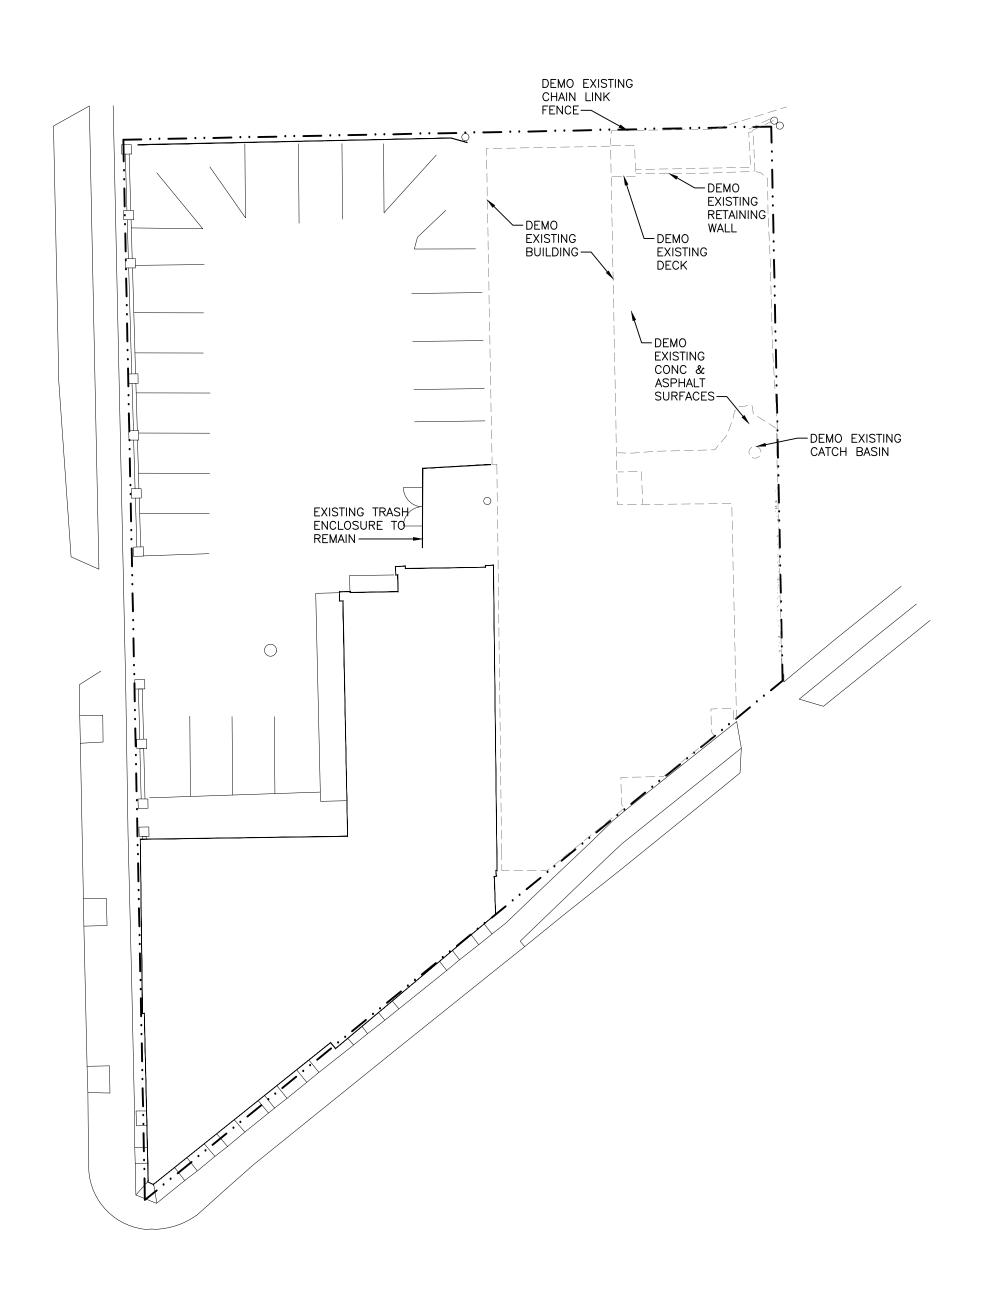



259 South Street, Suite A WAUKESHA, WI 53186 p: 833-380-6180

Project Info. — 24066 — New Parking Lot

9440 W National Ave West Allis, WI

—Sheet Title ———

Site

DEMO SITE PLAN, SITE PLAN


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	Drawn by	Checked by
	JAJ	JMS

Sheet No.
SP1.0

SITE PLAN

SCALE: 1"=20'-0" (22x34); 1"=40'-0" (11x17)



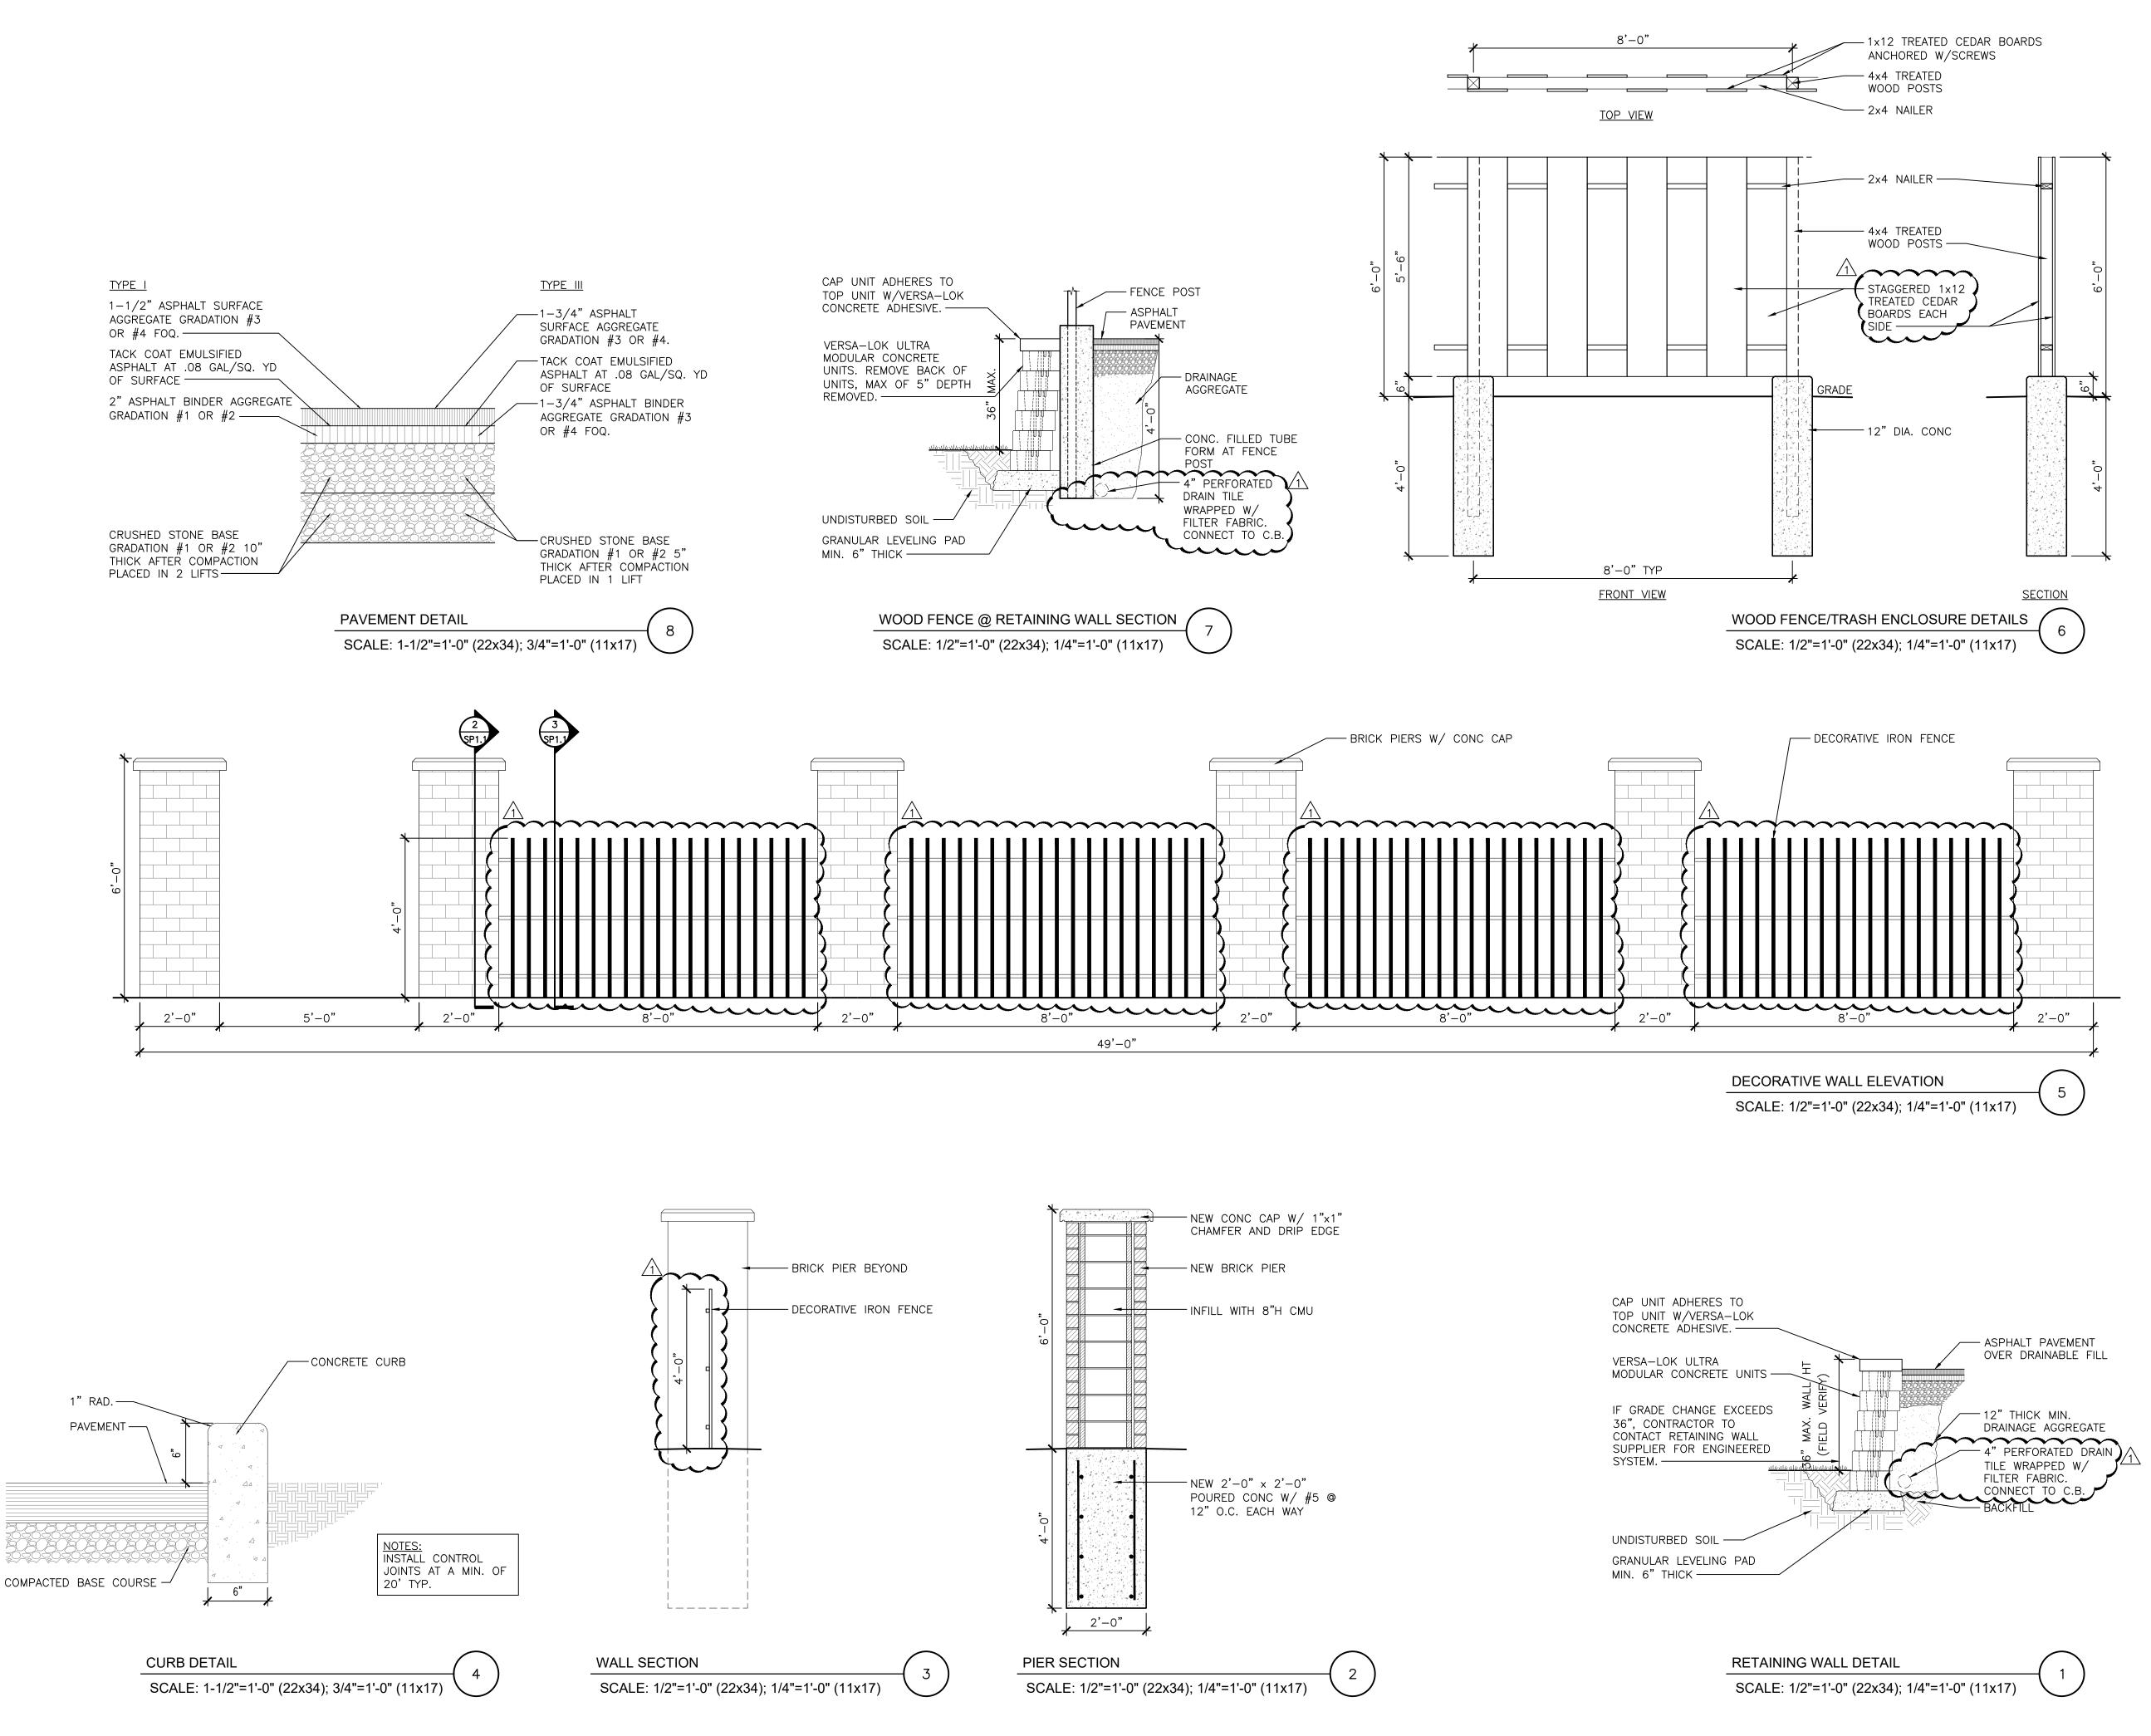

THR VE ARCH TECTS

Architect

259 South Street, Suite A WAUKESHA, WI 53186 p: 833-380-6180

PProject Info. — 24066 —

New Parking Lot

Site

9440 W National Ave West Allis, WI

—Sheet Title

SITE DETAILS

Drawn by	Checked by
JAJ	JMS

1	_ Re	visions ——	
	No.	Date	Description
		05.31.2024	Bid/Permit Set
	\triangle	06.18.2024	Revised per city
\perp			
$\overline{\mathbf{O}}$			
PER CITY			
REVISED			
VIS			
SE)			
4			

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06-18-